
# CITY OF MERCER ISLAND 2021 WATER SYSTEM IMPROVEMENTS PROJECT



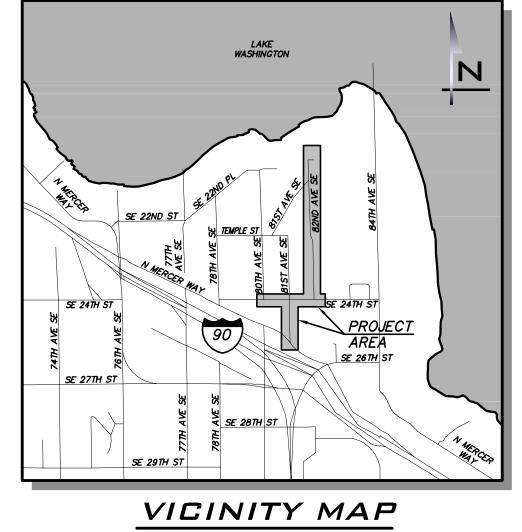



### SHEET INDEX

DT-04

COVER SHEET GN-01 KEY MAP & ALIGNMENT PLAN GN-02 GENERAL NOTES & LEGEND WATER SERVICE TABLE GN-03 EXISTING CONDITIONS & TESC PLAN - SE 24TH ST EXISTING CONDITIONS & TESC PLAN - 82ND AVE SE EXISTING CONDITIONS & TESC PLAN - 82ND AVE SE EC-03 EXISTING CONDITIONS & TESC PLAN - 81ST AVE SE CONTRACTOR PAID POTHOLING PLAN WATER PLAN - SE 24TH ST WATER PLAN - SE 24TH ST WATER PLAN - SE 24TH ST WATER PLAN - 82ND AVE SE WA-D5 WATER PLAN - 82ND AVE SE WA-06 WATER PLAN - 82ND AVE SE WA-07 WATER PLAN - 82ND AVE SE WATER PLAN - 81ST AVE SE WA-09 WATER PLAN - 81ST AVE SE ROAD RESTORATION PLAN - SE 24TH ST

RR-02 ROAD RESTORATION PLAN - 82ND AVE SE ROAD RESTORATION PLAN - 82ND AVE SE RR-04 ROAD RESTORATION PLAN - 81ST AVE SE DT-0 1 STANDARD WATER DETAILS DT-02 STANDARD WATER DETAILS DT-03 STANDARD WATER DETAILS

STANDARD DETAILS



### CIVIL ENGINEER

DEANNA MARTIN, PE BLUELINE 25 CENTRAL WAY, SUITE 400 KIRKLAND, WA 98033 (425) 250-7239 DMARTIN@THEBLUELINEGROUP.COM

### SURVEYOR

TRAVIS BRADLEY, PLS AXIS SURVEY & MAPPING 15241 NE 90TH ST REDMOND, WA 98052 (425) 823-5700 x316 TRAVIS@AXISMAP.COM


### CITY CONTACT


PROJECT MANAGER RONA LIN, PE CITY OF MERCER ISLAND

UTILITIES ENGINEER 9611 SE 36TH ST MERCER ISLAND, WA 98040 (206) 275-7806 RONA.LIN@MERCERGOV.ORG

### EXISTING UTILITY NOTE

EXISTING UTILITIES ARE SHOWN IN THE APPROXIMATE LOCATION. THERE IS NO GUARANTEE THAT ALL UTILITY LINES ARE SHOWN, OR THAT THE LOCATION, SIZE AND MATERIAL IS ACCURATE. THE CONTRACTOR SHALL UNCOVER ALL INDICATED PIPING WHERE CROSSING, INTERFERENCES, OR CONNECTIONS OCCUR PRIOR TO TRENCHING OR EXCAVATION FOR ANY PIPE OR STRUCTURES, TO DETERMINE ACTUAL LOCATIONS, SIZE AND MATERIAL. THE CONTRACTOR SHALL MAKE THE APPROPRIATE PROVISION FOR PROTECTION OF SAID FACILITIES. THE CONTRACTOR SHALL NOTIFY ONE CALL AT 8-1-1 (WASHINGTON811.COM) AND ARRANGE FOR FIELD LOCATION OF EXISTING FACILITIES BEFORE CONSTRUCTION.

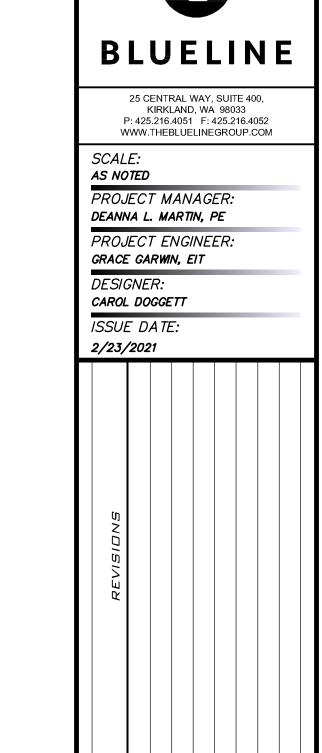

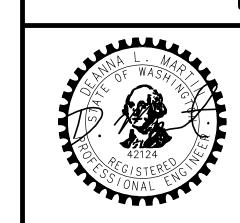

2/23/21

20-286 SHEET NAME:

**CV-D** 1

### DATUM

HORIZONTAL DATUM:

NAD '83/'11 PER GPS HXGN SMARTNET AS VERIFIED TO CITY OF MERCER ISLAND MONUMENT

VERTICAL DATUM: NAVD '88 PER GPS HXGN SMARTNET AS VERIFIED TO CITY OF MERCER ISLAND MONUMENT

CITY OF MERCER ISLAND MONUMENT '8388'. FOUND INVERTED NAIL IN CONC. MONUMENT IN CASE, 0.6' BELOW RIM, LOCATED AT THE INTERSECTION OF SE 24TH ST & 81ST AVE SE.

### TEMPORARY BENCHMARKS

TBM 'A'
SET A RAILROAD SPIKE IN THE NORTHWEST FACE OF UTILITY POLE WITH UNDERGROUND
CONDUIT LOCATED AT THE NORTHEAST QUADRANT OF THE INTERSECTION OF SE 24TH ST & 81ST AVE SE., 0.5' ABOVE GRADE.

AT NAIL IN CONCRETE IN MONUMENT CASE, 0.6' BELOW RIM, LOCATED AT THE INTERSECTION OF THE CENTERLINES FOR 81ST AVE SE & N. MERCER WAY.

### SURVEY NOTES

GIS PARCEL NOTE: PARCEL LINES AS SHOWN ARE FROM KING COUNTY GIS INFORMATION. NOTE THAT IT IS ONLY A SCHEMATIC REPRESENTATION FOR CONVENIENCE IN INTERPRETING THE TOPOGRAPHY. IT IS NOT A BOUNDARY SURVEY AND SHOULD NOT BE RELIED ON AS

PRIMARY CONTROL POINTS AND ACCESSIBLE MONUMENT POSITIONS WERE FIELD MEASURED UTILIZING GLOBAL POSITIONING SYSTEM (GPS) SURVEY TECHNIQUES USING LEICA GS14 GPS/GNSS EQUIPMENT. MONUMENT POSITIONS THAT WERE NOT DIRECTLY OBSERVED USING GPS SURVEY TECHNIQUES WERE TIED INTO THE CONTROL POINTS UTILIZING LEICA ELECTRONIC TS16 TOTAL STATIONS FOR THE MEASUREMENT OF BOTH ANGLES AND DISTANCES. THIS SURVEY MEETS OR EXCEEDS THE STANDARDS SET BY WACS 332-130-080/090.

THE INFORMATION DEPICTED ON THIS MAP REPRESENTS THE RESULTS OF A SURVEY MADE ON SEPTEMBER 23, 2020 AND CAN ONLY BE CONSIDERED AS INDICATING THE GENERAL CONDITIONS EXISTING AT THAT TIME.

UTILITY LOCATIONS SHOWN HEREON ARE BASED UPON ASBUILT FIELD LOCATION OF EXISTING STRUCTURES. FIELD LOCATION OF UTILITIES BASED ON LOCATOR PAINT MARKINGS AND LOCATIONS BASED ON UTILITY MAPS FROM CITY AND UTILITY DRAWINGS INDICATING REPORTED UTILITY INSTALLATIONS. OTHER UTILITIES MAY EXIST. NO SUB-SURFACE EXPLORATION WAS MADE TO VERIFY UTILITY ROUTINGS AND THE ROUTING OF ALL BURIED UTILITIES SHOULD BE CONFIRMED WITH THE UTILITY PURVEYOR AND EXPOSED IN AREAS CRITICAL TO DESIGN FOR VERIFICATION.

2' CONTOURS INTERVAL DERIVED FROM DIRECT FIELD OBSERVATION.

THIS SURVEY MEETS UNITED STATES NATIONAL MAP ACCURACY STANDARDS FOR VERTICAL ACCURACY OF ONE HALF THE CONTOUR INTERVAL.

### 82ND AVE SE

### DATUM

NAD '83/'11 PER GPS HXGN SMARTNET AS VERIFIED TO CITY OF MERCER ISLAND MONUMENT

NAVD '88 PER GPS HXGN SMARTNET AS VERIFIED TO CITY OF MERCER ISLAND MONUMENT

ORIGINATING BENCHMARK:

ORIGINATING BENCHMARK: CITY OF MERCER ISLAND MONUMENT '8388'. FOUND INVERTED NAIL IN CONC. MONUMENT IN CASE, 0.6' BELOW RIM, LOCATED AT THE INTERSECTION OF SE 24TH ST & 81ST AVE SE.

### TEMPORARY BENCHMARKS

TBM 'A'
SET A RAILROAD SPIKE IN THE NORTHWEST FACE OF UTILITY POLE WITH UNDERGROUND
CONDUIT LOCATED AT THE NORTHEAST QUADRANT OF THE INTERSECTION OF SE 24TH ST & 81ST AVE SE., 0.5' ABOVE GRADE.

SET CHISELED SQUARE AT THE NORTHWEST CORNER CONCRETE PAD FOR POWER TRANSFORMER LOCATED ON THE EASTERLY SIDE OF 82ND AVE SE, ± AT THE NORTHWESTERLY CORNER OF PARCEL FOR HOUSE NO. 2060. ELEVATION: 165.41'

TBM 'C'
AT PUNCH IN 1/2" BRASS PLUG IN CONC. MONUMENT IN CASE, 1.0' BELOW RIM, LOCATED
AT THE CENTER CUL-DE-SAC AT THE NORTH END OF 82ND AVE SE.
ELEVATION: 135.14'

### SURVEY NOTES

GIS PARCEL NOTE:

PARCEL LINES AS SHOWN ARE FROM KING COUNTY GIS INFORMATION. NOTE THAT IT IS ONLY A SCHEMATIC REPRESENTATION FOR CONVENIENCE IN INTERPRETING THE TOPOGRAPHY. IT IS NOT A BOUNDARY SURVEY AND SHOULD NOT BE RELIED ON AS

**EQUIPMENT NOTES:** 


PRIMARY CONTROL POINTS AND ACCESSIBLE MONUMENT POSITIONS WERE FIELD MEASURED UTILIZING GLOBAL POSITIONING SYSTEM (GPS) SURVEY TECHNIQUES USING LEICA GS14 GPS/GNSS EQUIPMENT. MONUMENT POSITIONS THAT WERE NOT DIRECTLY OBSERVED USING GPS SURVEY TECHNIQUES WERE TIED INTO THE CONTROL POINTS UTILIZING LEICA ELECTRONIC TS16 TOTAL STATIONS FOR THE MEASUREMENT OF BOTH ANGLES AND DISTANCES. THIS SURVEY MEETS OR EXCEEDS THE STANDARDS SET BY


THE INFORMATION DEPICTED ON THIS MAP REPRESENTS THE RESULTS OF A SURVEY MADE ON OCTOBER 7, 2020 AND CAN ONLY BE CONSIDERED AS INDICATING THE GENERAL CONDITIONS EXISTING AT THAT TIME.

UTILITY LOCATIONS SHOWN HEREON ARE BASED UPON ASBUILT FIELD LOCATION OF EXISTING STRUCTURES. FIELD LOCATION OF UTILITIES BASED ON LOCATOR PAINT MARKINGS AND LOCATIONS BASED ON UTILITY MAPS FROM CITY AND UTILITY DRAWINGS INDICATING REPORTED UTILITY INSTALLATIONS. OTHER UTILITIES MAY EXIST. NO SUB-SURFACE EXPLORATION WAS MADE TO VERIFY UTILITY ROUTINGS AND THE ROUTING OF ALL BURIED UTILITIES SHOULD BE CONFIRMED WITH THE UTILITY PURVEYOR AND EXPOSED IN AREAS CRITICAL TO DESIGN FOR VERIFICATION.

2' CONTOURS INTERVAL DERIVED FROM DIRECT FIELD OBSERVATION.

THIS SURVEY MEETS UNITED STATES NATIONAL MAP ACCURACY STANDARDS FOR VERTICAL ACCURACY OF ONE HALF THE CONTOUR INTERVAL.

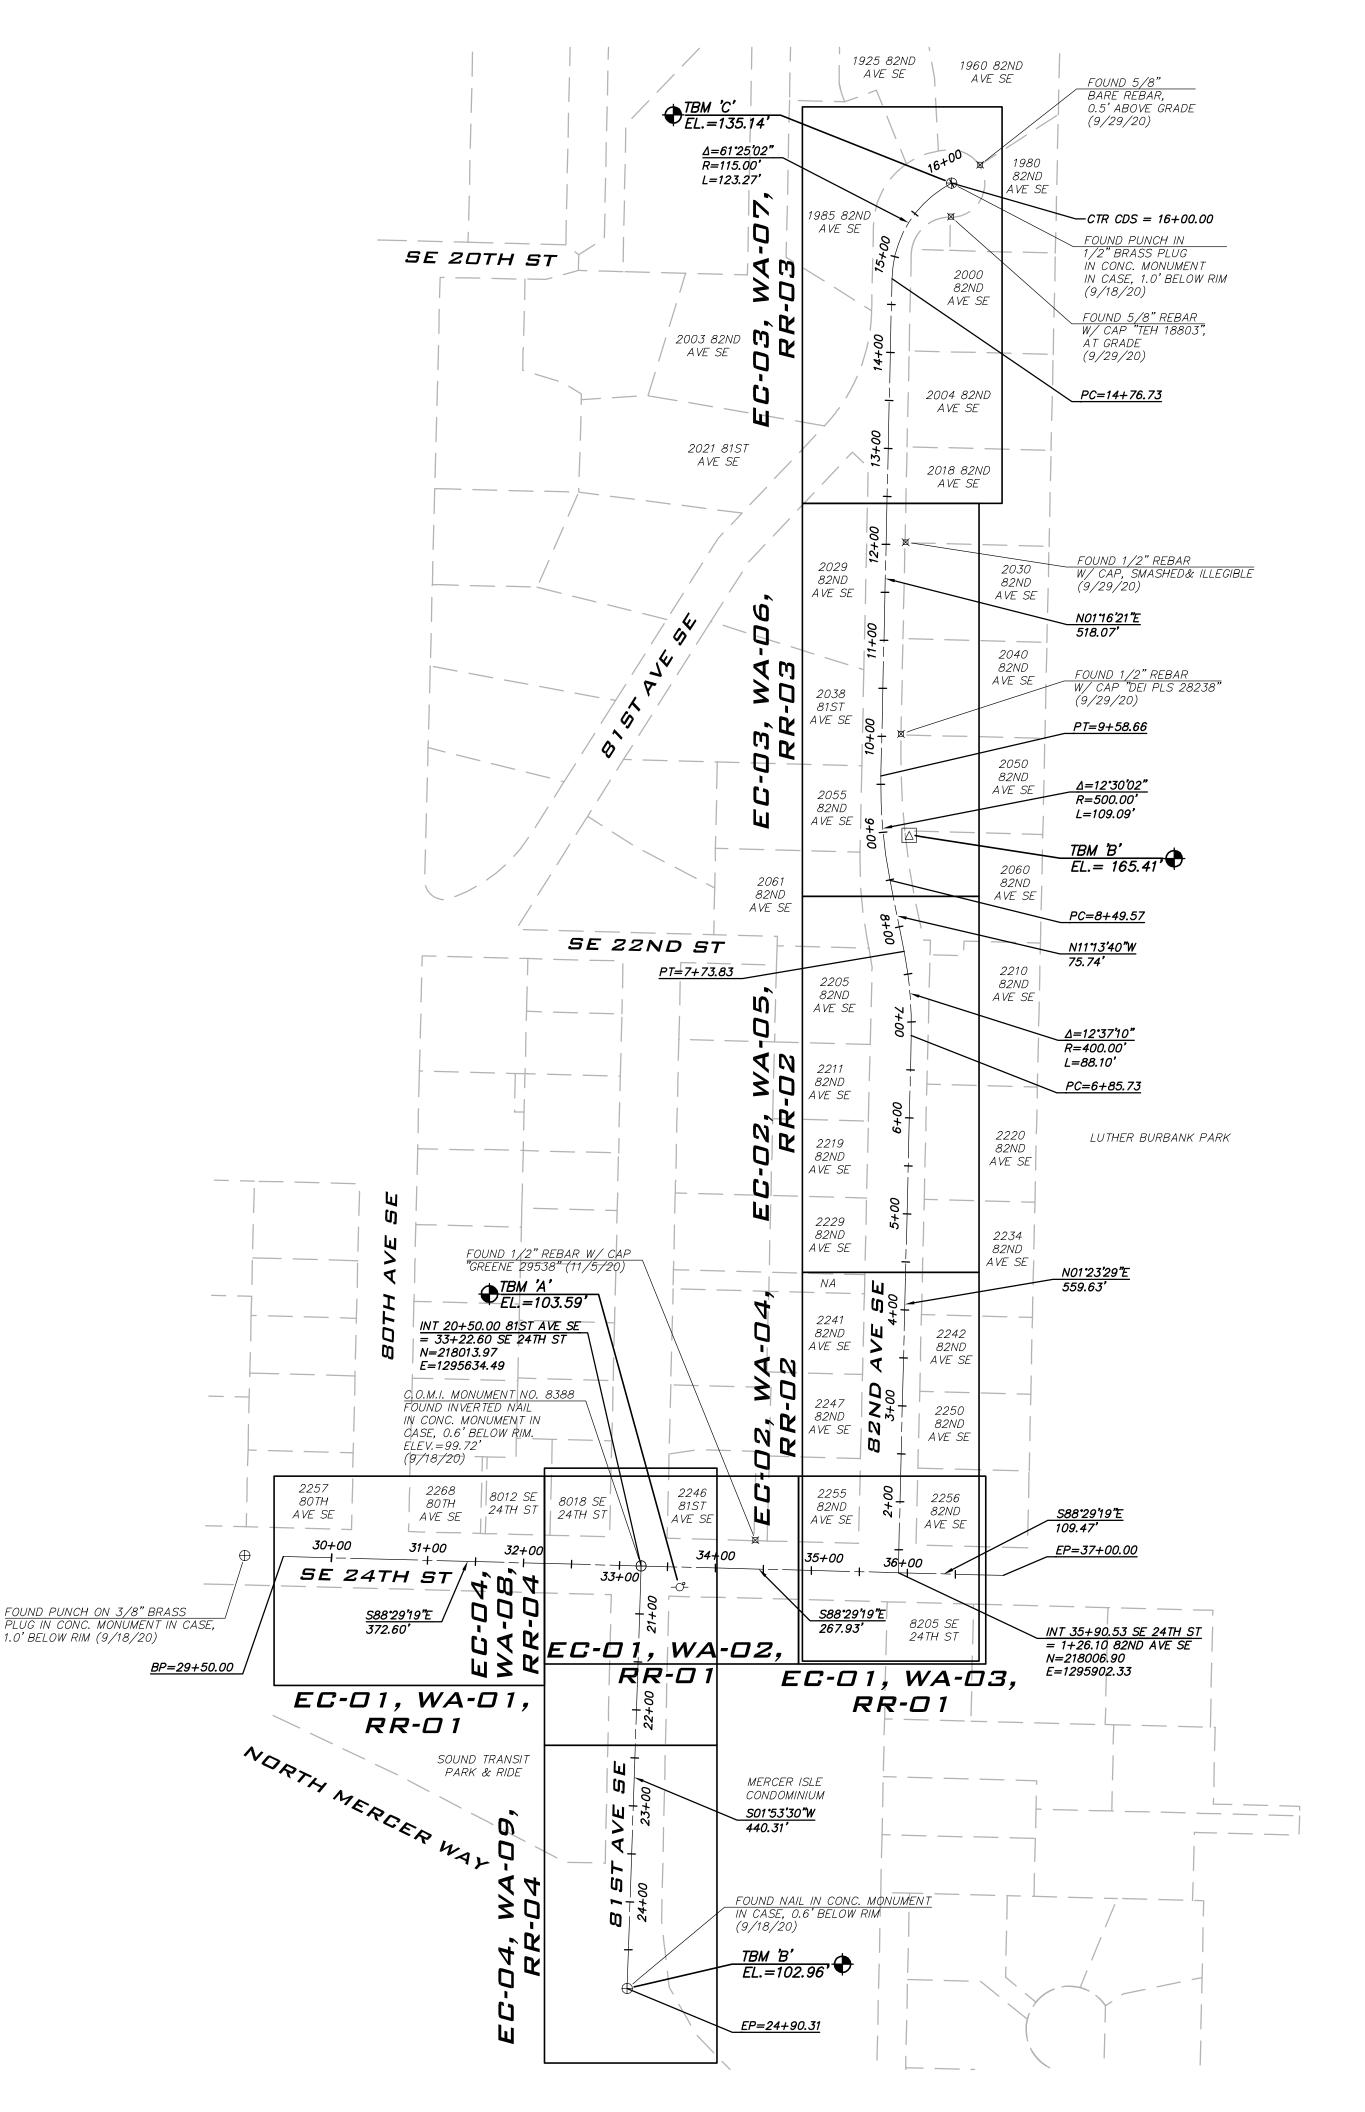

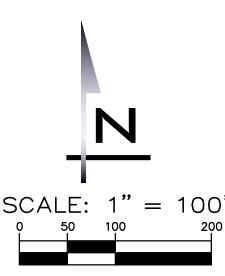

**BLUELINE** 

25 CENTRAL WAY, SUITE 400, KIRKLAND, WA 98033 P: 425.216.4051 F: 425.216.4052 WWW.THEBLUELINEGROUP.COM

SCALE: AS NOTED

PROJECT MANAGER: DEANNA L. MARTIN, PE

PROJECT ENGINEER: GRACE GARWIN, EIT

DESIGNER: CAROL DOGGETT

ISSUE DATE: 2/23/2021

SURVEY NOTATIONS

TBM = TEMPORARY BENCH MARK

AXIS SURVEY CONTROL POINTS ARE HEREBY PROVIDED AS A COURTESY ONLY. EACH POINT SHOULD BE SURVEYED AND VERIFIED INDEPENDENTLY BEFORE BEING UTILIZED FOR ANY REASON. NEITHER AXIS SURVEY OR BLUELINE MAKES ANY WARRANTY AS TO USEFULNESS OR ACCURACY RELATED TO THESE POINTS.

20-286 SHEET NAME:

GN-01

LEGEND						
	PROPOSED FEA	ATURES	<del>-</del>			
	STORM DRAIN PIPE	<b>-</b>	METER AND/OR METER BOX			
	- WATER MAIN		FIRE HYDRANT			
	TYPE I CB — STANDARD GRATE	مهر	AIR/VAC RELEASE VALVE			
◀	PIPE FLOW	<b>)</b>	BLOW OFF			
>	CULVERT END	]●[	VERTICAL BEND			
<del></del>	TEE W/ CONC BLOCKING		INTERIM CATCH BASIN			
₹H	BEND W/ CONC BLOCKING		PROTECTION (INSERT)			
Ħ	SLEEVE		STRAW WATTLE			
]⊬[	GATE VALVE		J. W. W. W. L.			
	EXISTING FEA	TURES				
	- PARCEL LINE		CATCH BASIN, TYPE I			
	- RIGHT-OF-WAY		CATCH BASIN, TYPE II			
	- CENTERLINE - SURFACE FEATURES	$\triangleleft$	SD PIPE FLOW			
		0	YARD DRAIN			
— — —100— — —		)	STORM CULVERT END			
98		Q	FIRE HYDRANT			
SD-	– STORM DRAIN PIPE – SEWED MAIN	⊞—	WATER METER			
	SEWER FORCE MAIN	$\bowtie$	GATE VALVE			
— — — W –	– WATER MAIN	W	WATER MANHOLE			
	AERIAL POWER LINE	W	WATER VAULT			
— — — P — G — G —	- BURIED POWER LINE	$\square$	IRRIGATION VALVE			
	- BURIED CABLE	0	WATER INDICATOR POST			
	BURIED TELEPHONE LINE		MONITOR WELL			
	BURIED FIBER OPTIC CABLE	Ū	UNKNOWN UTILITY MANHOLE			
X_			TELECOMM RISER			
	RETAINING WALL ROCKERY	$\boxtimes$	TELECOMM JUNCTION BOX			
	- EDGE OF LANDSCAPE	<u> </u>	TV RISER			
			MAIL BOX			
~ ~ ~ ~ ~ ~ ~ ~ ~ ~ ~ ~ ~ ~ ~ ~ ~ ~ ~ ~	DITCH OR SWALE	Д	SIGN			
$\bigcirc$	SEWER MANHOLE SS PIPE FLOW	<u></u>	CONIFEROUS TREE			
$\leftarrow$	GUY ANCHOR		33, <u>2</u> ,1333 //. <u>2</u>			
<b>—</b>	STREET LIGHT	<: >	DECIDUOUS TREE			
\$	POLE LIGHT	{\\\\\\\\\\\\\\\\\\\\\\\\\\\\\\\\\\\\\	SHRUB			
<i>⊗</i>	POWER METER TRANSFORMER		ASPHALT			
	JUNCTION BOX	Figure 3.7				
P	POWER VAULT		CONCRETE			
	STREET LIGHT VAULT		GRA VEL			
□ - <del></del>	POWER POLE		ONA VEE			
- <b>Ö</b> -	POWER POLE W/ TRANSFORMER					
- <del>-</del> -	POWER POLE W/ UNDERGROUND	CONDUIT				
_ <del>_</del>	•					
<del>-</del>	POWER POLE W/ TRANSFORMER	& UNDER	GROUND CONDUIT			

### POTHOLE DATA

POTHOLE #	TARGET UTILITY	DEPTH TO TOP OF UTILITY (INCHES)	DEPTH TO BOTTOM OF UTILITY (INCHES)	PIPE CONDUIT SIZE (INCHES)	PIPE MATERIAL	PAVEMENT THICKNESS
1	GAS	42.5"	46.5"	4"	PE	9" ASPHALT
2	GAS	44"	48"	4"	PE	9.5" ASPHALT
3	GAS	36"	40"	4"	PE	N/A
4	GAS	33"	34 1/4"	1 1/4"	PE	7.5" ASPHALT
5	GAS	40"	44"	4"	PE	4" ASPHALT

### GENERAL NOTES

- 1. ALL MATERIALS AND WORK SHALL CONFORM TO THE LATEST EDITION OF THE CITY OF MERCER ISLAND STANDARD PLANS AND SPECIFICATIONS IN CONJUNCTION WITH THE APPLICABLE SECTIONS OF THE 2018 EDITION OF THE STANDARD SPECIFICATIONS FOR ROAD, BRIDGE, AND MUNICIPAL CONSTRUCTION AS ISSUED BY THE WASHINGTON STATE DEPARTMENT OF TRANSPORTATION AND AMERICAN PUBLIC WORKS ASSOCIATION. A COPY OF THESE DOCUMENTS SHALL BE ON SITE DURING CONSTRUCTION.
- 2. A COPY OF THE APPROVED PLANS MUST BE ON SITE WHENEVER CONSTRUCTION IS IN
- 3. PAVED SURFACES INCLUDING ROADWAYS, SIDEWALKS, DRIVEWAYS, AND CURBS THAT ARE DAMAGED BY NEW CONSTRUCTION SHALL BE REPAIRED AS REQUIRED BY THE CITY OF MERCER ISLAND INSPECTOR.
- 4. THE CONTRACTOR SHALL NOTIFY THE CITY 21 DAYS IN ADVANCE OF ALL WATER SERVICE INTERRUPTIONS, HYDRANT SHUTOFFS, AND STREET CLOSURES OR OTHER ACCESS BLOCKAGE.
- 5. ALL LOCATIONS OF EXISTING UTILITIES AND SERVICE CONNECTIONS SHOWN HEREON HAVE BEEN ESTABLISHED BY FIELD SURVEY, G.I.S., OR OBTAINED FROM AVAILABLE RECORDS AND SHOULD THEREFORE BE CONSIDERED APPROXIMATE ONLY AND NOT NECESSARILY COMPLETE. IT IS THE SOLE RESPONSIBILITY OF THE CONTRACTOR TO INDEPENDENTLY VERIFY THE ACCURACY OF ALL UTILITY LOCATIONS SHOWN AND TO FURTHER DISCOVER AND AVOID ANY OTHER UTILITIES NOT SHOWN HEREON WHICH MAY BE AFFECTED BY THE IMPLEMENTATION OF THIS PLAN.
- 6. THE CONTRACTOR SHALL LOCATE AND PROTECT ALL CASTINGS AND UTILITIES DURING CONSTRUCTION AND SHALL CONTACT THE UNDERGROUND UTILITIES LOCATOR SERVICE (8-1-1) AT LEAST 2 BUSINESS DAYS PRIOR TO CONSTRUCTION.
- 7. THE CONTRACTOR SHALL KEEP OFF-SITE STREETS CLEAN AT ALL TIMES BY SWEEPING. WASHING OF THESE STREETS WILL NOT BE ALLOWED WITHOUT PRIOR APPROVAL FROM THE CITY OF MERCER ISLAND.
- 8. THE CONTRACTOR SHALL SECURE ALL LOADS PER RCW 46.61.655.
- 9. PROTECT ALL LANDSCAPING AND TREES FROM DAMAGE UNLESS SPECIFICALLY CALLED OUT ON PLANS TO BE REMOVED. REPLACE ALL TREES, LANDSCAPING, AND LANDSCAPING IRRIGATION DAMAGED OR DESTROYED DURING CONSTRUCTION.
- 10. TRIM OR REMOVE PLANTS, IF NEEDED, TO ACCOMMODATE THE RELOCATION OF HYDRANTS AND METER BOXES. PROVIDE LANDSCAPE RESTORATION TO MATCH EXISTING SURROUNDINGS.
- 11. PROVIDE HYDROSEED FOR ALL UNPAVED AND NON-GRAVEL AREAS DISTURBED DURING CONSTRUCTION.
- 12. NO EXPOSED EXCAVATION IS ALLOWED OVERNIGHT. STEEL PLATES MAY BE USED ONLY FOR PRE-DIGGING CONNECTIONS OR WHEN CDF IS REQUIRED AS BACKFILL. WHEN USING TEMPORARY STEEL PLATES, THEY SHALL BE RAMPED WITH TEMPORARY HOT MIX ASPHALT AND THE CONSTRUCTION AREA SHALL BE SIGNED AT THE END OF THE WORKING DAY. UNLESS USING STEEL PLATES, BACKFILL TO GRADE AND PROVIDE 2 TEMPORARY PATCH AT THE END OF EACH WORK DAY. ASPHALT GRINDINGS MAY BE USED AS TEMP PATCH MONDAY-THURSDAY, WITH 2" HMA PATCH PROVIDED ON FRIDAYS. IN THE EVENT OF INCLEMENT WEATHER, THE INSPECTOR MAY REQUIRE 2" HMA PATCH BE PROVIDED MORE FREQUENTLY.

### TRAFFIC CONTROL NOTES

- 1. THE CONTRACTOR SHALL SUBMIT A TRAFFIC CONTROL PLAN FOR REVIEW AND APPROVAL BY THE CITY OF MERCER ISLAND PRIOR TO BEGINNING CONSTRUCTION.
- 2. ALL TRAFFIC CONTROL SHALL BE COORDINATED WITH THE CITY OF MERCER ISLAND.
- 3. ALL TRAFFIC CONTROL DEVICES SHALL MEET THE MANUAL OF UNIFORM TRAFFIC CONTROL DEVICES STANDARDS.
- 4. CONTRACTOR SHALL NOTIFY KING COUNTY METRO AT 206-684-2732 SEVEN DAYS IN ADVANCE OF ANY IMPACT TO TRANSIT OPERATIONS.
- 5. THE CONTRACTOR SHALL PROVIDE EMERGENCY VEHICLE ACCESS TO ALL PROPERTIES ADJACENT TO THE PROJECT AT ALL TIMES.

### TESC NOTES

- 1. THE CONTRACTOR SHALL HAVE TEMPORARY EROSION AND SEDIMENTATION CONTROL (TESC) MEASURES IN PLACE PRIOR TO CONSTRUCTION.
- 2. THE CONTRACTOR SHALL PROVIDE AND MAINTAIN TEMPORARY SEDIMENTATION COLLECTION FACILITIES TO ENSURE THAT SEDIMENT-LADEN WATER DOES NOT ENTER THE NATURAL OR PUBLIC DRAINAGE SYSTEM. AS CONSTRUCTION PROGRESSES AND UNEXPECTED (SEASONAL) CONDITIONS DICTATE, MORE SILTATION CONTROL FACILITIES MAY BE REQUIRED TO INSURE COMPLETE SILTATION CONTROL OF THE PROJECT. THEREFORE, DURING THE COURSE OF CONSTRUCTION IT SHALL BE THE OBLIGATION AND RESPONSIBILITY OF THE CONTRACTOR TO ADDRESS ANY NEW CONDITIONS THAT MAY BE CREATED BY HIS ACTIVITIES AND TO PROVIDE ADDITIONAL FACILITIES THAT MAY BE NEEDED TO PROTECT ADJACENT PROPERTIES.
- 3. THE CITY MAY DIRECT MAINTENANCE AND REPAIR OF TESC FACILITIES AS THE HIGHEST PRIORITY WORK AT ANY TIME THE TESC FACILITIES DO NOT MEET THE REQUIREMENTS OF THE PLANS AND SPECIFICATIONS.

### GENERAL WATER NOTES

- 1. LOCATIONS SHOWN FOR EXISTING UNDERGROUND UTILITIES ARE APPROXIMATE. UTILITIES HAVING NO RECORDED DEPTH ARE SHOWN AT THEIR STANDARD DEPTH. UTILITIES THAT APPEAR CLOSE TO THE PROPOSED WATER MAIN SHALL BE EXPOSED BY THE CONTRACTOR PRIOR TO LAYING THE WATER MAIN TO DETERMINE IF CHANGES ARE NEEDED.
- 2. ALL MATERIAL FOR WATER DISTRIBUTION SHALL BE NEW.
- PIPE 4" AND LARGER SHALL BE D.I.P. CL. 52 CONFORMING TO AWWA C-151 WITH CEMENT MORTAR LINING CONFORMING TO AWWA C-104. UNLESS OTHERWISE NOTED, JOINTS SHALL BE MECHANICAL OR SLIP JOINT.
- 4. ALL FITTINGS SHALL BE DUCTILE IRON CONFORMING TO AWWA C-110 AND C-111, OR AWWA C-153, AND SHALL BE CEMENT MORTAR LINED CONFORMING TO AWWA C-104. THRUST RESTRAINT REQUIRED AT ALL FITTINGS AND AT LOCATIONS INDICATED IN PLANS.
- 5. PRIOR TO LAYING PIPE THE CONTRACTOR SHALL:
- 5.1. IN THE PRESENCE OF THE CONSTRUCTION INSPECTOR, EXPOSE THE EXISTING WATER MAIN TO DETERMINE ITS ELEVATION AND ALIGNMENT.
- 5.2. PROVIDE ALL STAKING REQUIRED TO DEFINE THE ALIGNMENT AND ELEVATIONS OF THE WATER MAIN IN CONFORMANCE WITH THE APPROVED PLAN. THE SURVEYS SHALL BE PERFORMED BY A SURVEYOR LICENSED BY THE STATE OF WASHINGTON. ALL REFERENCE MARKS SHALL BE PRESERVED DURING CONSTRUCTION. A GRADE SHEET, IN ACCEPTABLE FORMAT, SHALL BE PROVIDED PRIOR TO BEGINNING WORK.
- 5.3. THE CONTRACTOR SHALL LOCATE EXISTING UTILITIES AT LEAST 500' AHEAD OF THE PIPE LAYING OPERATION TO ALLOW THE REQUIRED CLEARANCES TO BE ACHIEVED BY DEFLECTING THE WATER LINE AT THE JOINTS.
- 5.4. THE CONTRACTOR SHALL NOTIFY ALL OWNERS OF ALL AFFECTED UNDERGROUND UTILITIES A MINIMUM OF 2 BUSINESS DAYS BEFORE FIELD LOCATING THEIR UTILITIES. THE ONE CALL NOTIFICATION NUMBER IS 1-800-424-5555.
- 6. CARE SHALL BE EXERCISED WHEN EXCAVATING NEAR EXISTING CHARGED WATER MAINS AND FORCE SEWER MAINS.
- 7. IT SHALL BE THE CONTRACTOR'S RESPONSIBILITY TO INSTALL DUCTILE IRON PIPE IN PLACE OF ANY OTHER SANITARY SEWER PIPE MATERIAL WHERE SANITARY SEWERS ARE LOCATED ABOVE AND ANY CLOSER THAN 10 FEET, OR CROSS OVER ANY WATER LINE.
- 8. ALL WATER MAINS SHALL BE PRESSURE TESTED AND DISINFECTED IN ACCORDANCE WITH THE PROJECT SPECIFICATIONS. ALL PRESSURE TESTING SHALL BE DONE IN THE PRESENCE OF THE CONSTRUCTION INSPECTOR. THE CONTRACTOR IS TO PROVIDE PLUGS AND TEMPORARY BLOWOFF ASSEMBLIES FOR PRESSURE TESTING AND DISINFECTION. A SATISFACTORY LAB RESULT FOR THE WATER SAMPLES COLLECTED AFTER THE FLUSHING SHALL BE RECEIVED BY THE CITY PRIOR TO PUTTING THE MAIN INTO SERVICE.
- 9. THE CONTRACTOR SHALL COMPLY WITH ALL REQUIREMENTS OF THE PERMITS ISSUED FOR THIS
- 10. THRUST BLOCKING SHALL BE PROVIDED FOR ALL TEES, BENDS, CAPS, DEAD-ENDS, AND CROSSES, AND SHALL COMPLY WITH CITY OF MERCER ISLAND STANDARD DETAIL W-5A. IF CONFLICTING UTILITIES PREVENT THE USE OF A THRUST BLOCK IN COMPLIANCE WITH THE STANDARD DETAIL, THE CONTRACTOR SHALL INSTALL ROMAC PIPE RESTRAINERS AS APPROVED BY THE ENGINEER.
- 11. WATER MAIN SHUT-OFF SHALL BE COORDINATED WITH THE CITY OF MERCER ISLAND. 21 DAYS ADVANCED NOTICE IS REQUIRED. REFER TO SPECIFICATION SECTIONS 7-09.3(19)A AND
- 12. ALL WATER SERVICE PIPING MUST BE INSPECTED PRIOR TO BACKFILLING TRENCH.
- 13. WATER SERVICE INSTALLATION SHALL BE IN ACCORDANCE WITH CITY OF MERCER ISLAND SPECIFICATIONS SECTION 7-15, STANDARD DETAILS W-13, W-14, AND W-14A, AND APPLICABLE WSDOT STANDARDS.
- 14. PROVIDE FITTINGS, BENDS, AND BLOCKING AS REQUIRED TO MAKE SERVICE CONNECTION.
- 15. PROVIDE ALL GATE VALVES WITH WATER VALVE BOXES PER MERCER ISLAND STANDARD DETAILS W-7 AND W-8. IF REQUIRED, INSTALL WATER VALVE EXTENSIONS PER MERCER ISLAND STANDARD DETAIL W-9.
- 16. FIRE HYDRANT INSTALLATION SHALL BE IN ACCORDANCE WITH THE CITY OF MERCER ISLAND SPECIFICATIONS SECTION 7-14 AND STANDARD DETAIL W-24. CONTRACTOR SHALL POTHOLE EXISTING UTILITIES TO DETERMINE THE REQUIRED HYDRANT BURY DEPTH TO INSTALL HYDRANTS WITHOUT USING VERTICAL BENDS. THIS POTHOLING SHALL BE DONE EARLY ENOUGH TO ALLOW PROPER DEPTH HYDRANTS TO BE ORDERED.
- 17. A TEMPORARY HYDRANT METER AND BACKFLOW DEVICE ARE REQUIRED PER SPECIFICATION SECTION 7-00.1 WHEN USING CITY WATER FOR CONSTRUCTION, INCLUDING FLUSHING THE MAIN.
- 18. WHEN FLUSHING THE MAIN, DISCHARGED WATER MUST BE DRAINED INTO THE SANITARY SEWER SYSTEM. THIS DISCHARGE MUST BE COORDINATED WITH THE CITY UTILITIES MANAGER.
- 19. ANY REMOVED FIRE HYDRANTS, VALVES, SETTERS, AND OTHER METER HARDWARE SHALL BE RETURNED TO THE CITY STORAGE YARD AS SALVAGE. THE CITY WILL SUPPLY NEW METERS.
- 20. ABANDON EXISTING WATER SERVICE IN PLACE WHERE NEW 1" THROUGH 2" SERVICE LINES ARE INSTALLED. TURN OFF CORP STOP TO ABANDON SERVICE AT METER. ROLL OVER ON SIDE AND BURY ABANDONED SERVICE.
- 21. MAXIMUM PIPE DEFLECTION AT JOINTS SHALL BE HALF THE MANUFACTURER'S ALLOWABLE DEFLECTION UNLESS OTHERWISE SPECIFIED.
- 22. CONTRACTOR SHALL COORDINATE CONSTRUCTION W/ PUGET SOUND ENERGY (PSE) PRIOR TO EXCAVATION NEAR GAS MAINS. THE PSE REPRESENTATIVE SHALL (AT A MINIMUM) BE ONSITE FOR CONSTRUCTION AROUND 4" DIAMETER AND LARGER AND/OR HIGH PRESSURE GAS MAIN. PROVIDE SAND BEDDING PER PSE REQUIREMENTS.
- 23. CONTRACTOR SHALL POTHOLE AT ALL LOCATIONS WHERE PROPOSED WATER MAIN & FIRE HYDRANT LATERAL CROSS THE EXISTING WATER MAIN, STORM DRAIN OR SEWER MAIN & SERVICES TO VERIFY DEPTH OF EXISTING MAIN IN ACCORDANCE WITH SPECIFICATION SECTION 1-07.17(2). FIRE HYDRANT LATERALS SHALL BE INSTALLED ABOVE OR BELOW EXISTING MAIN. STORM DRAIN AND SEWER MAIN WITHOUT USING BENDS. CONTRACTOR IS REQUIRED TO DETERMINE IF NEW WATER MAIN NEEDS TO BE INSTALLED DEEPER TO ACCOMPLISH THIS.
- 24. CONTRACTOR TO LOCATE AIR & VACUUM VALVE ASSEMBLY TEE AT HIGH POINT OF NEW MAIN. INSTALLATION OF AIR RELEASE ASSEMBLY MAY REQUIRE MORE THAN 3' OF COVER AT NEW MAIN. SEE CITY OF MERCER ISLAND STANDARD DETAIL W-25.
- 25. ALL TEMPORARY BLOW-OFFS MUST BE LOCATED OUTSIDE OF THE ROADWAY. ALL PARTS USED IN SETTING THE TEMPORARY BLOW-OFF SHALL BE PER THE TEMPORARY BLOW-OFF DETAIL ON
- 26. ALL MONUMENTS DISTURBED BY CONSTRUCTION ARE TO BE REPLACED BY A LICENSED SURVEYOR. CONTRACTOR SHALL NOTIFY SURVEYOR 1 WEEK IN ADVANCE OF DISTURBING MONUMENT SO SURVEY CAN TIE IN THE MONUMENT AND FILE PAPERWORK WITH THE STATE PRIOR TO MONUMENT



25 CENTRAL WAY, SUITE 400, KIRKLAND, WA 98033 P: 425.216.4051 F: 425.216.4052 WWW.THEBLUELINEGROUP.COM

SCALE: AS NOTED


PROJECT MANAGER: DEANNA L. MARTIN, PE

PROJECT ENGINEER:

GRACE GARWIN, EIT DESIGNER:

CAROL DOGGETT ISSUE DATE:

	2/23/	<b>202</b>	21				
	REVISIONS						
	ВУ						
	NO DATE						
	ON						

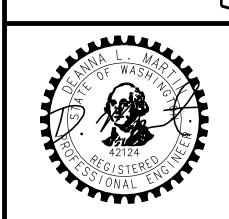

JOB NUMBER: 20-286

SHEET NAME: GN-02

METERS AND METER BOXES TO BE REPLACED WILL BE PROVIDED BY THE CITY.



25 CENTRAL WAY, SUITE 400, KIRKLAND, WA 98033 P: 425.216.4051 F: 425.216.4052 WWW.THEBLUELINEGROUP.COM


SCALE: AS NOTED

PROJECT MANAGER: DEANNA L. MARTIN, PE

PROJECT ENGINEER: GRACE GARWIN, EIT

DESIGNER: CAROL DOGGETT

ISSUE DATE: 2/23/2021

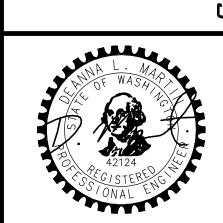

2/23/21

JOB NUMBER: 20-286

SHEET NAME: GN-03

sнт <u>4</u> ог <u>26</u>

8114 SE 24TH ST

8" DI IE 115.79 (N)

12" CPP IE 114.89 (Ŵ)

12" CPP IE 115.29 (E) 12" CPP IE 115.24 (W)

8" DI IE 104.41 (S)

12" CPP IE 104.30 (E) 12" CPP IE 104.26 (W)

> EX ¢B (1006) | RIM 107.62

MERCER ISLE CONDOMINIUM

8105 N MERCER WAY

8" DI IE 105.36 (N)

2246 81ST AVE SE

ELEV.=99.72'

TBM 'A' EL.=103.59'

EX SSMH (6808)

8" CONC IE 88.66 (E)

8" CONC IE 88.64 (S)

8" CONC IE 88.55 (W)

4" CLAY IE 97.63 (NE)

8" CONC IE 97.31 (NW)

COULD NOT FIND PIPE

\*12" CONC (SE), PER GIS,

C.O.M.I. MONUMENT NO. 8388
FOUND INVERTED NAIL
IN CONC. MONUMENT IN
CASE, 0.6' BELOW RIM.

RIM 99.72 12" CPP IE 97.68 (E) 12" CONC IE 97.66 (W)

12" CPP IE 97,66 (N)

EX CULV 12" DI IE 123.61 (N)


STRAW WATTLE PER DETAIL, THIS SHEET

EX CULV 8" DI IE 118.10 (S)

SE 24TH ST

8" CONC IE (E)

8" PVC IE (W) CTR. CHANNEL 110.45

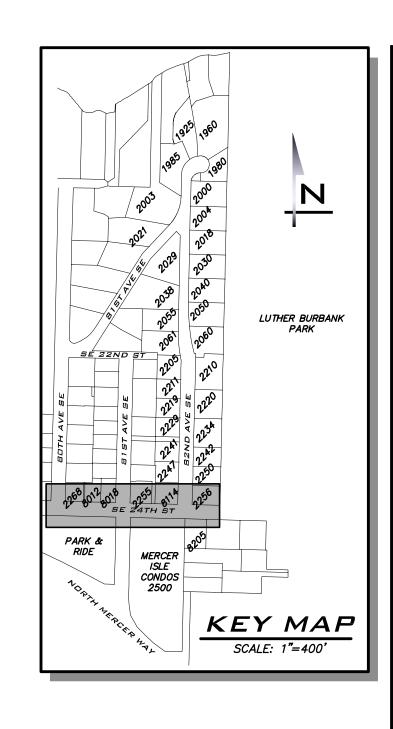

· ADJACENT ROLLS SHALL TIGHTLY
ABUT STRAW ROLLS MUST BE PLACED ALONG SLOPE (3-8m)SEDIMENT, ORGANIC MATTER, AND NATIVE SEEDS ARE CAPTURED BEHIND THE ROLLS ROLL SPACING DEPENDS ON SOIL TYPE AND SLOPE STEEPNESS *3"-5"* (75–125mm) - 8"–10" DIA. (200-250mm) LIVE STAKE 1" x 1" STAKE STRAW WATTLES NOTES:

2256 82ND AVE SE

L TIMBER BORDER

8205 SE 24TH ST

(NOT IN PROJECT)

6" CMP IE 119.72 (NE)

12" CMP IE 119.73`(N

12" CONC IE 119.63 (S)

6" CONC IE 116.77 (S) 12" CONC IE 116.67 (NW) 12" CONC IE 116.57 (W)

6" CONC IE 117.43 (N)

\*UNABLE TO OPEN

STRUCTURE

STRAW WATTLE

NOT TO SCALE

1. STRAW ROLL INSTALLATION REQUIRES THE PLACEMENT AND SECURE

STAKING OF THE ROLL IN A TRENCH, 3" x 5" (75-125mm) DEEP, DUG ON CONTOUR. RUNOFF MUST NOT BE ALLOWED TO RUN

### EXISTING UTILITY NOTE

UNDER OR AROUND ROLL.

EXISTING UTILITIES ARE SHOWN IN THE APPROXIMATE LOCATION. THERE IS NO GUARANTEE THAT ALL UTILITY LINES ARE SHOWN, OR THAT THE LOCATION, SIZE AND MATERIAL IS ACCURATE. THE CONTRACTOR SHALL UNCOVER ALL INDICATED PIPING WHERE CROSSING, INTERFERENCES, OR CONNECTIONS OCCUR PRIOR TO TRENCHING OR EXCAVATION FOR ANY PIPE OR STRUCTURES, TO DETERMINE ACTUAL LOCATIONS, SIZE AND MATERIAL. THE CONTRACTOR SHALL MAKE THE APPROPRIATE PROVISION FOR PROTECTION OF SAID FACILITIES. THE CONTRACTOR SHALL NOTIFY ONE CALL AT 8-1-1 (WASHINGTON811.COM) AND ARRANGE FOR FIELD LOCATION OF EXISTING FACILITIES BEFORE CONSTRUCTION.

TING CONDITIONS & TESC OF DATE BY PLAN - SE 24TH ST

CO21 WATER SYSTEM

PROVEMENTS PROJECT

2/23/21

20-286

SHEET NAME:

EC-01

5 of 26

BLUELINE

25 CENTRAL WAY, SUITE 400,

KIRKLAND, WA 98033 P: 425.216.4051 F: 425.216.4052

WWW.THEBLUELINEGROUP.COM

PROJECT MANAGER:

DEANNA L. MARTIN, PE

PROJECT ENGINEER:

GRACE GARWIN, EIT

DESIGNER:
CAROL DOGGETT
ISSUE DATE:
2/23/2021

AS NOTED

3, 2021 – 4:50pm – User cdoggett

© 2021 THE BLUELINE GROUP

8" CPP IE 93.10 (SE)\*

8" CPP IE 93.08 (S)

12" CONC IE 93.05 (E 12" CONC IE 92.97 (W

\*UNABLE TO FIND (SE)

SEDIMENT CATCH BASIN INSERT PER DETAIL, THIS

8" CPP IE 93.23 (N)

33+00

SEE SHEET EC-04

END OF THIS PIPE

8018 SE 24TH ST

18" CMP IE 93.02 (SE)

18" CMP IE 92.96 (W)


\*8" CPP (NW) PER GIS,


UNABLE TO FIND PIPE IN STRUCTURE


\*UNABLE TO OPEN


SOUND TRANSIT PARK & RIDE

8109 N MERCER WAY

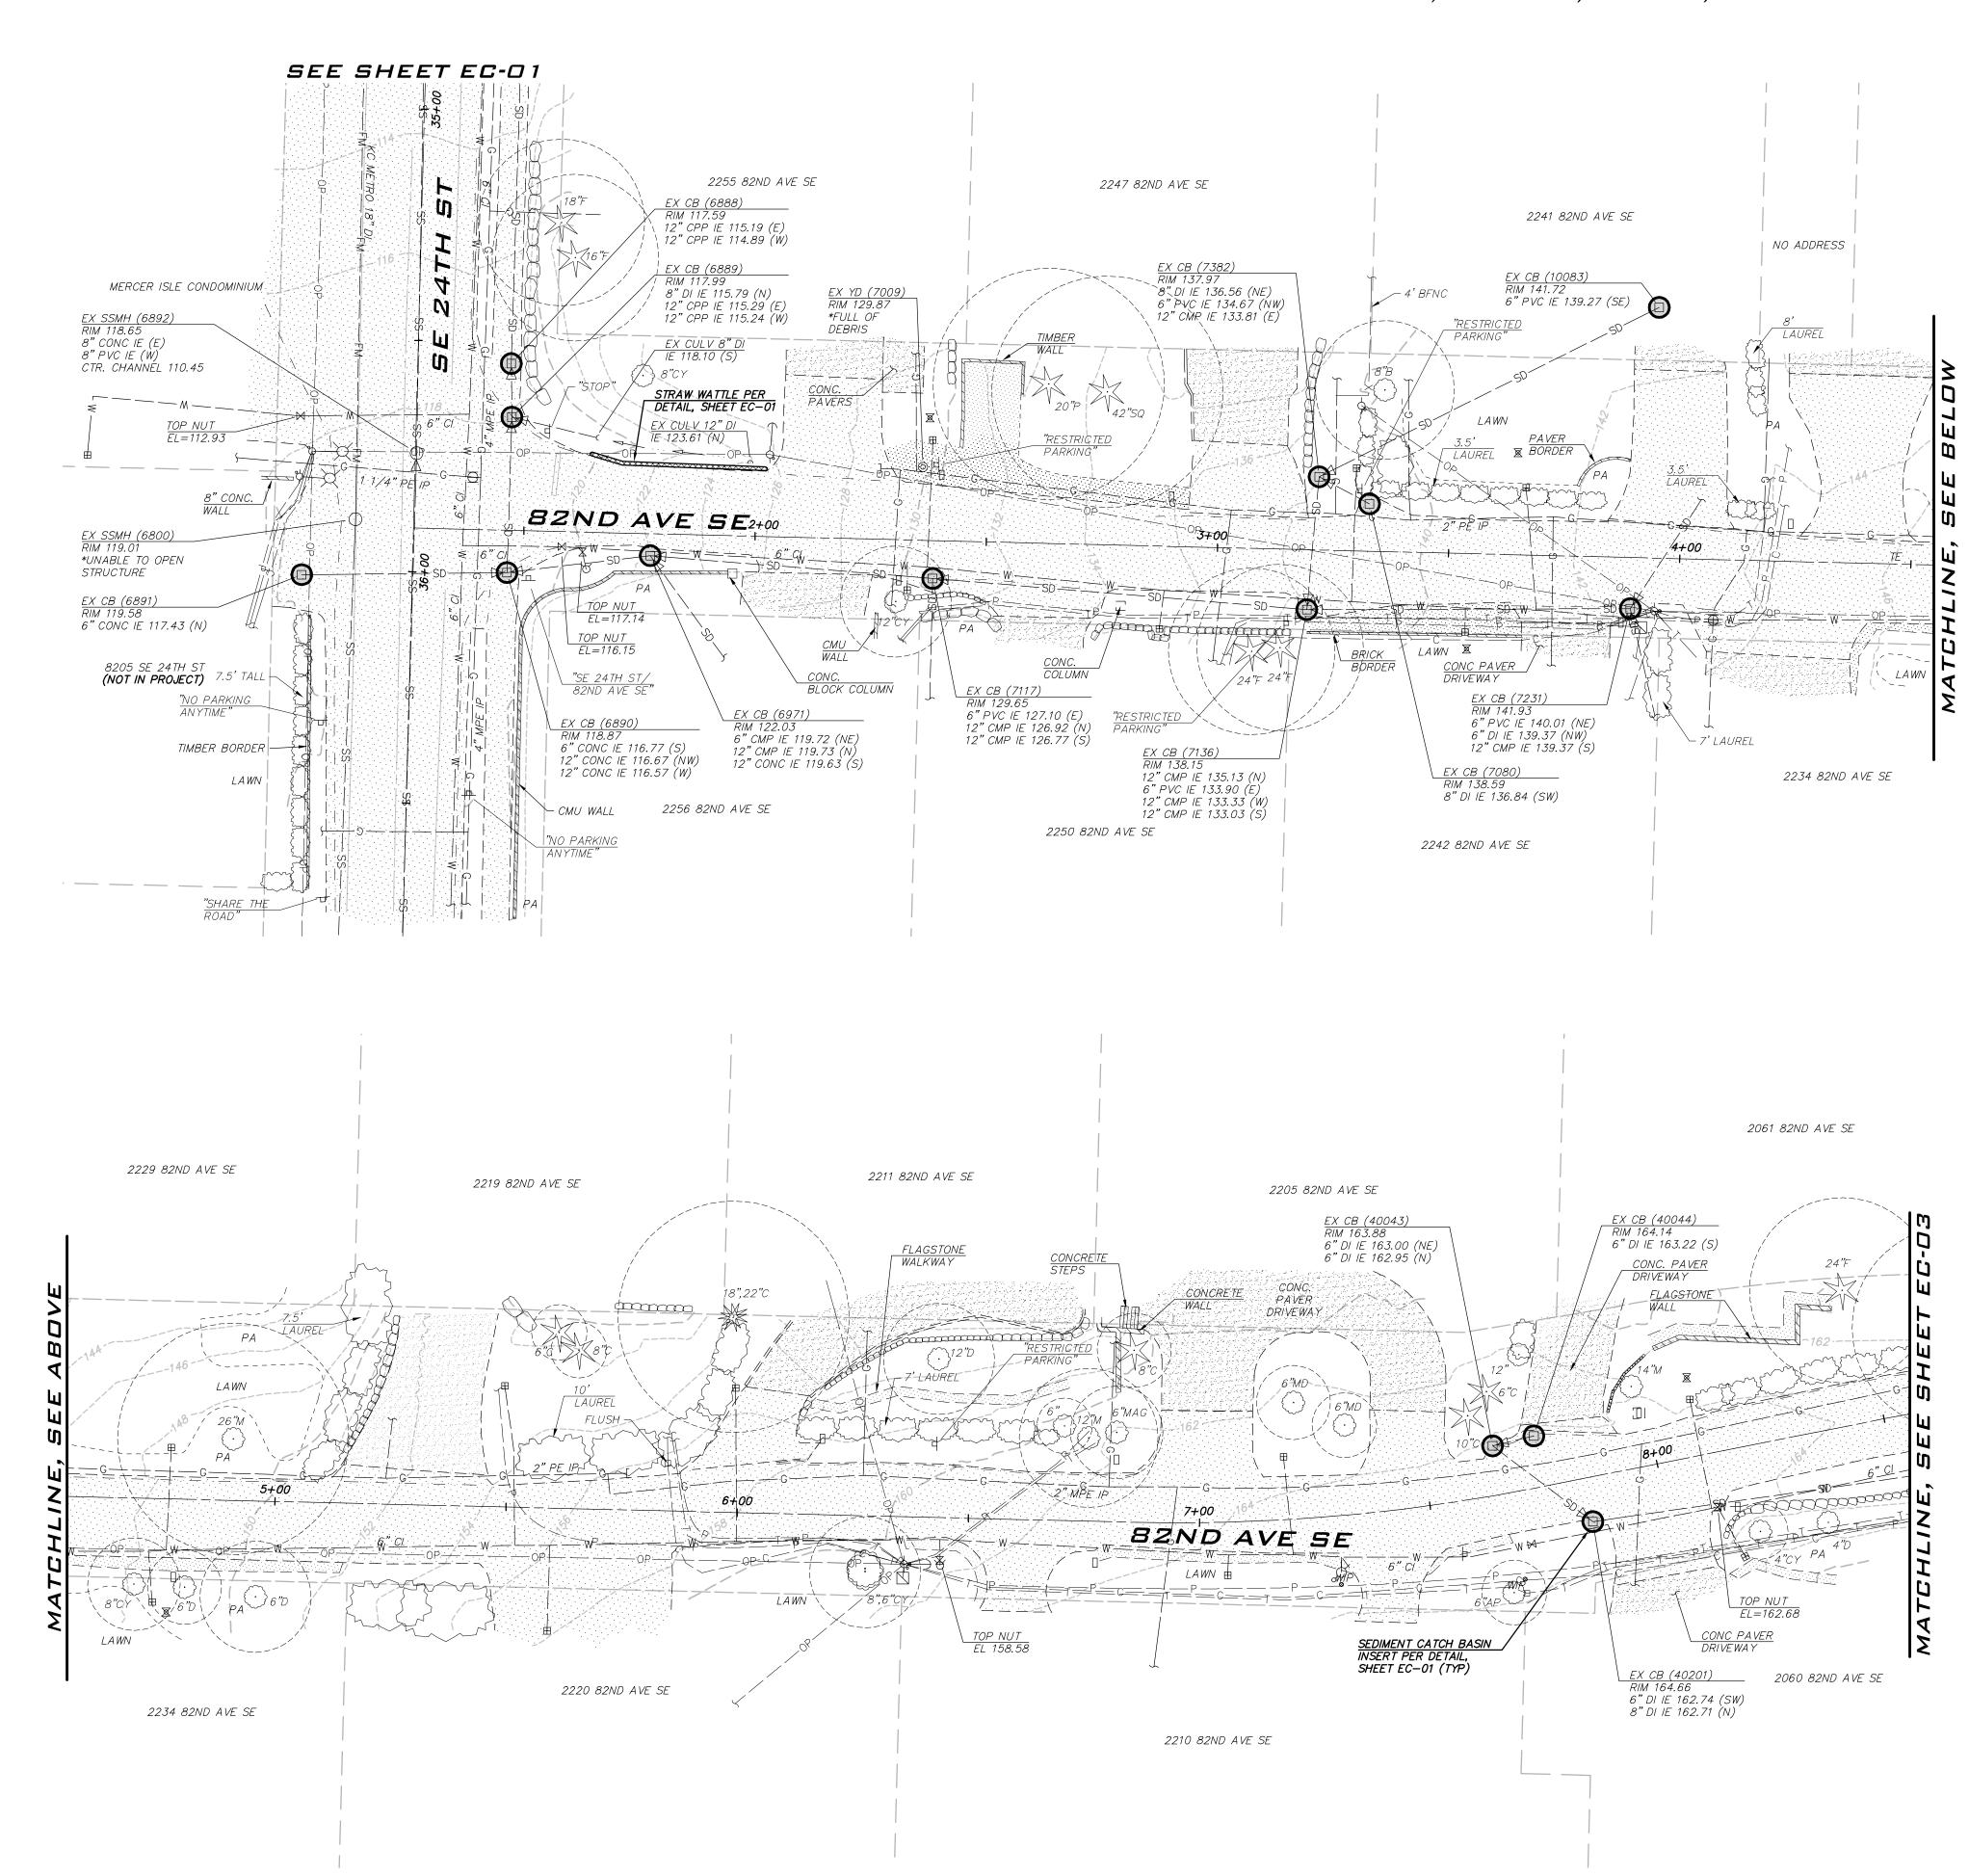

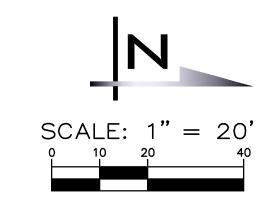

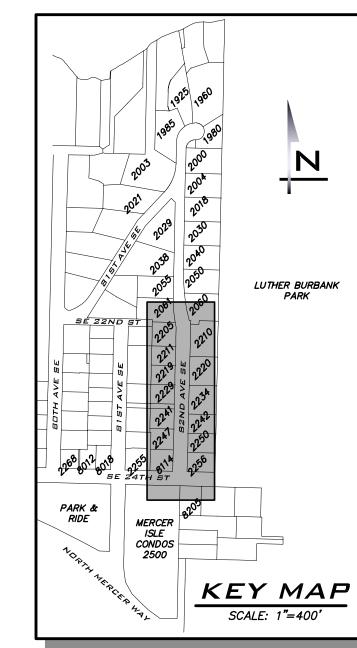

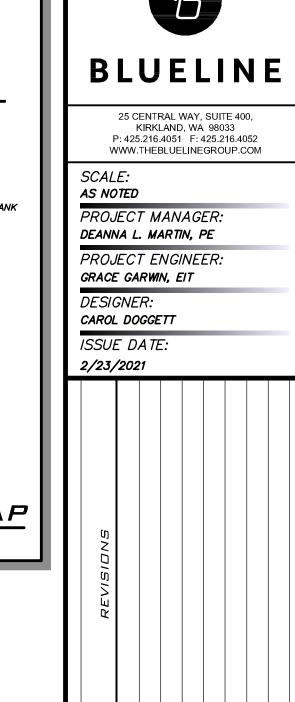

EXISTING CONDITIONS & TE PLAN - 82ND AVE SE 2021 WATER SYSTEM

TO WASH A2124

2/23/21


JOB NUMBER: 20-286


SHEET NAME: EC-O2


<u>6</u> of <u>26</u>


EXISTING UTILITY NOTE

EXISTING UTILITIES ARE SHOWN IN THE APPROXIMATE LOCATION. THERE IS NO GUARANTEE THAT ALL UTILITY LINES ARE SHOWN, OR THAT THE LOCATION, SIZE AND MATERIAL IS ACCURATE. THE CONTRACTOR SHALL UNCOVER ALL INDICATED PIPING WHERE CROSSING, INTERFERENCES, OR CONNECTIONS OCCUR PRIOR TO TRENCHING OR EXCAVATION FOR ANY PIPE OR STRUCTURES, TO DETERMINE ACTUAL LOCATIONS, SIZE AND MATERIAL. THE CONTRACTOR SHALL MAKE THE APPROPRIATE PROVISION FOR PROTECTION OF SAID FACILITIES. THE CONTRACTOR SHALL NOTIFY ONE CALL AT 8-1-1 (WASHINGTON811.COM) AND ARRANGE FOR FIELD LOCATION OF EXISTING FACILITIES BEFORE CONSTRUCTION.

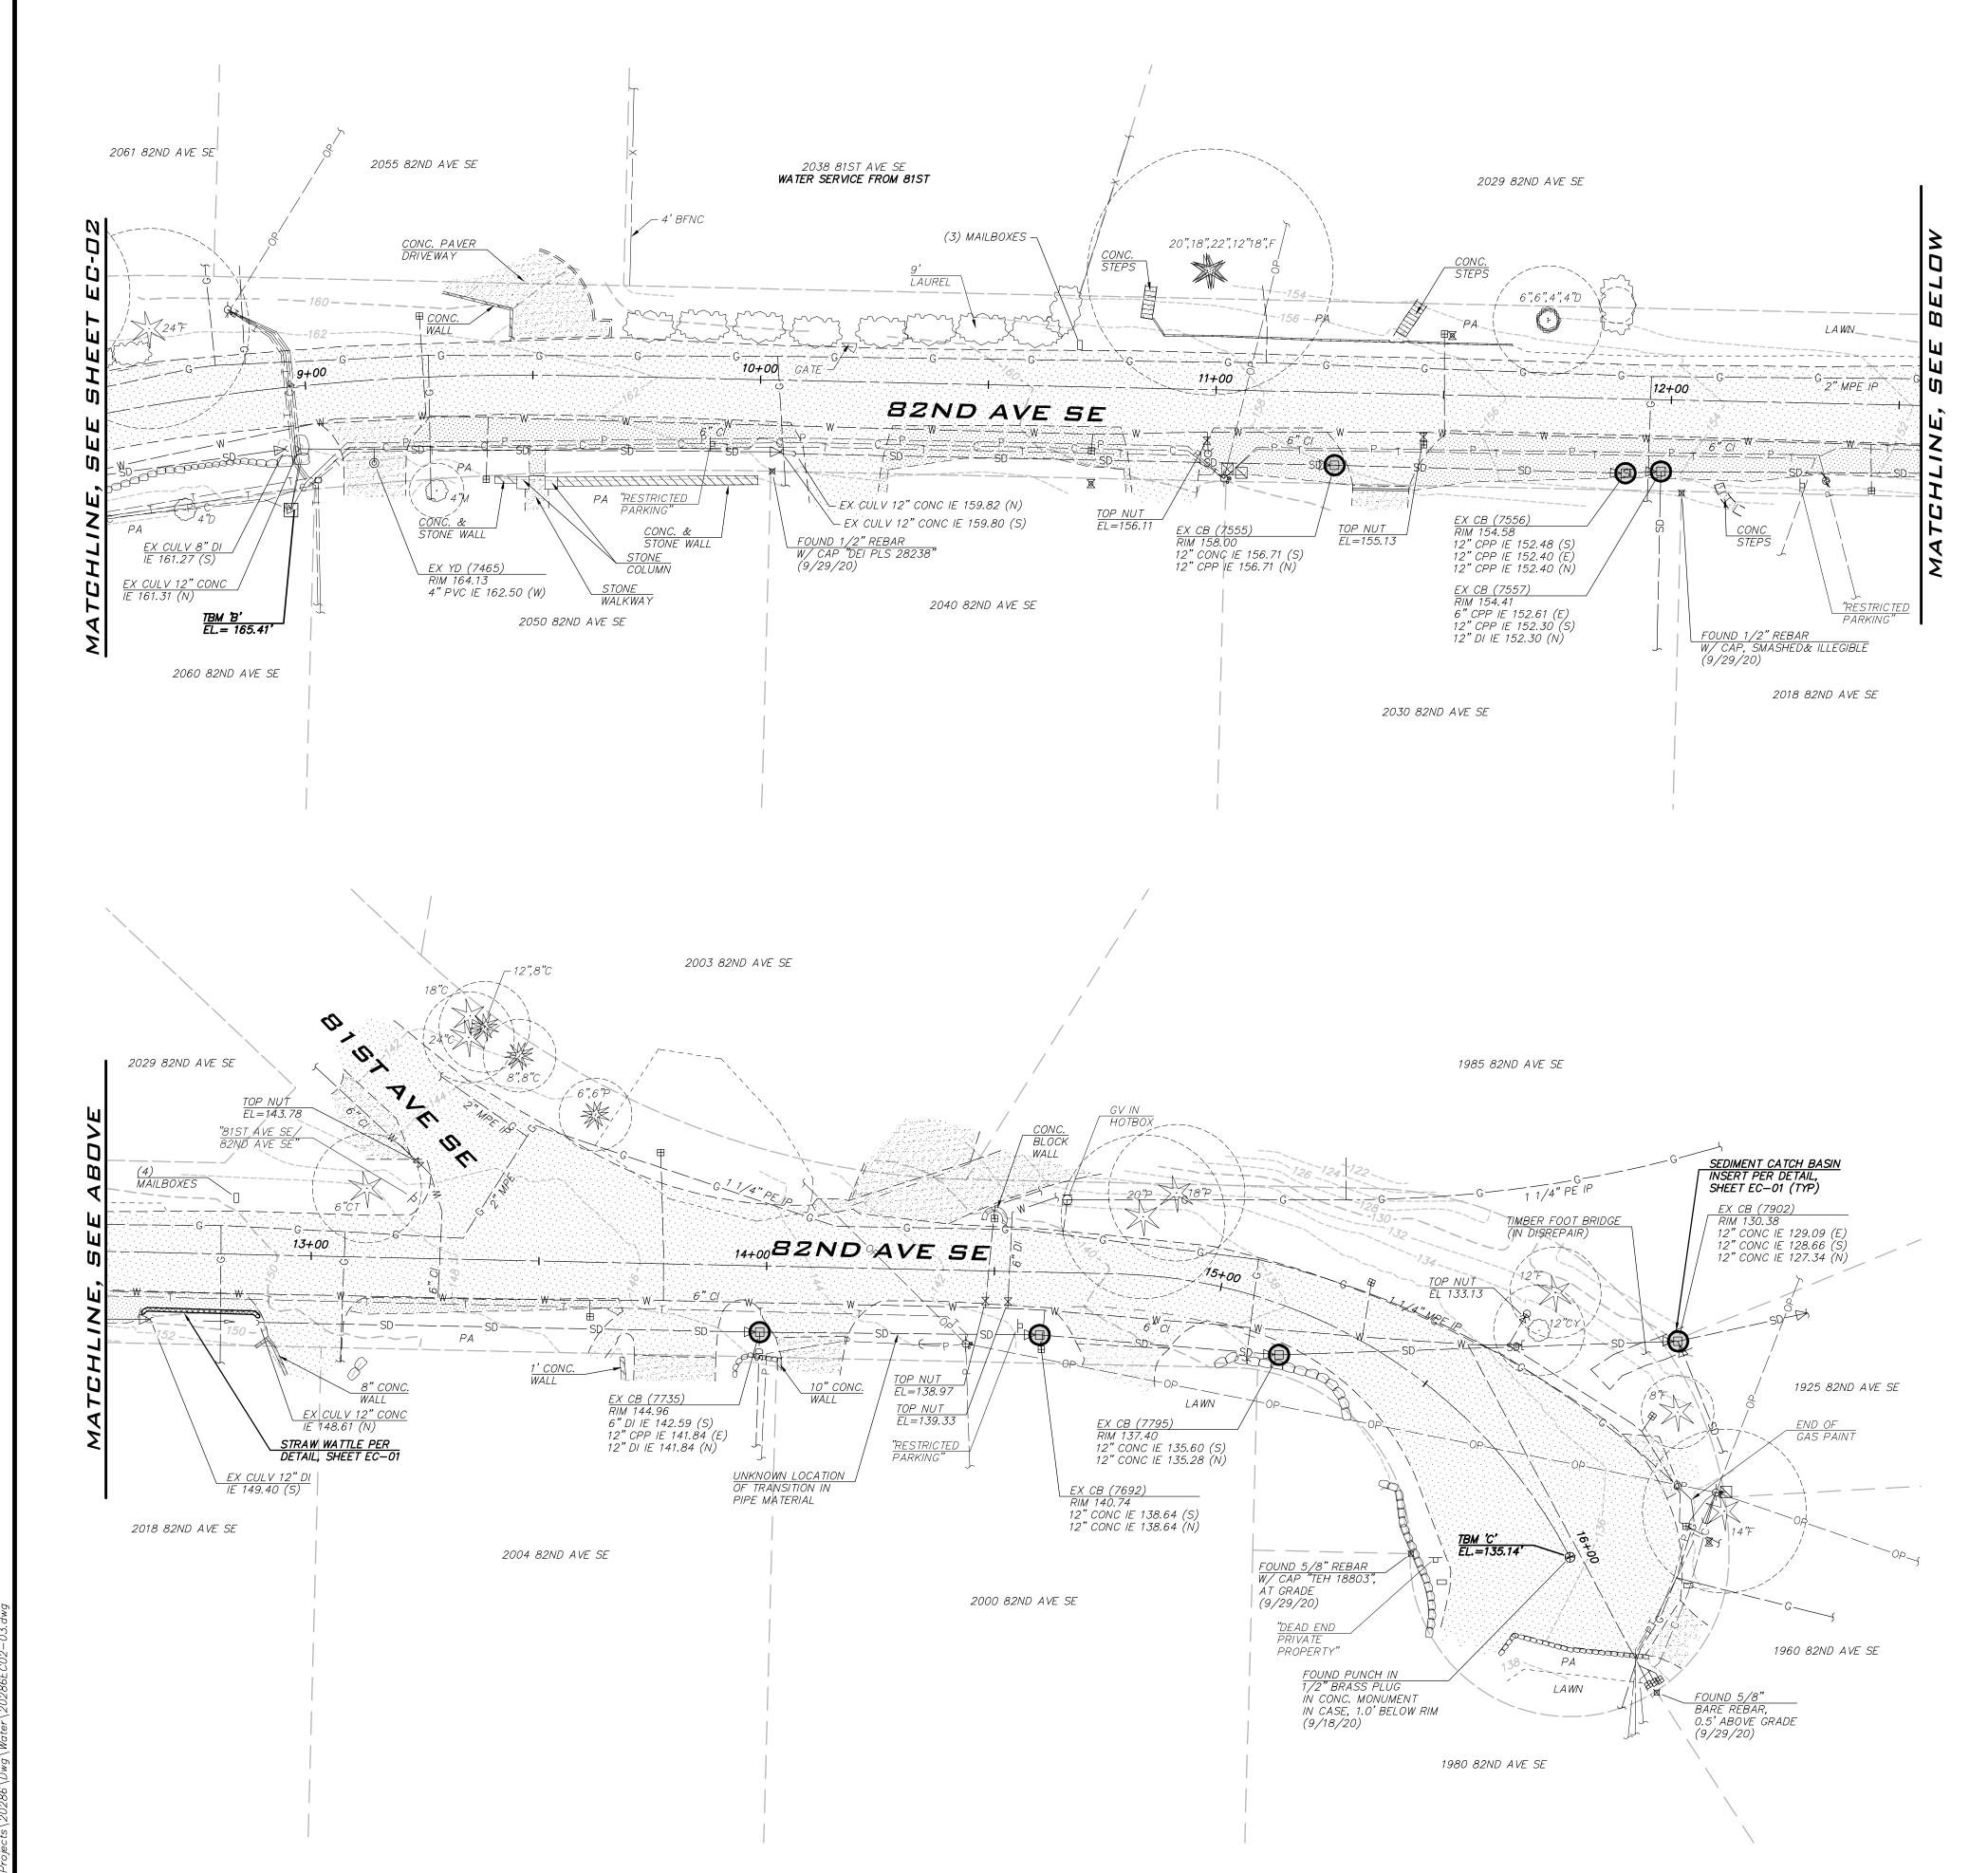

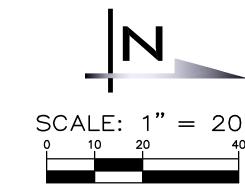

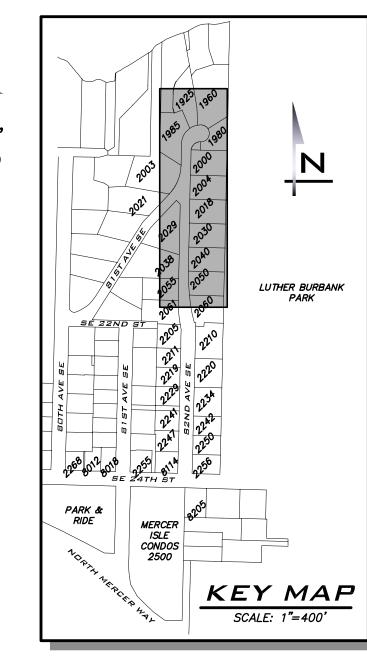

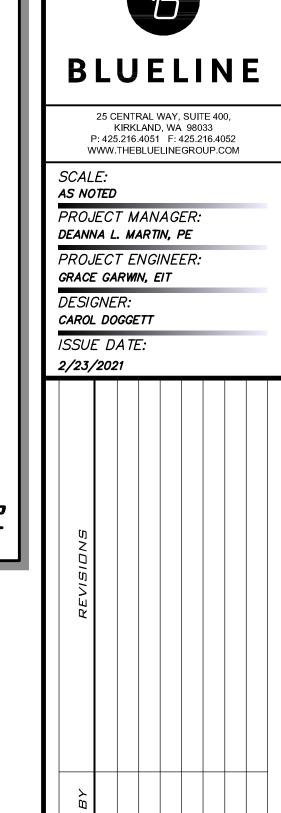

EXISTING CONDITIONS & TESC PLAN - 82ND AVE SE 2021 WATER SYSTEM



EXISTING UTILITY NOTE

EXISTING UTILITIES ARE SHOWN IN THE APPROXIMATE LOCATION. THERE IS NO GUARANTEE THAT ALL UTILITY LINES ARE SHOWN, OR THAT THE LOCATION, SIZE AND MATERIAL IS ACCURATE. THE CONTRACTOR SHALL UNCOVER ALL INDICATED PIPING WHERE CROSSING, INTERFERENCES, OR CONNECTIONS OCCUR PRIOR TO TRENCHING OR EXCAVATION FOR ANY PIPE OR STRUCTURES, TO DETERMINE ACTUAL LOCATIONS, SIZE AND MATERIAL. THE CONTRACTOR SHALL MAKE THE APPROPRIATE PROVISION FOR PROTECTION OF SAID FACILITIES. THE CONTRACTOR SHALL NOTIFY ONE CALL AT 8-1-1 (WASHINGTON811.COM) AND ARRANGE FOR FIELD LOCATION OF EXISTING FACILITIES BEFORE CONSTRUCTION.


٦l


2/23/2|


20-286


EC-03


т<u>7</u> оғ <u>26</u>

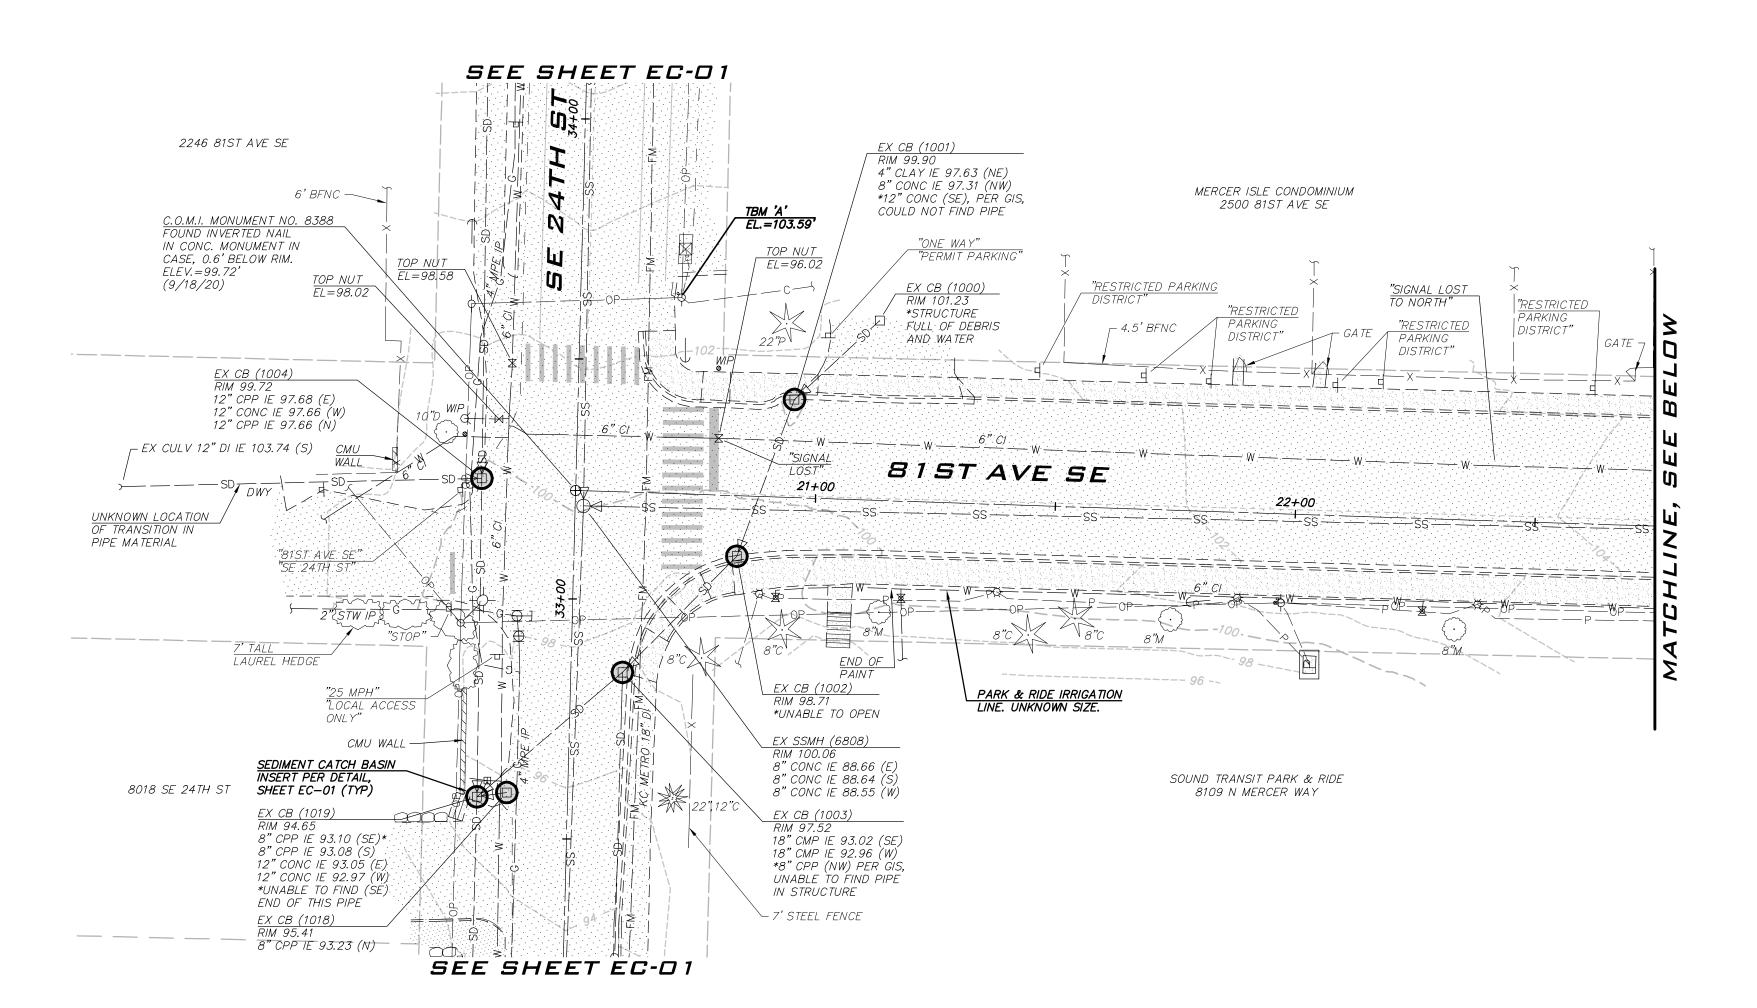

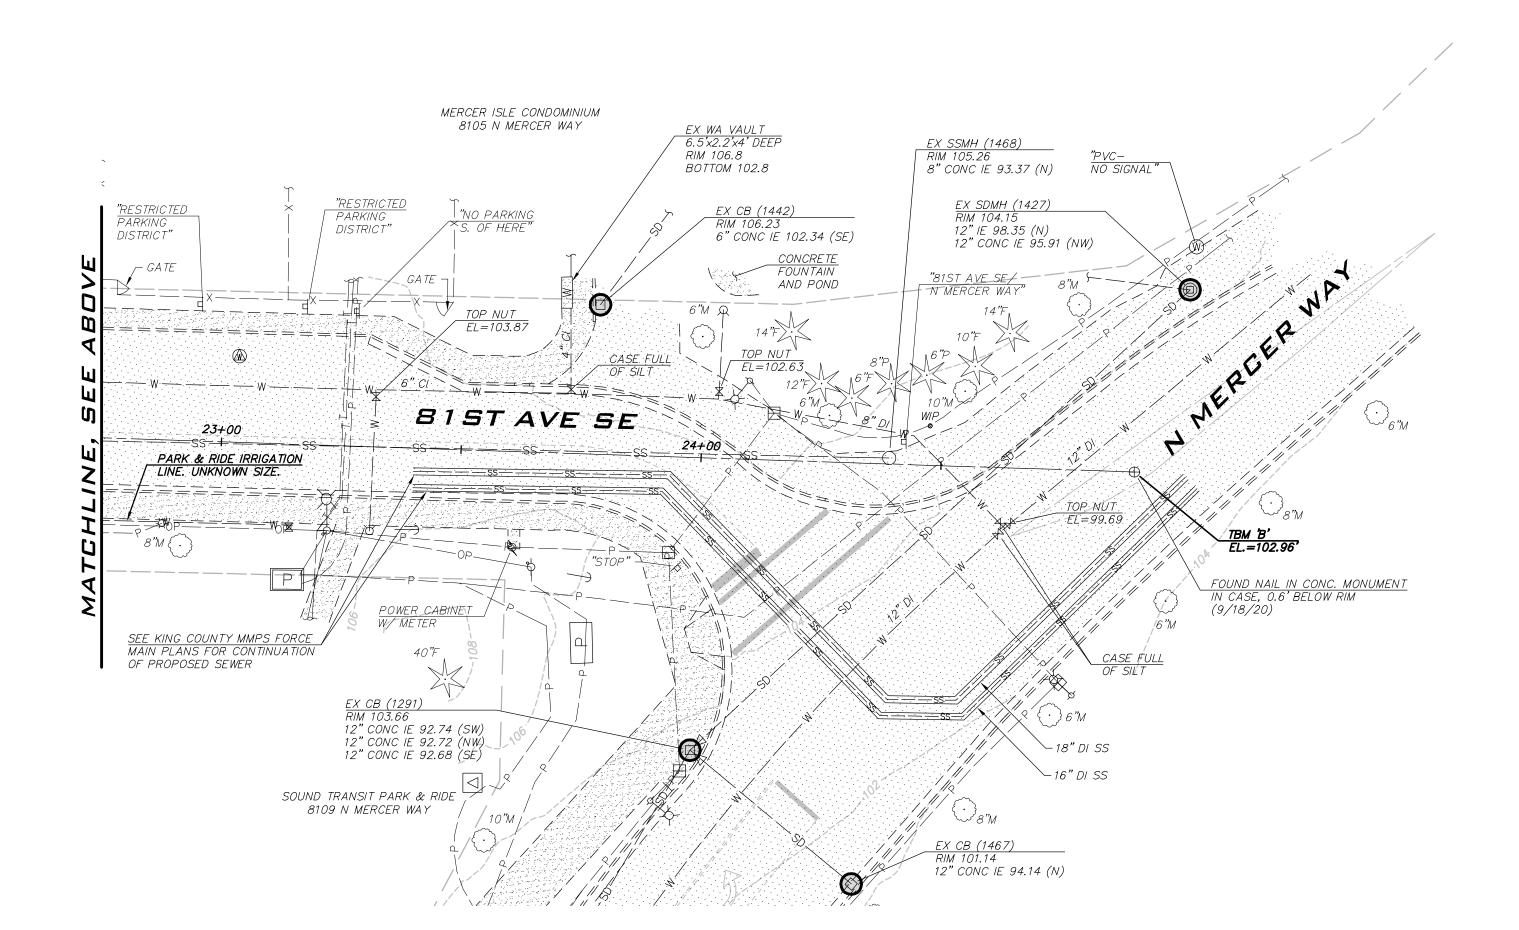

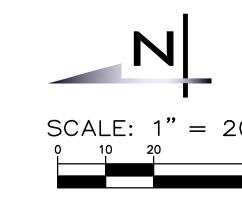

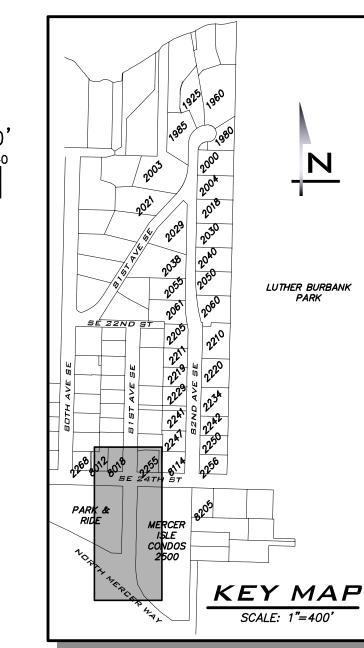

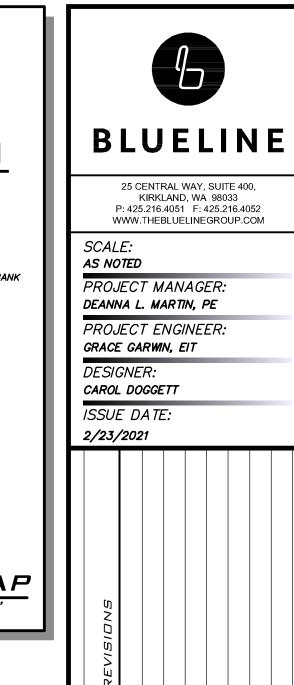

# STING CONDITIONS & TESC NO STING CONDITIONS & TESC NO STAN - 81ST AVE SE

WASHING WASHIN


2/23/21

JOB NUMBER: **20-286** 

SHEET NAME: EC-04

tt <u>8</u> of <u>26</u>

EXISTING UTILITIES ARE SHOWN IN THE APPROXIMATE LOCATION. THERE IS NO GUARANTEE THAT ALL UTILITY LINES ARE SHOWN, OR THAT THE LOCATION, SIZE AND MATERIAL IS ACCURATE. THE CONTRACTOR SHALL UNCOVER ALL INDICATED PIPING WHERE CROSSING, INTERFERENCES, OR CONNECTIONS OCCUR PRIOR TO TRENCHING OR EXCAVATION FOR ANY PIPE OR STRUCTURES, TO DETERMINE ACTUAL LOCATIONS, SIZE AND MATERIAL. THE CONTRACTOR SHALL MAKE THE APPROPRIATE PROVISION FOR PROTECTION OF SAID FACILITIES. THE CONTRACTOR SHALL NOTIFY ONE CALL AT 8-1-1 (WASHINGTON811.COM) AND ARRANGE FOR FIELD LOCATION OF EXISTING FACILITIES BEFORE CONSTRUCTION.

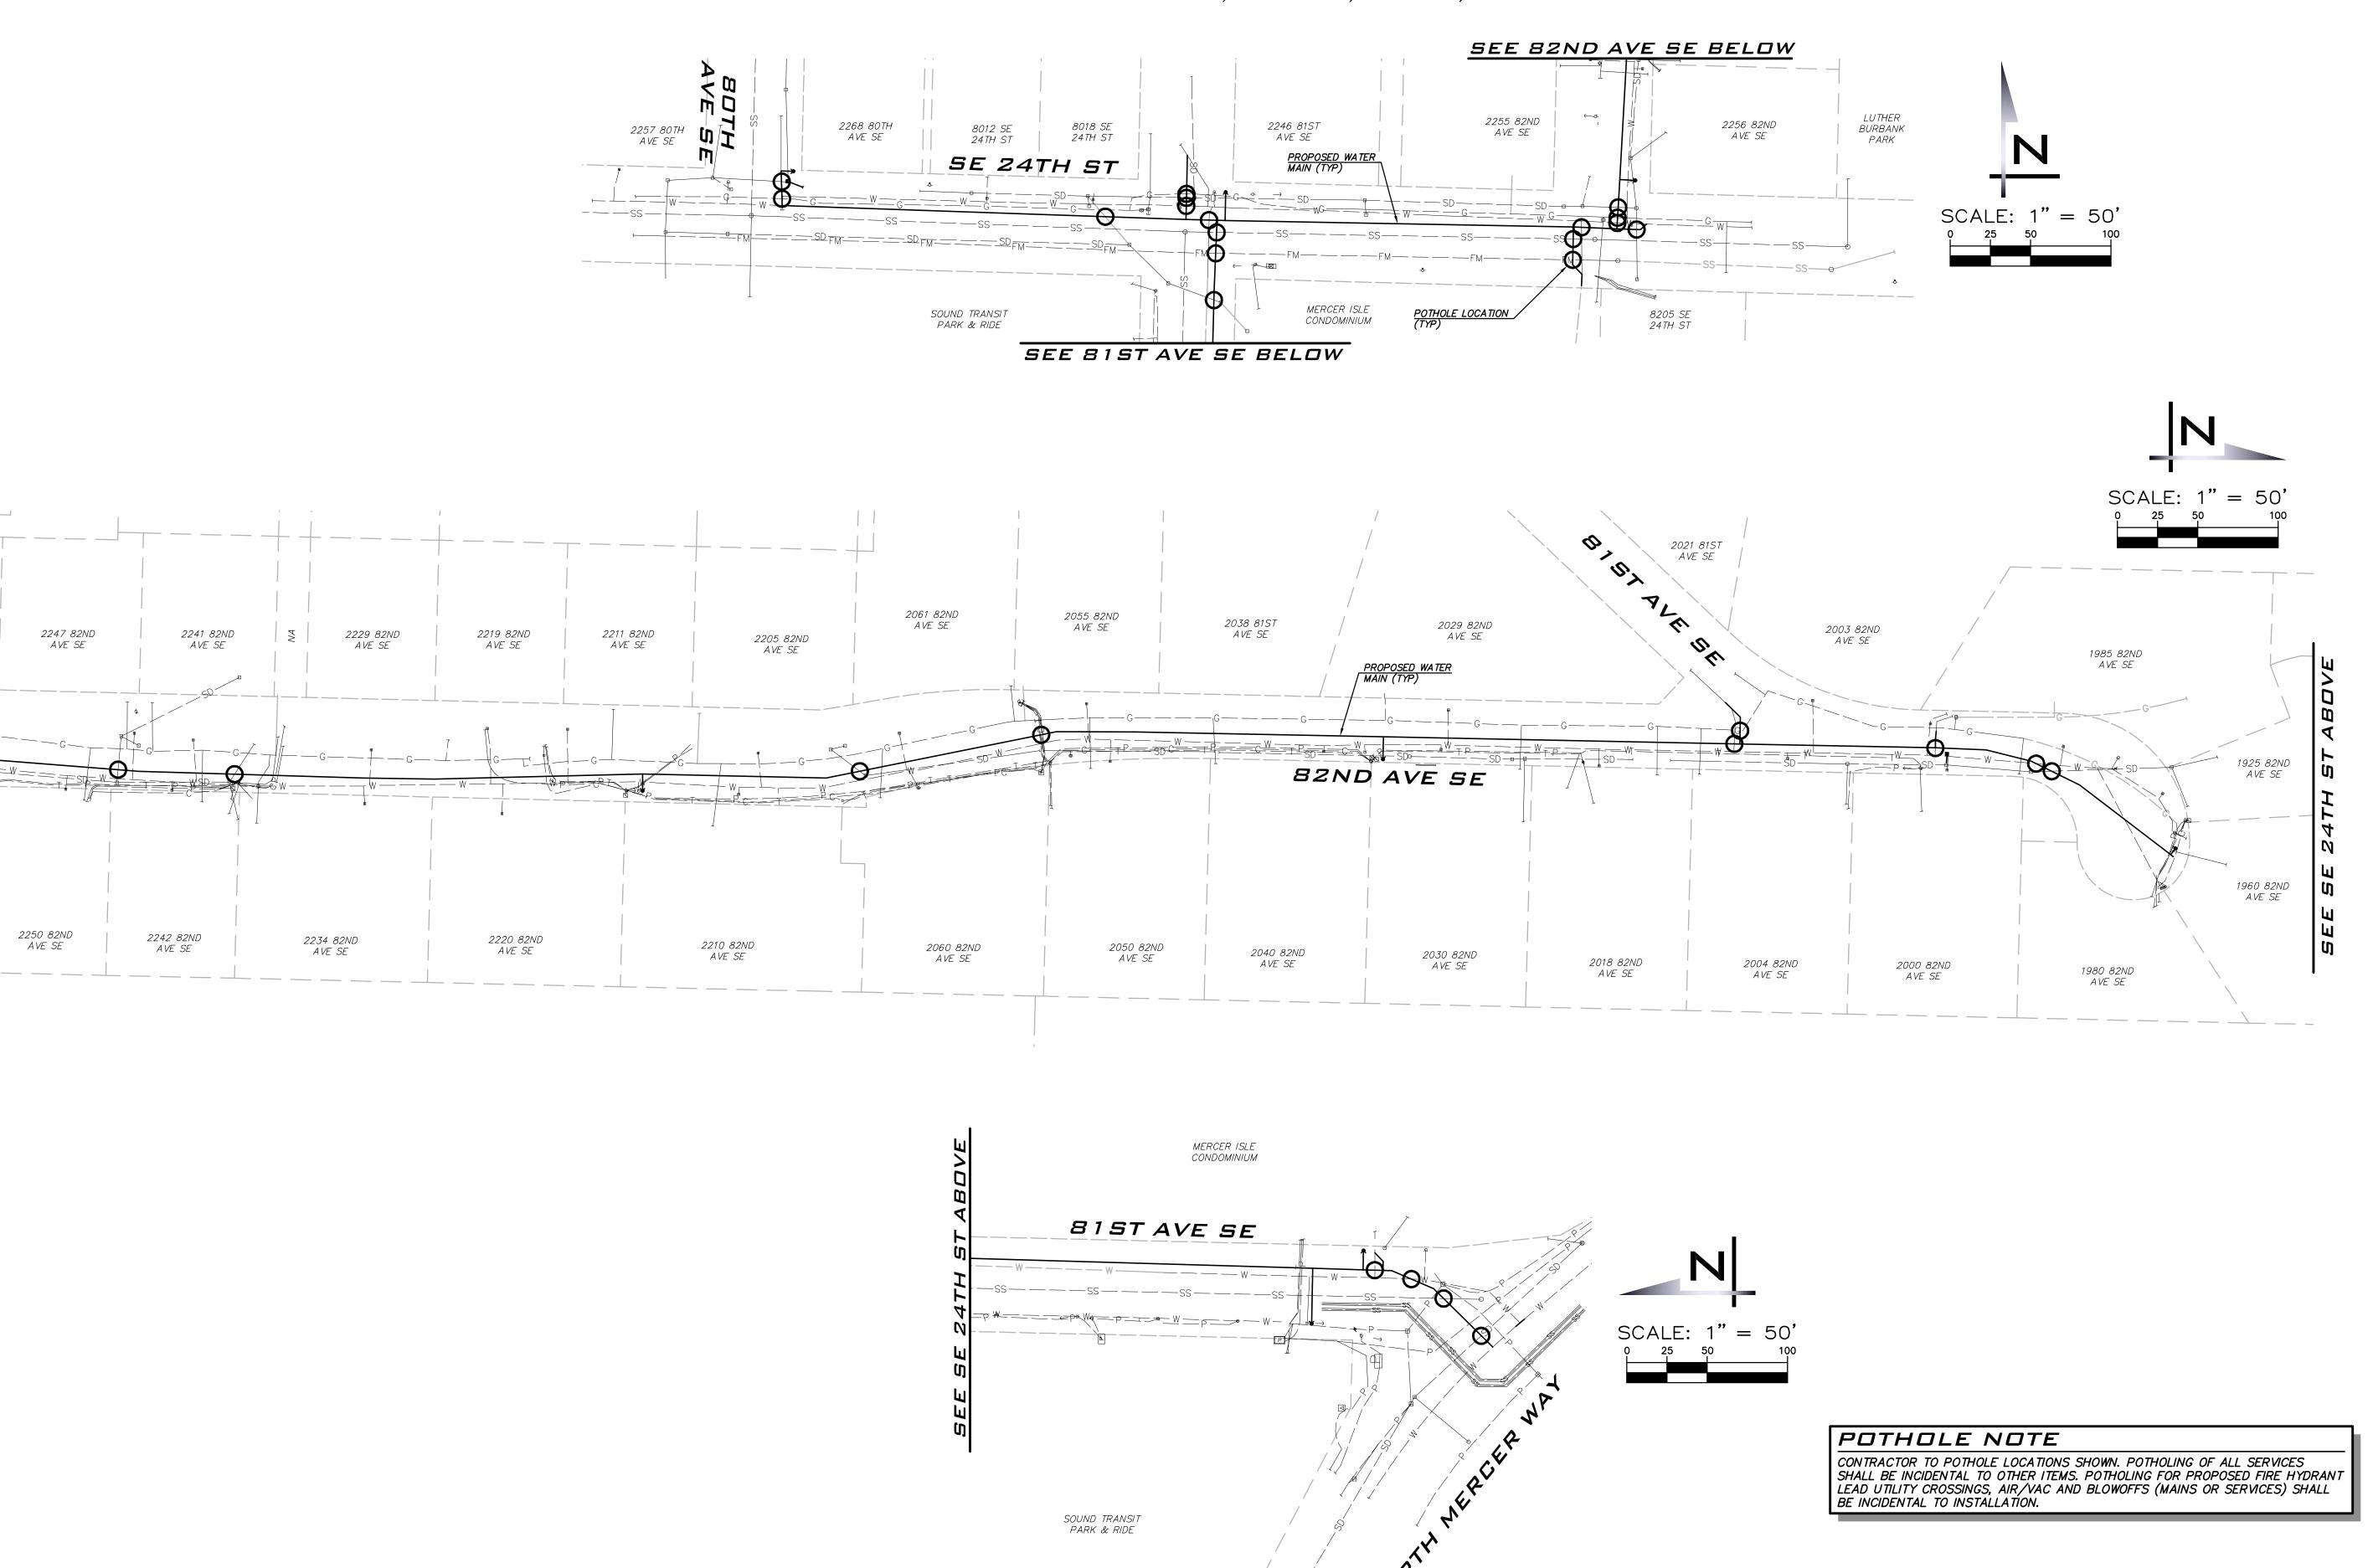

BLUELINE

25 CENTRAL WAY, SUITE 400, KIRKLAND, WA 98033 P: 425.216.4051 F: 425.216.4052 WWW.THEBLUELINEGROUP.COM

SCALE: AS NOTED

PROJECT MANAGER: DEANNA L. MARTIN, PE

PROJECT ENGINEER:
GRACE GARWIN, EIT

DESIGNER:

CAROL DOGGETT
ISSUE DATE:
2/23/2021

DATE BY REVISIONS

POTHOLING PLAN

21 WATER SYSTEM

OVEMENTS PROJECT


WASH ALL MAP TO THE WASH A


2/23/21


JOB NUMBER: **20-286** 


> SHEET NAME: **PH-01**

нт <u>9</u> ог <u>26</u>

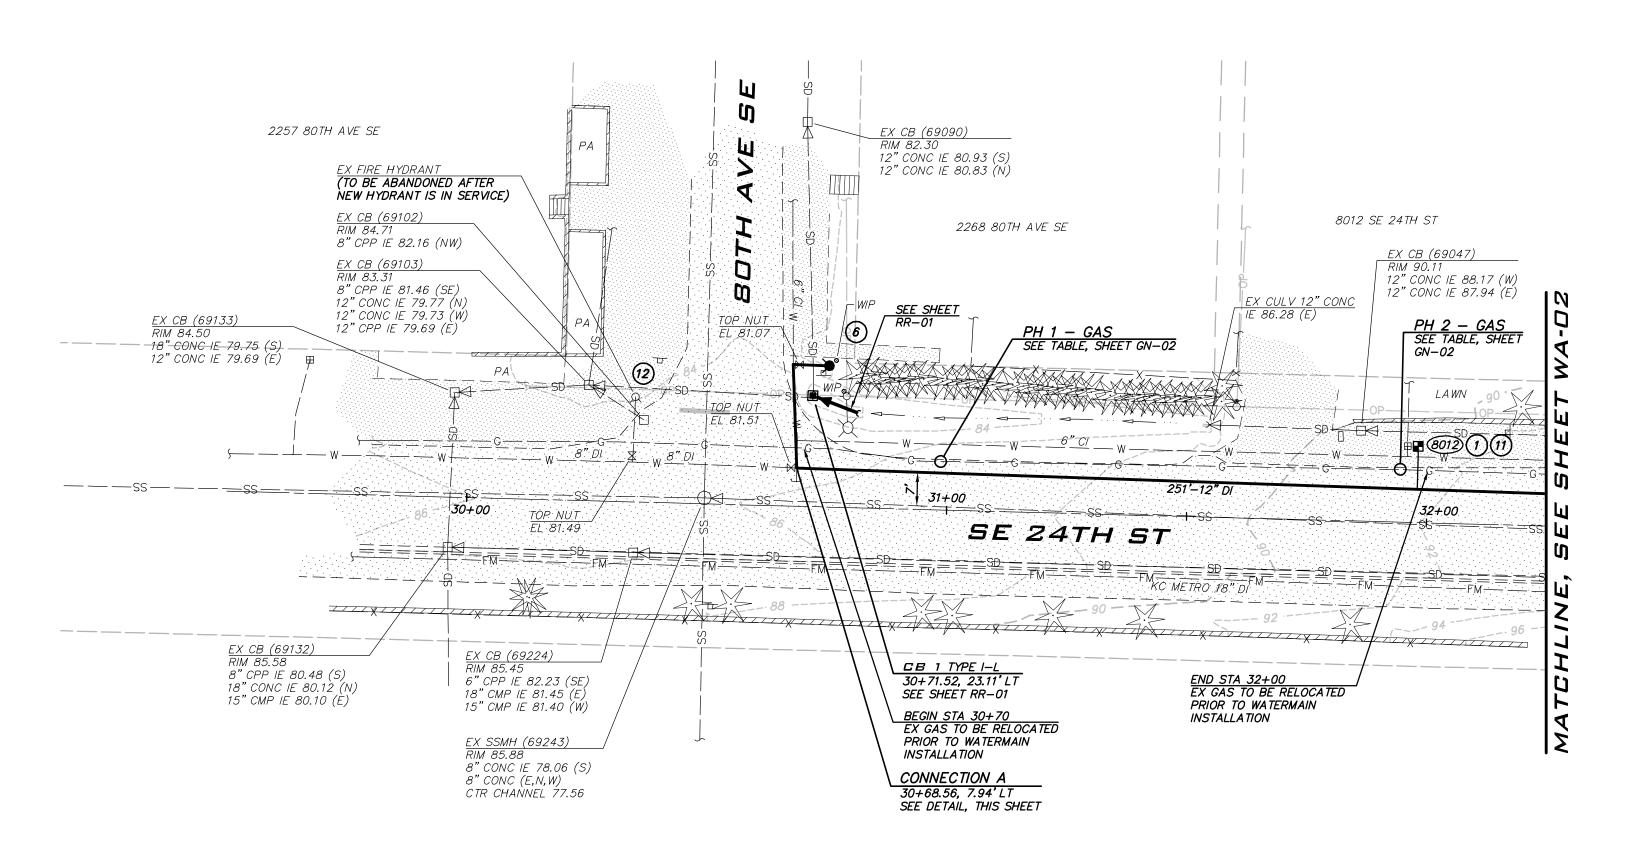

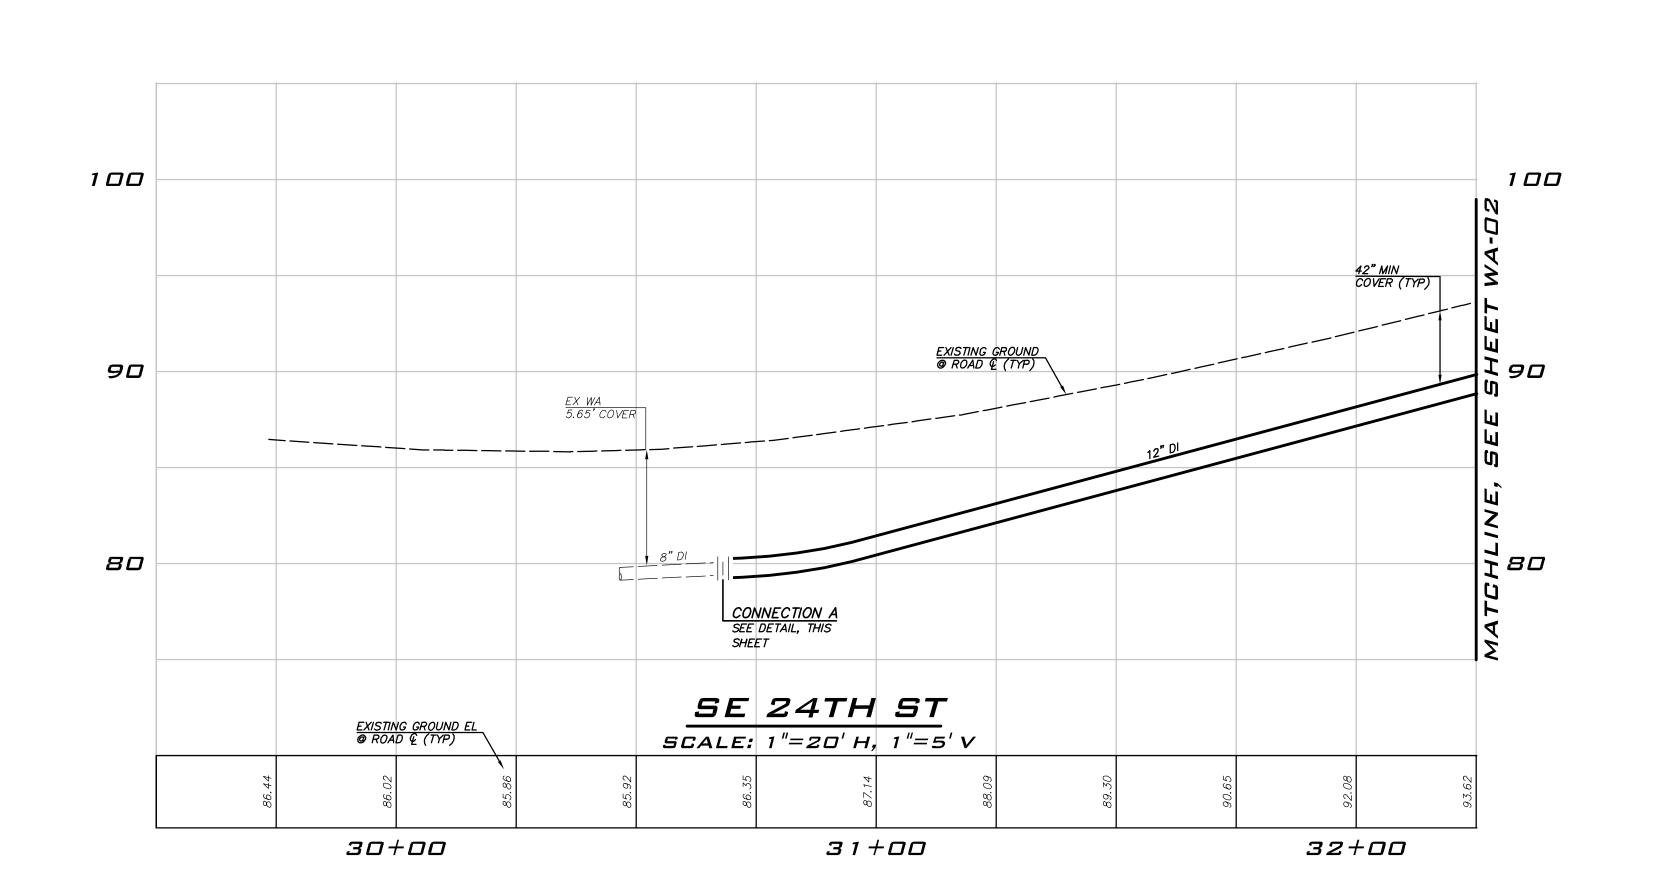


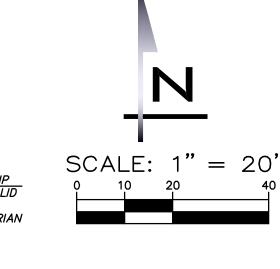

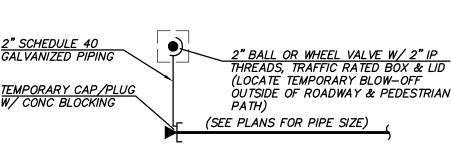


### 2" TEMPORARY BLOW-OFF

NOT TO SCALE

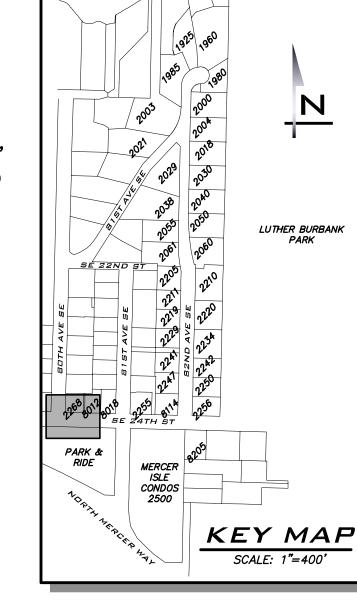

### TESTING CONNECTION

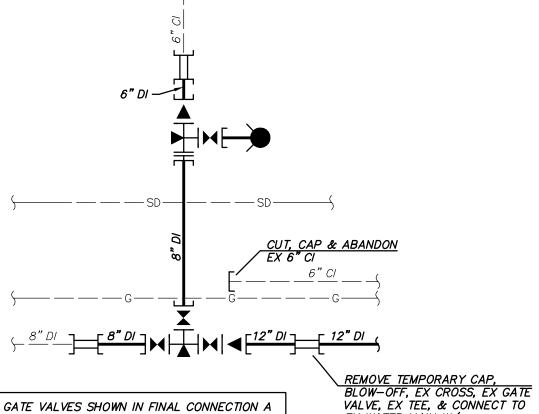

EX WATER MAIN W/ 1–8" TEE, FL

1-12" SLEEVE, MJ

1-8" SLEEVE, MJ

W/ FL TEE

1-8" ADAPTER, FLxMJ

W/ CONC BLOCKING

2-8" GATE VALVE, FLXMJ

1-8" GATE VALVE, FL 1-12"x8" REDUCER, FLxMJ

1-12" DI SPOOL, LENGTH TO FIT

2-8" DI SPOOL, LENGTH TO FIT

1-FIRE HYDRANT ASSEMBLY

1-8"x6" REDUCER, FLxMJ 1-6" SLEEVE, MJ 1-6" SPOOL, LENGTH TO FIT

PER COMI STD DTL W-24

GATE VALVES SHOWN IN FINAL CONNECTION A DETAIL WILL BE PAID UNDER CONNECTION A TO EXISTING WATER SYSTEM BID ITEM A37. FIRE HYDRANT ASSEMBLY INCLUDING VALVE WILL BE PAID UNDER BID ITEM A30, INSTALL NEW FIRE HYDRANT ASSEMBLY.

FINAL CONNECTION

CONNECTION A NOT TO SCALE

### CONTRACTORS SHALL POTHOLE EXISTING UTILITIES PRIOR TO BEGINNING CONSTRUCTION TO VERIFY DEPTHS AND HORIZONTAL ALIGNMENT AT CROSSINGS AND CONNECTIONS.

### NOTES 1 INSTALL 1" SHORT SIDE WATER SERVICE PER STD DETAIL W-13 AND AS DESCRIBED IN PROJECT SPECIFICATIONS.

(SEE NOTES 9 & 10 BELOW)

CONSTRUCTION NOTES

ALL MECHANICAL JOINT FITTINGS SHALL BE RESTRAINED WITH

COORDINATE VALVE SHUTOFFS WITH CITY FOR ALL WATER MAIN CONNECTIONS. CITY STAFF SHALL OPERATE ALL WATER SYSTEM VALVES. CONTRACTOR NOT ALLOWED TO OPERATE VALVES.

WHERE SPECIFICALLY CALLED OUT IN PROFILE.

WATER MAIN WHERE SEPARATION IS LESS THAN 6".

MEGALUGS. FIELD LOK GASKETS SHALL ONLY BE INSTALLED AT PIPE JOINTS IN FIRE HYDRANT LEADS LONGER THAN ONE PIPE SEGMENT OR

MAINTAIN 18" SEPARATION BETWEEN WATER MAIN AND OTHER UTILITIES. INSTALL ETHAFOAM 220 PAD TO PREVENT UTILITIES FROM BEARING ON

LOCATION AND DEPTHS OF EXISTING UTILITIES ARE APPROXIMATE AND BASED ON THE BEST AVAILABLE DATA AT THE TIME OF DESIGN.

- 2 INSTALL 1" LONG SIDE WATER SERVICE PER STD DETAIL W-13 AND AS DESCRIBED IN PROJECT SPECIFICATIONS. (SEE NOTES 9 & 10 BELOW)
- 3 INSTALL 2" SHORT SIDE WATER SERVICE FOR 1-1/2" METER PER STD DETAIL W-14 AND AS DESCRIBED IN PROJECT SPECIFICATIONS. (SEE NOTES 9 & 10 BELOW)
- INSTALL 2" LONG SIDE WATER SERVICE FOR 1-1/2" METER PER STD
  DETAIL W-14 AND AS DESCRIBED IN PROJECT SPECIFICATIONS. (SEE NOTES 9 & 10 BELOW)
- CONTRACTOR TO POTHOLE TO LOCATE CUSTOMER SIDE SERVICE ON CORRESPONDING PROPERTY. HOLE HOG FROM BACK OF METER TO CONNECT TO EXISTING CUSTOMER SIDE SERVICE WITHIN SERVED
- 6 CONTRACTOR TO POTHOLE EXISTING UTILITIES IN ADVANCE TO SET HYDRANTS WITHOUT USING VERTICAL BENDS.
- REMOVE EXISTING FIRE HYDRANT. CAP OR PLUG AT THE END OF DEXISTING PIPE AS DIRECTED BY THE CITY.
- 8 EXISTING GATE VALVE ON MAIN TO BE ABANDONED. CONTRACTOR TO CLOSE EXISTING VALVE, REMOVE VALVE BOX AND LID TO 1' BELOW GRADE, REPLACE LID AND ADD PVC MARKER THAT READS: "ABANDONED GATE VALVE."
- METER, METER BOX, AND ADDITIONAL INFORMATION ARE PROVIDED ON SHEET GN-03.
- (10) EXACT LOCATION TO BE FIELD VERIFIED BY THE ENGINEER.
- REPLACE EXISTING CONCRETE METER BOX WITH TRAFFIC RATED U METER BOX. CITY TO PROVIDE NEW METER BOX.
- REMOVE EXISTING FIRE HYDRANT, VALVE AND VALVE CAN. CAP THE TEE AT THE MAIN AS DIRECTED BY THE CITY. ALL REMOVED ITEMS SHALL BE RETURNED TO THE CITY OF MERCER ISLAND.

### EXISTING UTILITY NOTE

EXISTING UTILITIES ARE SHOWN IN THE APPROXIMATE LOCATION. THERE IS NO GUARANTEE THAT ALL UTILITY LINES ARE SHOWN, OR THAT THE LOCATION, SIZE AND MATERIAL IS ACCURATE. THE CONTRACTOR SHALL UNCOVER ALL INDICATED PIPING WHERE CROSSING, INTERFERENCES, OR CONNECTIONS OCCUR PRIOR TO TRENCHING OR EXCAVATION FOR ANY PIPE OR STRUCTURES, TO DETERMINE ACTUAL LOCATIONS, SIZE AND MATERIAL. THE CONTRACTOR SHALL MAKE THE APPROPRIATE PROVISION FOR PROTECTION OF SAID FACILITIES. THE CONTRACTOR SHALL NOTIFY ONE CALL AT 8-1-1 (WASHINGTON811.COM) AND ARRANGE FOR FIELD LOCATION OF EXISTING FACILITIES BEFORE CONSTRUCTION.

### KIRKLAND, WA 98033 P: 425.216.4051 F: 425.216.4052 WWW.THEBLUELINEGROUP.COM AS NOTED LUTHER BURBANK PROJECT MANAGER: DEANNA L. MARTIN, PE PROJECT ENGINEER: GRACE GARWIN, EIT DESIGNER: CAROL DOGGETT ISSUE DATE: 2/23/2021

BLUELINE


25 CENTRAL WAY, SUITE 400,


2/23/21


20-286


SHEET NAME: WA-□ 1

sнт <u>10</u> ог <u>26</u>

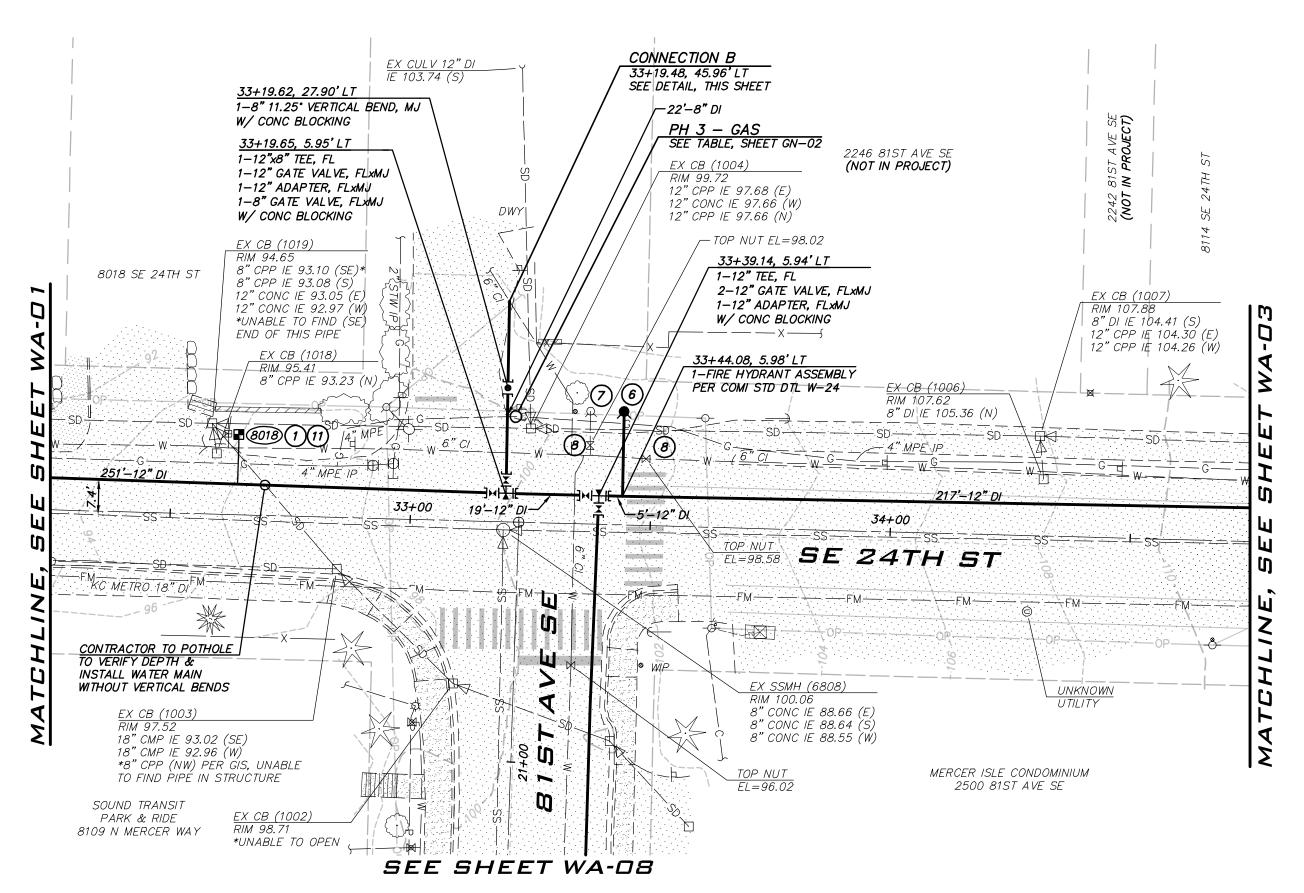

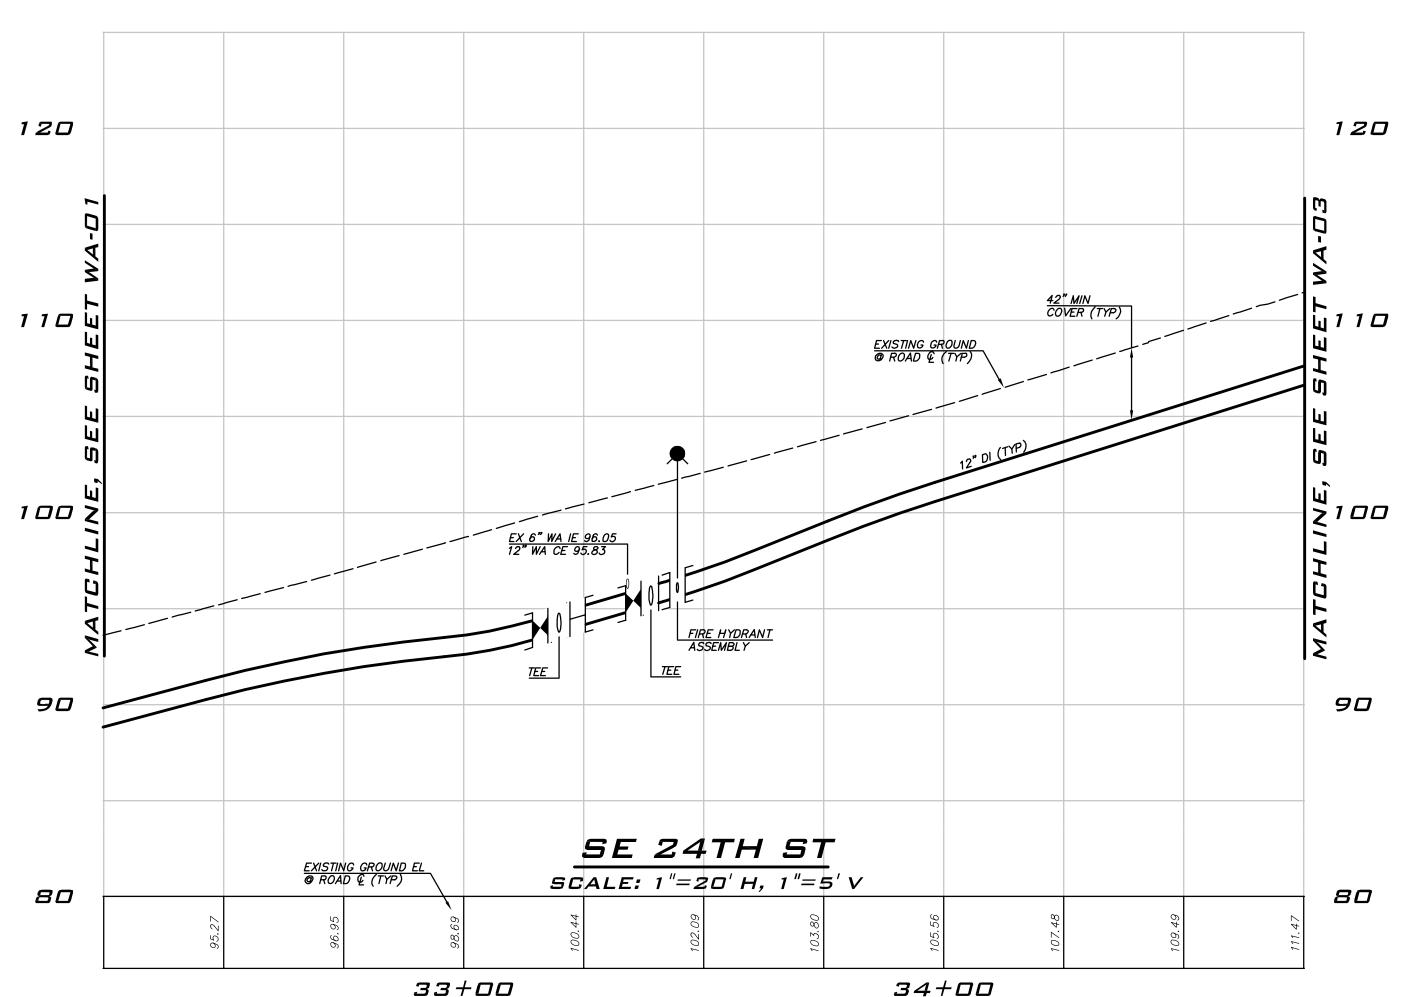

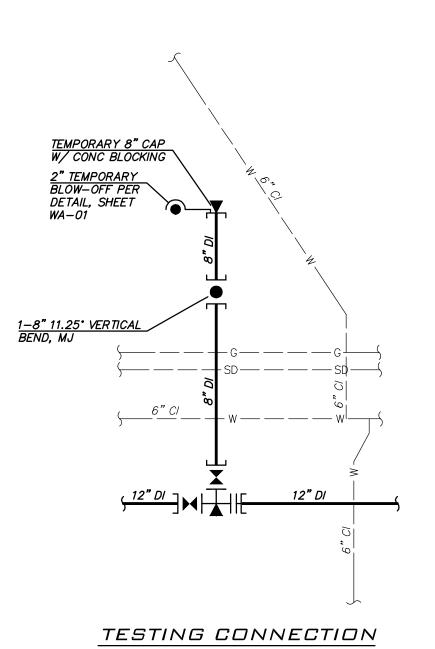


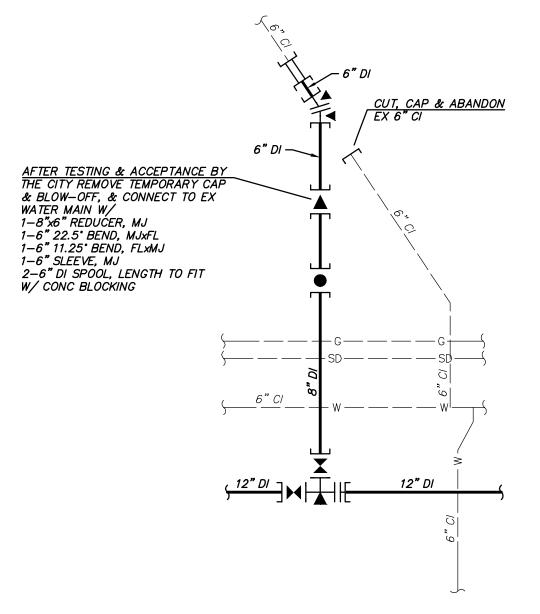

FINAL CONNECTION

CONNECTION B

NOT TO SCALE

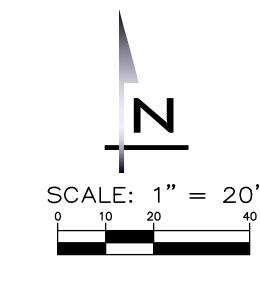



### CONSTRUCTION NOTES


- 1. ALL MECHANICAL JOINT FITTINGS SHALL BE RESTRAINED WITH MEGALUGS. FIELD LOK GASKETS SHALL ONLY BE INSTALLED AT PIPE JOINTS IN FIRE HYDRANT LEADS LONGER THAN ONE PIPE SEGMENT OR WHERE SPECIFICALLY CALLED OUT IN PROFILE.
- MAINTAIN 18" SEPARATION BETWEEN WATER MAIN AND OTHER UTILITIES.
  INSTALL ETHAFOAM 220 PAD TO PREVENT UTILITIES FROM BEARING ON
  WATER MAIN WHERE SEPARATION IS LESS THAN 6".
- 3. COORDINATE VALVE SHUTOFFS WITH CITY FOR ALL WATER MAIN CONNECTIONS. CITY STAFF SHALL OPERATE ALL WATER SYSTEM VALVES. CONTRACTOR NOT ALLOWED TO OPERATE VALVES.
- LOCATION AND DEPTHS OF EXISTING UTILITIES ARE APPROXIMATE AND BASED ON THE BEST AVAILABLE DATA AT THE TIME OF DESIGN.
  CONTRACTORS SHALL POTHOLE EXISTING UTILITIES PRIOR TO BEGINNING CONSTRUCTION TO VERIFY DEPTHS AND HORIZONTAL ALIGNMENT AT CROSSINGS AND CONNECTIONS.

### NOTES

- INSTALL 1" SHORT SIDE WATER SERVICE PER STD DETAIL W-13 AND AS DESCRIBED IN PROJECT SPECIFICATIONS.
  (SEE NOTES 9 & 10 BELOW)
- 2 INSTALL 1" LONG SIDE WATER SERVICE PER STD DETAIL W-13 AND AS DESCRIBED IN PROJECT SPECIFICATIONS. (SEE NOTES 9 & 10 BELOW)
- INSTALL 2" SHORT SIDE WATER SERVICE FOR 1-1/2" METER PER STD DETAIL W-14 AND AS DESCRIBED IN PROJECT SPECIFICATIONS. (SEE NOTES 9 & 10 BELOW)
- INSTALL 2" LONG SIDE WATER SERVICE FOR 1-1/2" METER PER STD
  DETAIL W-14 AND AS DESCRIBED IN PROJECT SPECIFICATIONS.
  (SEE NOTES 9 & 10 BELOW)
- 5 CONTRACTOR TO POTHOLE TO LOCATE CUSTOMER SIDE SERVICE ON CORRESPONDING PROPERTY. HOLE HOG FROM BACK OF METER TO CONNECT TO EXISTING CUSTOMER SIDE SERVICE WITHIN SERVED PROPERTY.
- 6 CONTRACTOR TO POTHOLE EXISTING UTILITIES IN ADVANCE TO SET HYDRANTS WITHOUT USING VERTICAL BENDS.
- REMOVE EXISTING FIRE HYDRANT. CAP OR PLUG AT THE END OF EXISTING PIPE AS DIRECTED BY THE CITY.
- 8 EXISTING GATE VALVE ON MAIN TO BE ABANDONED. CONTRACTOR TO CLOSE EXISTING VALVE, REMOVE VALVE BOX AND LID TO 1' BELOW GRADE, REPLACE LID AND ADD PVC MARKER THAT READS: "ABANDONED GATE VALVE."
- METER, METER BOX, AND ADDITIONAL INFORMATION ARE PROVIDED ON SHEET GN-03.
- (10) EXACT LOCATION TO BE FIELD VERIFIED BY THE ENGINEER.
- REPLACE EXISTING CONCRETE METER BOX WITH TRAFFIC RATED METER BOX. CITY TO PROVIDE NEW METER BOX.
- REMOVE EXISTING FIRE HYDRANT, VALVE AND VALVE CAN. CAP THE TEE AT THE MAIN AS DIRECTED BY THE CITY. ALL REMOVED ITEMS SHALL BE RETURNED TO THE CITY OF MERCER ISLAND.

### EXISTING UTILITY NOTE

EXISTING UTILITIES ARE SHOWN IN THE APPROXIMATE LOCATION. THERE IS NO GUARANTEE THAT ALL UTILITY LINES ARE SHOWN, OR THAT THE LOCATION, SIZE AND MATERIAL IS ACCURATE. THE CONTRACTOR SHALL UNCOVER ALL INDICATED PIPING WHERE CROSSING, INTERFERENCES, OR CONNECTIONS OCCUR PRIOR TO TRENCHING OR EXCAVATION FOR ANY PIPE OR STRUCTURES, TO DETERMINE ACTUAL LOCATIONS, SIZE AND MATERIAL. THE CONTRACTOR SHALL MAKE THE APPROPRIATE PROVISION FOR PROTECTION OF SAID FACILITIES. THE CONTRACTOR SHALL NOTIFY ONE CALL AT 8-1-1 (WASHINGTON811.COM) AND ARRANGE FOR FIELD LOCATION OF EXISTING FACILITIES BEFORE CONSTRUCTION.

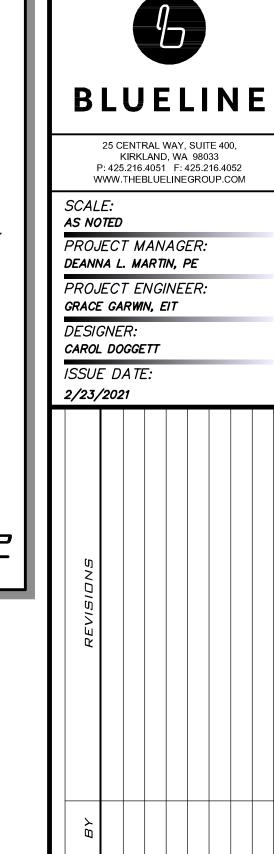

2021 WATER SYSTEM MPROVEMENTS PROJECT


TO WASH A L. MAD TO THE WASH A L. WA


2/23/21

JOB NUMBE


20-286 SHEET NAME: WA-02

sнт <u>11</u> ог <u>26</u>

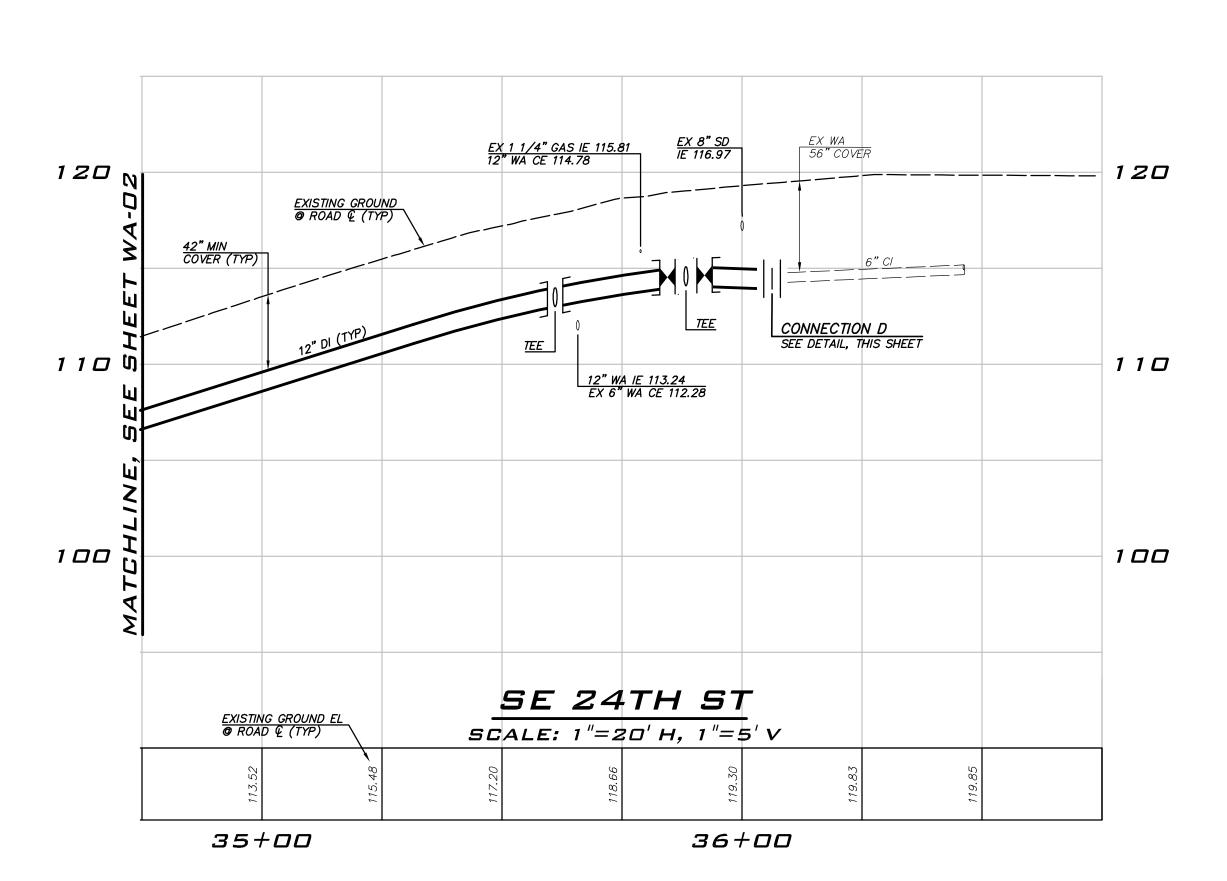


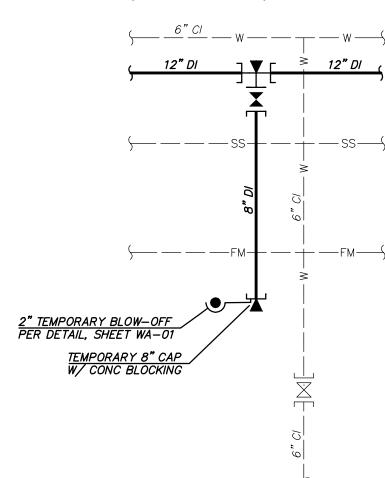


### TESTING CONNECTION

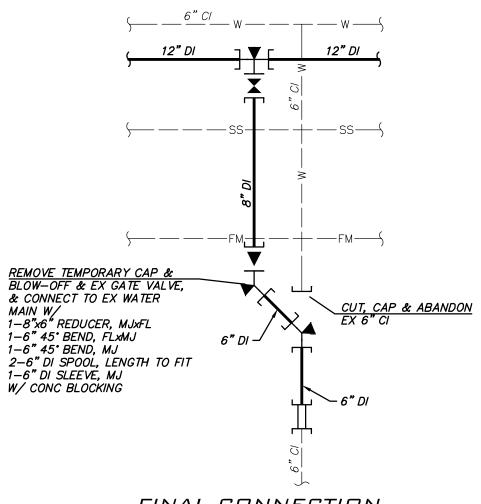

## FINAL CONNECTION CONNECTION C NOT TO SCALE

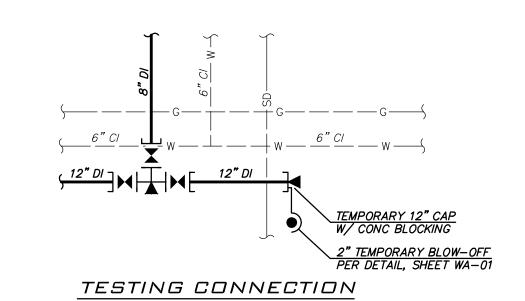


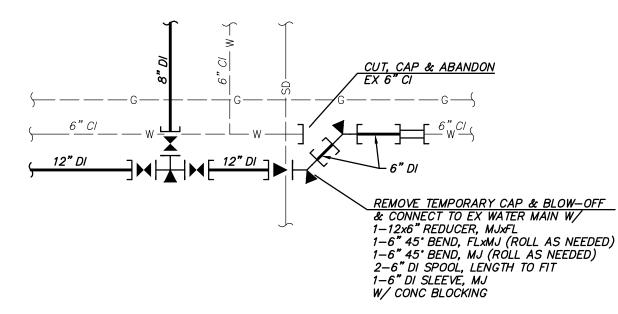


FINAL CONNECTION

CONNECTION D

NOT TO SCALE

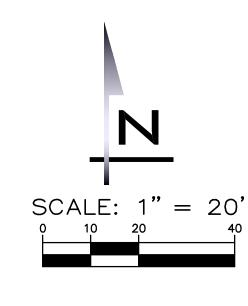

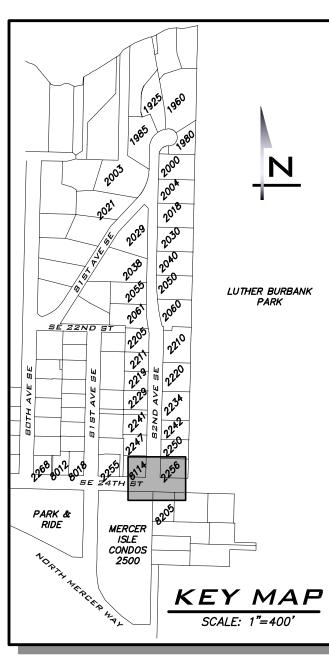

### CONSTRUCTION NOTES


- 1. ALL MECHANICAL JOINT FITTINGS SHALL BE RESTRAINED WITH MEGALUGS. FIELD LOK GASKETS SHALL ONLY BE INSTALLED AT PIPE JOINTS IN FIRE HYDRANT LEADS LONGER THAN ONE PIPE SEGMENT OR WHERE SPECIFICALLY CALLED OUT IN PROFILE.
- MAINTAIN 18" SEPARATION BETWEEN WATER MAIN AND OTHER UTILITIES.
  INSTALL ETHAFOAM 220 PAD TO PREVENT UTILITIES FROM BEARING ON
  WATER MAIN WHERE SEPARATION IS LESS THAN 6".
- 3. COORDINATE VALVE SHUTOFFS WITH CITY FOR ALL WATER MAIN CONNECTIONS. CITY STAFF SHALL OPERATE ALL WATER SYSTEM VALVES. CONTRACTOR NOT ALLOWED TO OPERATE VALVES.
- LOCATION AND DEPTHS OF EXISTING UTILITIES ARE APPROXIMATE AND BASED ON THE BEST AVAILABLE DATA AT THE TIME OF DESIGN.
  CONTRACTORS SHALL POTHOLE EXISTING UTILITIES PRIOR TO BEGINNING CONSTRUCTION TO VERIFY DEPTHS AND HORIZONTAL ALIGNMENT AT CROSSINGS AND CONNECTIONS.

### NOTES

- 1) INSTALL 1" SHORT SIDE WATER SERVICE PER STD DETAIL W-13 AND AS DESCRIBED IN PROJECT SPECIFICATIONS.
  (SEE NOTES 9 & 10 BELOW)
- 2 INSTALL 1" LONG SIDE WATER SERVICE PER STD DETAIL W-13 AND AS DESCRIBED IN PROJECT SPECIFICATIONS. (SEE NOTES 9 & 10 BELOW)
- INSTALL 2" SHORT SIDE WATER SERVICE FOR 1-1/2" METER PER STD DETAIL W-14 AND AS DESCRIBED IN PROJECT SPECIFICATIONS. (SEE NOTES 9 & 10 BELOW)
- INSTALL 2" LONG SIDE WATER SERVICE FOR 1-1/2" METER PER STD DETAIL W-14 AND AS DESCRIBED IN PROJECT SPECIFICATIONS. (SEE NOTES 9 & 10 BELOW)
- 5 CONTRACTOR TO POTHOLE TO LOCATE CUSTOMER SIDE SERVICE ON CORRESPONDING PROPERTY. HOLE HOG FROM BACK OF METER TO CONNECT TO EXISTING CUSTOMER SIDE SERVICE WITHIN SERVED PROPERTY
- 6 CONTRACTOR TO POTHOLE EXISTING UTILITIES IN ADVANCE TO SET HYDRANTS WITHOUT USING VERTICAL BENDS.
- REMOVE EXISTING FIRE HYDRANT. CAP OR PLUG AT THE END OF EXISTING PIPE AS DIRECTED BY THE CITY.
- 8 EXISTING GATE VALVE ON MAIN TO BE ABANDONED. CONTRACTOR TO CLOSE EXISTING VALVE, REMOVE VALVE BOX AND LID TO 1' BELOW GRADE, REPLACE LID AND ADD PVC MARKER THAT READS: "ABANDONED GATE VALVE."
- METER, METER BOX, AND ADDITIONAL INFORMATION ARE PROVIDED ON SHEET GN-03.
- (10) EXACT LOCATION TO BE FIELD VERIFIED BY THE ENGINEER.
- 11) REPLACE EXISTING CONCRETE METER BOX WITH TRAFFIC RATED METER BOX. CITY TO PROVIDE NEW METER BOX.
- REMOVE EXISTING FIRE HYDRANT, VALVE AND VALVE CAN. CAP THE TEE AT THE MAIN AS DIRECTED BY THE CITY. ALL REMOVED ITEMS SHALL BE RETURNED TO THE CITY OF MERCER ISLAND.

### EXISTING UTILITY NOTE

EXISTING UTILITIES ARE SHOWN IN THE APPROXIMATE LOCATION. THERE IS NO GUARANTEE THAT ALL UTILITY LINES ARE SHOWN, OR THAT THE LOCATION, SIZE AND MATERIAL IS ACCURATE. THE CONTRACTOR SHALL UNCOVER ALL INDICATED PIPING WHERE CROSSING, INTERFERENCES, OR CONNECTIONS OCCUR PRIOR TO TRENCHING OR EXCAVATION FOR ANY PIPE OR STRUCTURES, TO DETERMINE ACTUAL LOCATIONS, SIZE AND MATERIAL. THE CONTRACTOR SHALL MAKE THE APPROPRIATE PROVISION FOR PROTECTION OF SAID FACILITIES. THE CONTRACTOR SHALL NOTIFY ONE CALL AT 8-1-1 (WASHINGTON811.COM) AND ARRANGE FOR FIELD LOCATION OF EXISTING FACILITIES BEFORE CONSTRUCTION.

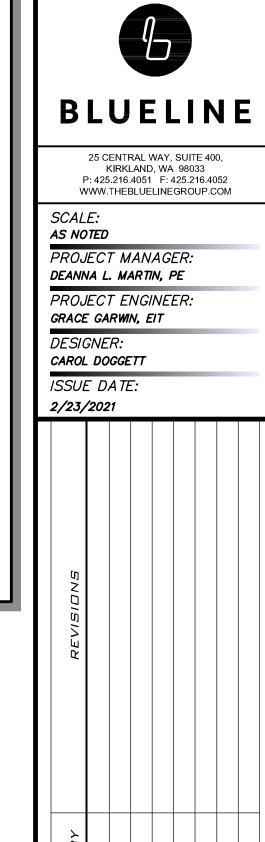


2021 WATER SYSTEM 1PROVEMENTS PROJECT


2/23/21


JOB NUMBER: **20-286** 


SHEET NAME:
WA-03

sнт <u>12</u> оғ <u>26</u>

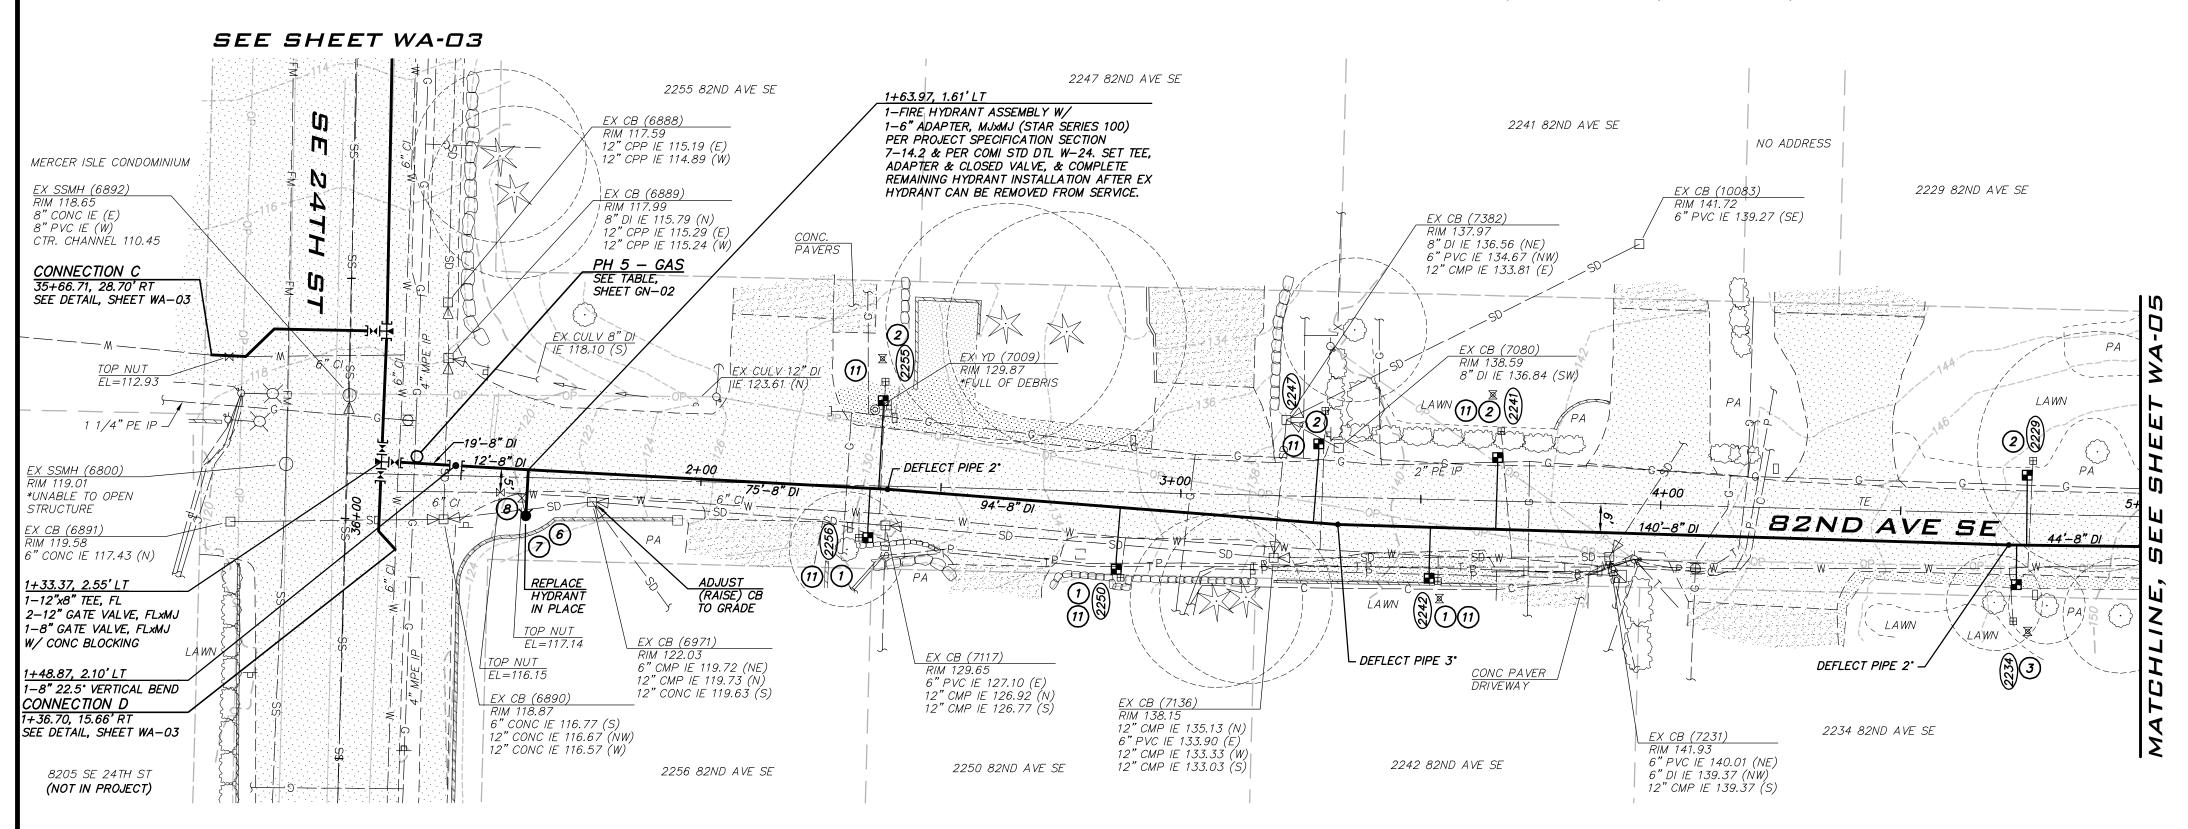

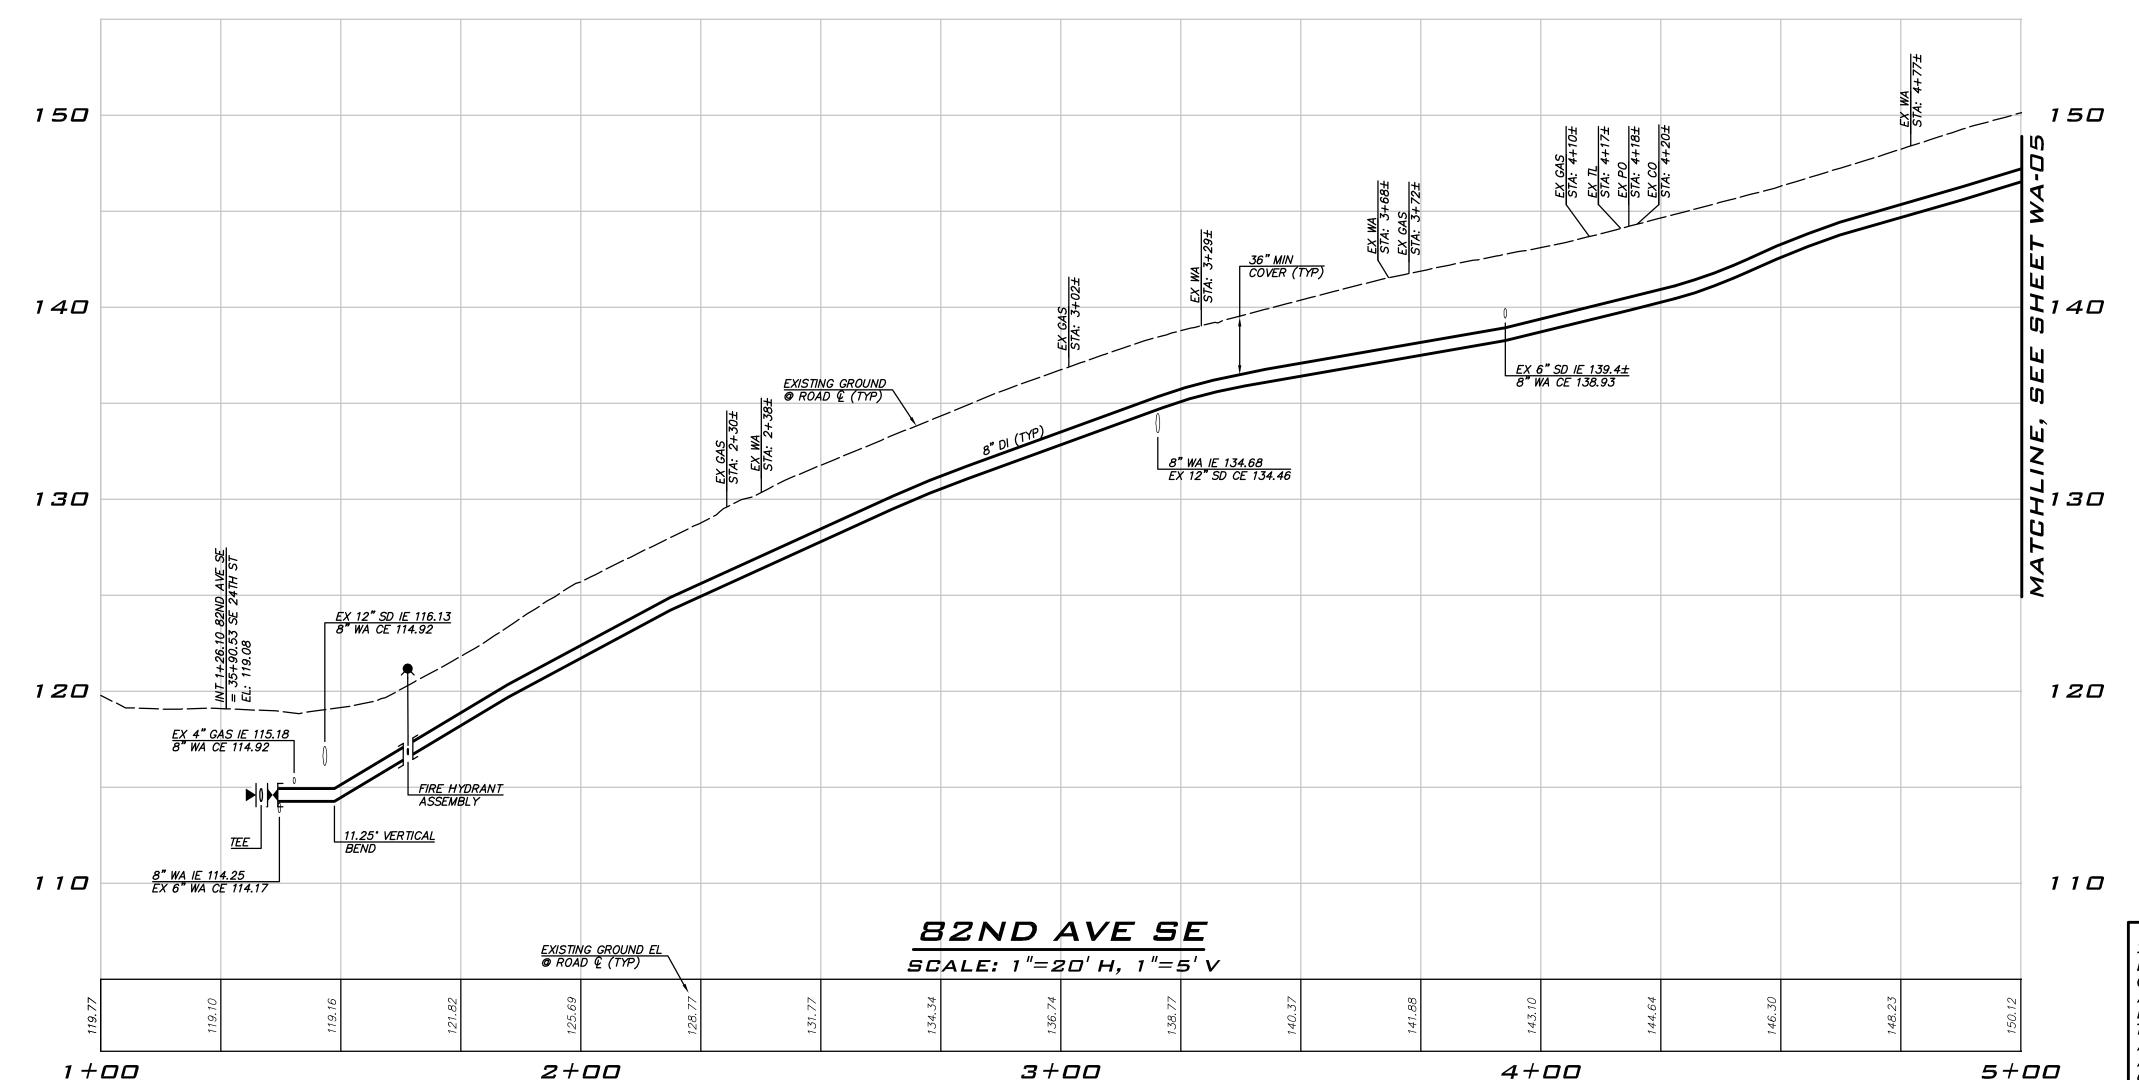

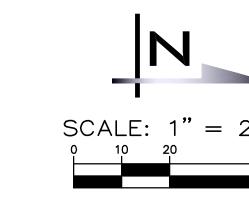

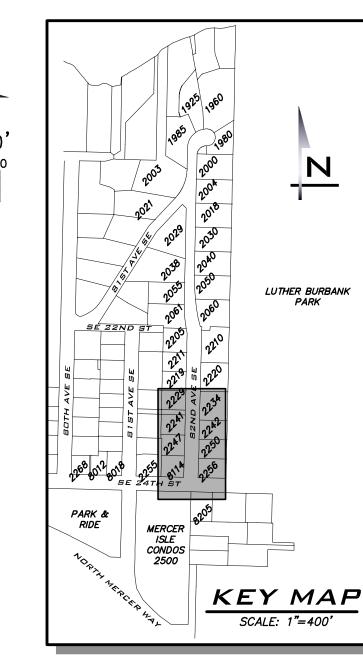

### CONSTRUCTION NOTES


- 1. ALL MECHANICAL JOINT FITTINGS SHALL BE RESTRAINED WITH MEGALUGS. FIELD LOK GASKETS SHALL ONLY BE INSTALLED AT PIPE JOINTS IN FIRE HYDRANT LEADS LONGER THAN ONE PIPE SEGMENT OR WHERE SPECIFICALLY CALLED OUT IN PROFILE.
- P. MAINTAIN 18" SEPARATION BETWEEN WATER MAIN AND OTHER UTILITIES. INSTALL ETHAFOAM 220 PAD TO PREVENT UTILITIES FROM BEARING ON WATER MAIN WHERE SEPARATION IS LESS THAN 6".
- 3. COORDINATE VALVE SHUTOFFS WITH CITY FOR ALL WATER MAIN CONNECTIONS. CITY STAFF SHALL OPERATE ALL WATER SYSTEM VALVES. CONTRACTOR NOT ALLOWED TO OPERATE VALVES.
- LOCATION AND DEPTHS OF EXISTING UTILITIES ARE APPROXIMATE AND BASED ON THE BEST AVAILABLE DATA AT THE TIME OF DESIGN.
  CONTRACTORS SHALL POTHOLE EXISTING UTILITIES PRIOR TO BEGINNING CONSTRUCTION TO VERIFY DEPTHS AND HORIZONTAL ALIGNMENT AT CROSSINGS AND CONNECTIONS.

### NOTES

- INSTALL 1" SHORT SIDE WATER SERVICE PER STD DETAIL W-13 AND AS DESCRIBED IN PROJECT SPECIFICATIONS.
  (SEE NOTES 9 & 10 BELOW)
- 2 INSTALL 1" LONG SIDE WATER SERVICE PER STD DETAIL W-13 AND AS DESCRIBED IN PROJECT SPECIFICATIONS.
  (SEE NOTES 9 & 10 BELOW)
- INSTALL 2" SHORT SIDE WATER SERVICE FOR 1-1/2" METER PER STD DETAIL W-14 AND AS DESCRIBED IN PROJECT SPECIFICATIONS. (SEE NOTES 9 & 10 BELOW)
- INSTALL 2" LONG SIDE WATER SERVICE FOR 1-1/2" METER PER STD
  DETAIL W-14 AND AS DESCRIBED IN PROJECT SPECIFICATIONS.
  (SEE NOTES 9 & 10 BELOW)
- 5 CONTRACTOR TO POTHOLE TO LOCATE CUSTOMER SIDE SERVICE ON CORRESPONDING PROPERTY. HOLE HOG FROM BACK OF METER TO CONNECT TO EXISTING CUSTOMER SIDE SERVICE WITHIN SERVED
- 6 CONTRACTOR TO POTHOLE EXISTING UTILITIES IN ADVANCE TO SET HYDRANTS WITHOUT USING VERTICAL BENDS.
- REMOVE EXISTING FIRE HYDRANT. CAP OR PLUG AT THE END OF EXISTING PIPE AS DIRECTED BY THE CITY.
- 8 EXISTING GATE VALVE ON MAIN TO BE ABANDONED. CONTRACTOR TO CLOSE EXISTING VALVE, REMOVE VALVE BOX AND LID TO 1' BELOW GRADE, REPLACE LID AND ADD PVC MARKER THAT READS: "ABANDONED GATE VALVE."
- METER, METER BOX, AND ADDITIONAL INFORMATION ARE PROVIDED ON SHEET GN-03.
- (10) EXACT LOCATION TO BE FIELD VERIFIED BY THE ENGINEER.
- 11) REPLACE EXISTING CONCRETE METER BOX WITH TRAFFIC RATED METER BOX. CITY TO PROVIDE NEW METER BOX.
- REMOVE EXISTING FIRE HYDRANT, VALVE AND VALVE CAN. CAP THE TEE AT THE MAIN AS DIRECTED BY THE CITY. ALL REMOVED ITEMS SHALL BE RETURNED TO THE CITY OF MERCER ISLAND.

### EXISTING UTILITY NOTE

EXISTING UTILITIES ARE SHOWN IN THE APPROXIMATE LOCATION. THERE IS NO GUARANTEE THAT ALL UTILITY LINES ARE SHOWN, OR THAT THE LOCATION, SIZE AND MATERIAL IS ACCURATE. THE CONTRACTOR SHALL UNCOVER ALL INDICATED PIPING WHERE CROSSING, INTERFERENCES, OR CONNECTIONS OCCUR PRIOR TO TRENCHING OR EXCAVATION FOR ANY PIPE OR STRUCTURES, TO DETERMINE ACTUAL LOCATIONS, SIZE AND MATERIAL. THE CONTRACTOR SHALL MAKE THE APPROPRIATE PROVISION FOR PROTECTION OF SAID FACILITIES. THE CONTRACTOR SHALL NOTIFY ONE CALL AT 8-1-1 (WASHINGTON811.COM) AND ARRANGE FOR FIELD LOCATION OF EXISTING FACILITIES BEFORE CONSTRUCTION.

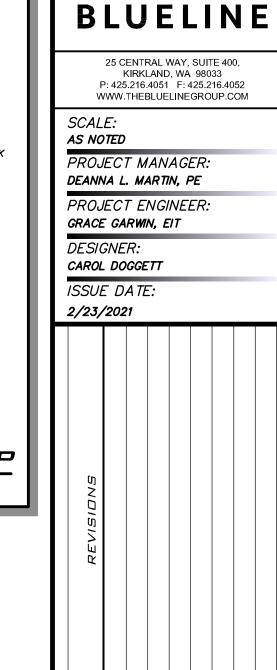


2021 WATER SYSTEM IMPROVEMENTS PROJECT


2/23/21


JOB NUMBER: **20-286** 


SHEET NAME:
WA-D4

sнт **13** ог **26** 

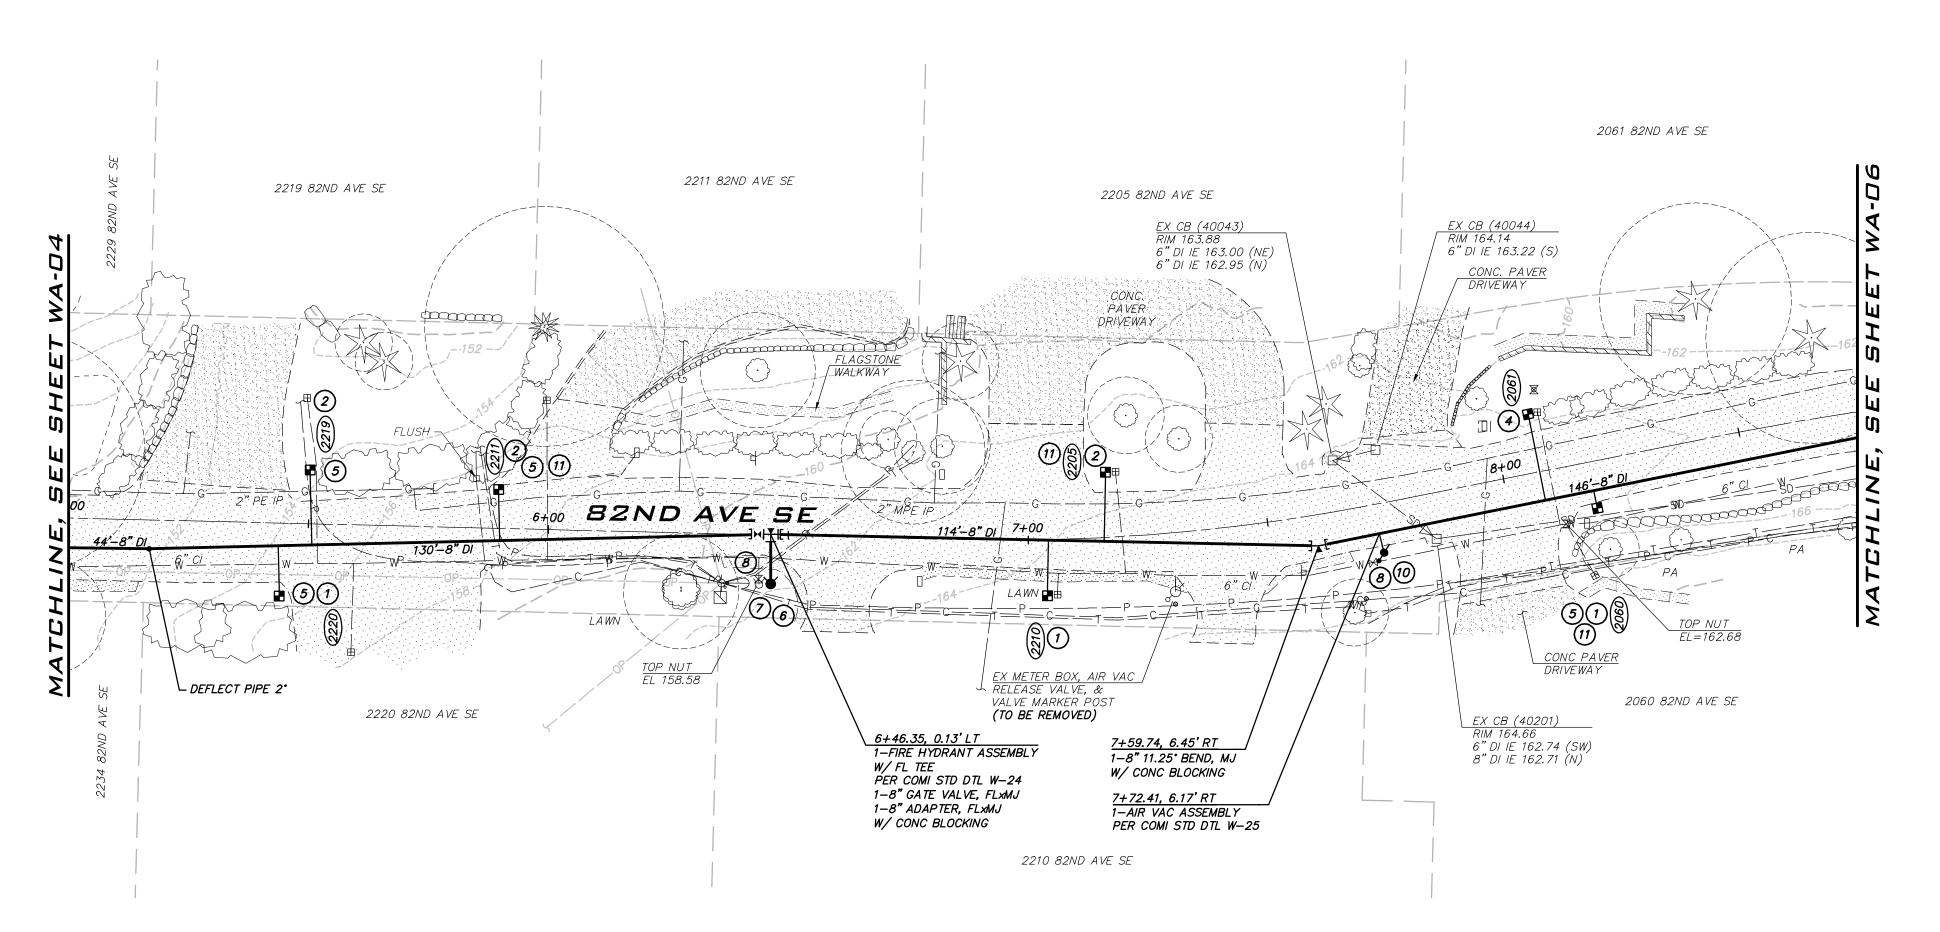

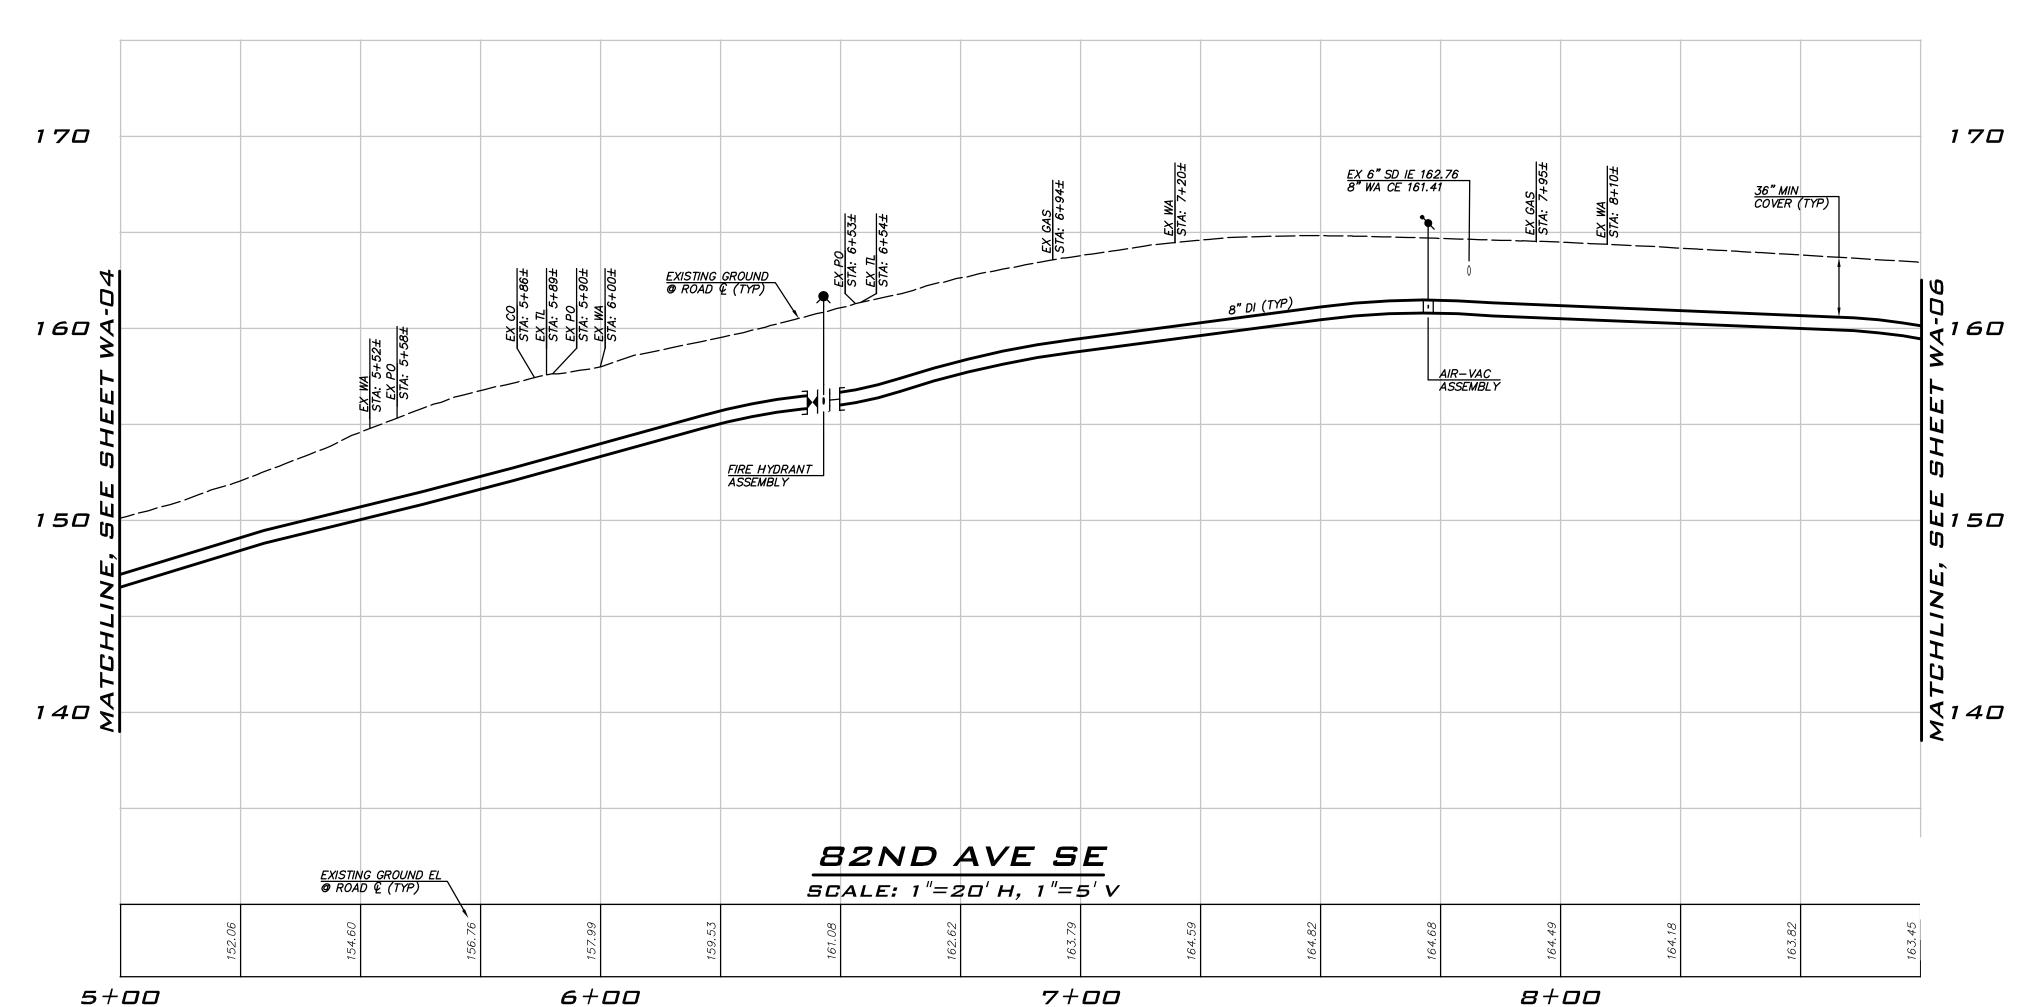

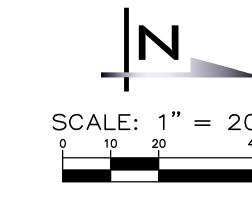

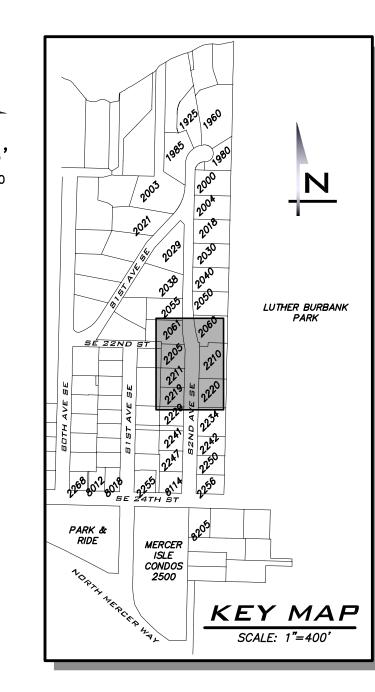

### CONSTRUCTION NOTES


- 1. ALL MECHANICAL JOINT FITTINGS SHALL BE RESTRAINED WITH MEGALUGS. FIELD LOK GASKETS SHALL ONLY BE INSTALLED AT PIPE JOINTS IN FIRE HYDRANT LEADS LONGER THAN ONE PIPE SEGMENT OR WHERE SPECIFICALLY CALLED OUT IN PROFILE.
- 2. MAINTAIN 18" SEPARATION BETWEEN WATER MAIN AND OTHER UTILITIES. INSTALL ETHAFOAM 220 PAD TO PREVENT UTILITIES FROM BEARING ON WATER MAIN WHERE SEPARATION IS LESS THAN 6".
- 3. COORDINATE VALVE SHUTOFFS WITH CITY FOR ALL WATER MAIN CONNECTIONS. CITY STAFF SHALL OPERATE ALL WATER SYSTEM VALVES. CONTRACTOR NOT ALLOWED TO OPERATE VALVES.
- LOCATION AND DEPTHS OF EXISTING UTILITIES ARE APPROXIMATE AND BASED ON THE BEST AVAILABLE DATA AT THE TIME OF DESIGN. CONTRACTORS SHALL POTHOLE EXISTING UTILITIES PRIOR TO BEGINNING CONSTRUCTION TO VERIFY DEPTHS AND HORIZONTAL ALIGNMENT AT CROSSINGS AND CONNECTIONS.

### NOTES

- INSTALL 1" SHORT SIDE WATER SERVICE PER STD DETAIL W-13 AND AS DESCRIBED IN PROJECT SPECIFICATIONS.
  (SEE NOTES 9 & 10 BELOW)
- 2 INSTALL 1" LONG SIDE WATER SERVICE PER STD DETAIL W-13 AND AS DESCRIBED IN PROJECT SPECIFICATIONS. (SEE NOTES 9 & 10 BELOW)
- INSTALL 2" SHORT SIDE WATER SERVICE FOR 1-1/2" METER PER STD DETAIL W-14 AND AS DESCRIBED IN PROJECT SPECIFICATIONS. (SEE NOTES 9 & 10 BELOW)
- 4) INSTALL 2" LONG SIDE WATER SERVICE FOR 1-1/2" METER PER STD DETAIL W-14 AND AS DESCRIBED IN PROJECT SPECIFICATIONS. (SEE NOTES 9 & 10 BELOW)
- CONTRACTOR TO POTHOLE TO LOCATE CUSTOMER SIDE SERVICE ON CORRESPONDING PROPERTY. HOLE HOG FROM BACK OF METER TO CONNECT TO EXISTING CUSTOMER SIDE SERVICE WITHIN SERVED PROPERTY
- 6 CONTRACTOR TO POTHOLE EXISTING UTILITIES IN ADVANCE TO SET HYDRANTS WITHOUT USING VERTICAL BENDS.
- REMOVE EXISTING FIRE HYDRANT. CAP OR PLUG AT THE END OF EXISTING PIPE AS DIRECTED BY THE CITY.
- 8 EXISTING GATE VALVE ON MAIN TO BE ABANDONED. CONTRACTOR TO CLOSE EXISTING VALVE, REMOVE VALVE BOX AND LID TO 1' BELOW GRADE, REPLACE LID AND ADD PVC MARKER THAT READS: "ABANDONED GATE VALVE."
- 9 METER, METER BOX, AND ADDITIONAL INFORMATION ARE PROVIDED ON SHEET GN-03.
- (10) EXACT LOCATION TO BE FIELD VERIFIED BY THE ENGINEER.
- 11 REPLACE EXISTING CONCRETE METER BOX WITH TRAFFIC RATED METER BOX. CITY TO PROVIDE NEW METER BOX.
- 12) REMOVE EXISTING FIRE HYDRANT, VALVE AND VALVE CAN. CAP THE TEE AT THE MAIN AS DIRECTED BY THE CITY. ALL REMOVED ITEMS SHALL BE RETURNED TO THE CITY OF MERCER ISLAND.

### EXISTING UTILITY NOTE

EXISTING UTILITIES ARE SHOWN IN THE APPROXIMATE LOCATION. THERE IS NO GUARANTEE THAT ALL UTILITY LINES ARE SHOWN, OR THAT THE LOCATION, SIZE AND MATERIAL IS ACCURATE. THE CONTRACTOR SHALL UNCOVER ALL INDICATED PIPING WHERE CROSSING, INTERFERENCES, OR CONNECTIONS OCCUR PRIOR TO TRENCHING OR EXCAVATION FOR ANY PIPE OR STRUCTURES, TO DETERMINE ACTUAL LOCATIONS, SIZE AND MATERIAL. THE CONTRACTOR SHALL MAKE THE APPROPRIATE PROVISION FOR PROTECTION OF SAID FACILITIES. THE CONTRACTOR SHALL NOTIFY ONE CALL AT 8-1-1 (WASHINGTON811.COM) AND ARRANGE FOR FIELD LOCATION OF EXISTING FACILITIES BEFORE CONSTRUCTION.

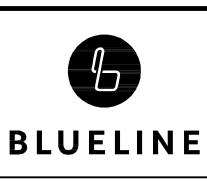

25 CENTRAL WAY, SUITE 400, KIRKLAND, WA 98033 P: 425.216.4051 F: 425.216.4052 WWW.THEBLUELINEGROUP.COM

SCALE: AS NOTED

PROJECT MANAGER:
DEANNA L. MARTIN, PE
PROJECT ENGINEER:

GRACE GARWIN, EIT

DESIGNER:
CAROL DOGGETT

ISSUE DATE:

2/23/2021

DA	DATE	ВУ	REVISIONS

WATER SYSTEM EMENTS PROJECT


WASHING WASHIN


2/23/21


JOB NUMBER: **20-286** 


SHEET NAME:
WA-05

sнт **14** ог **26** 

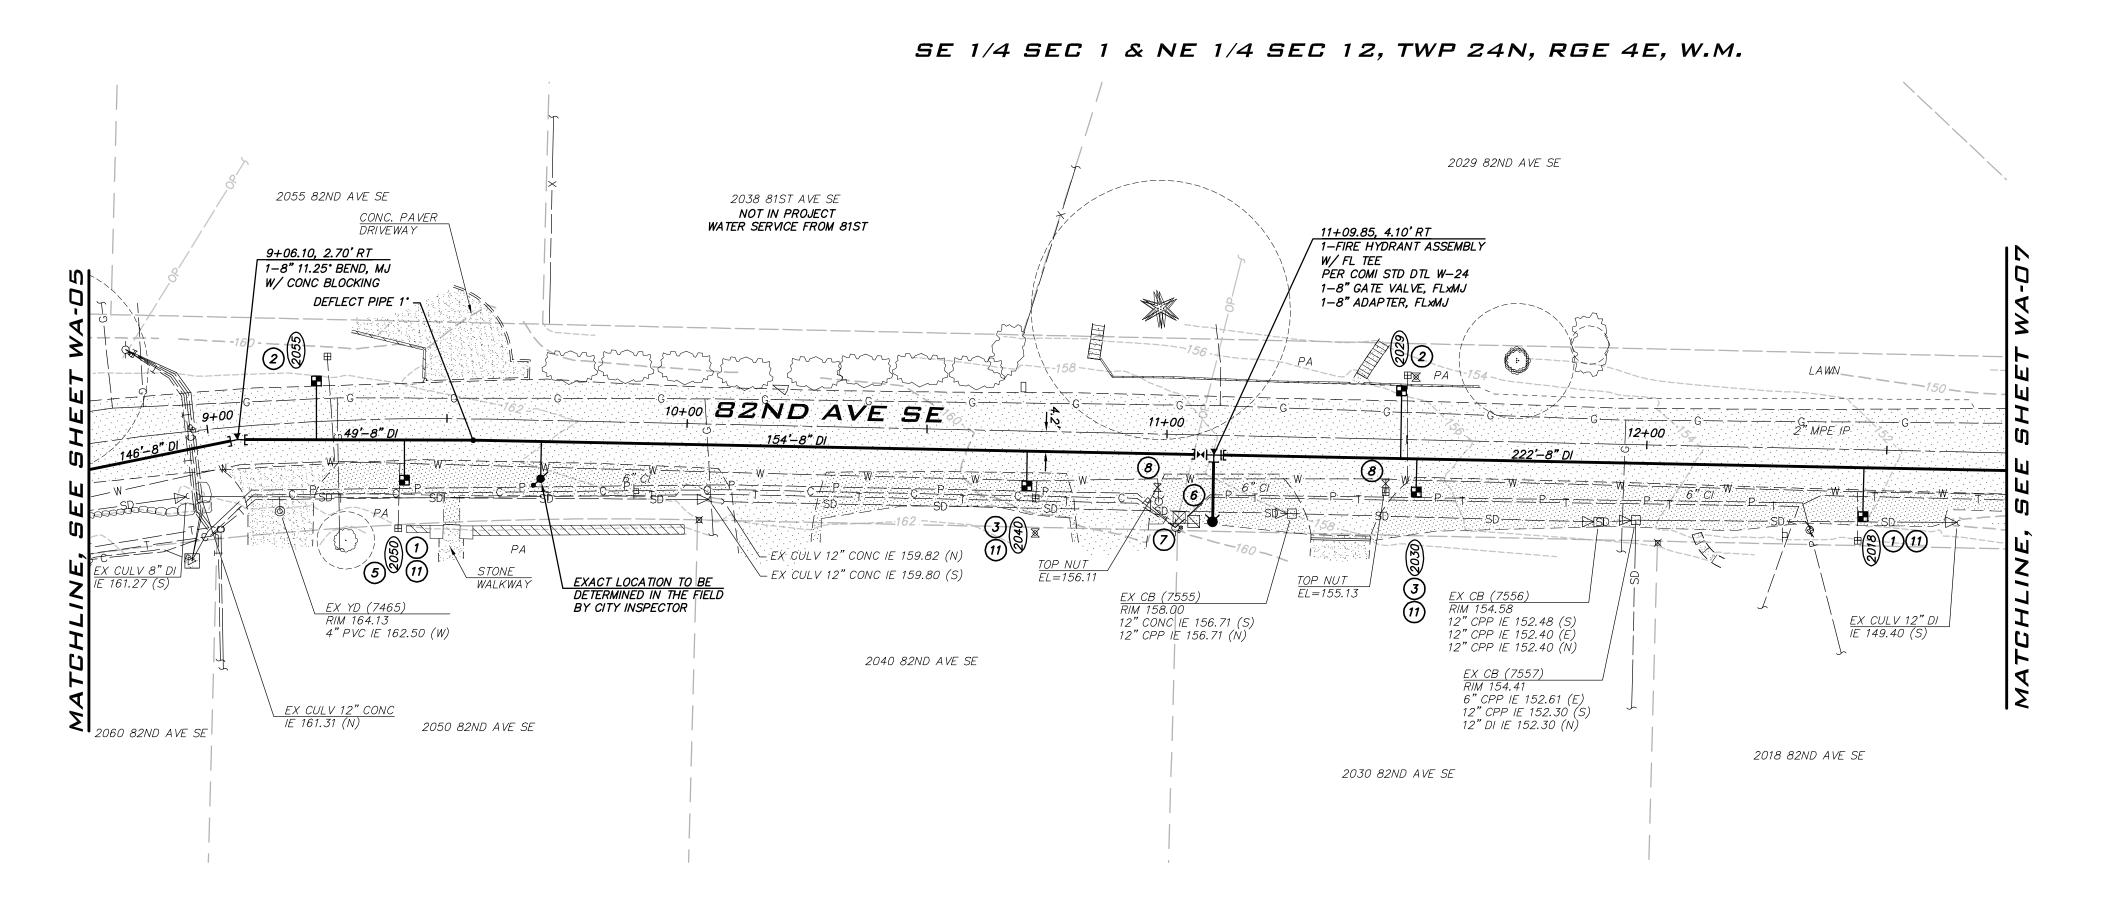

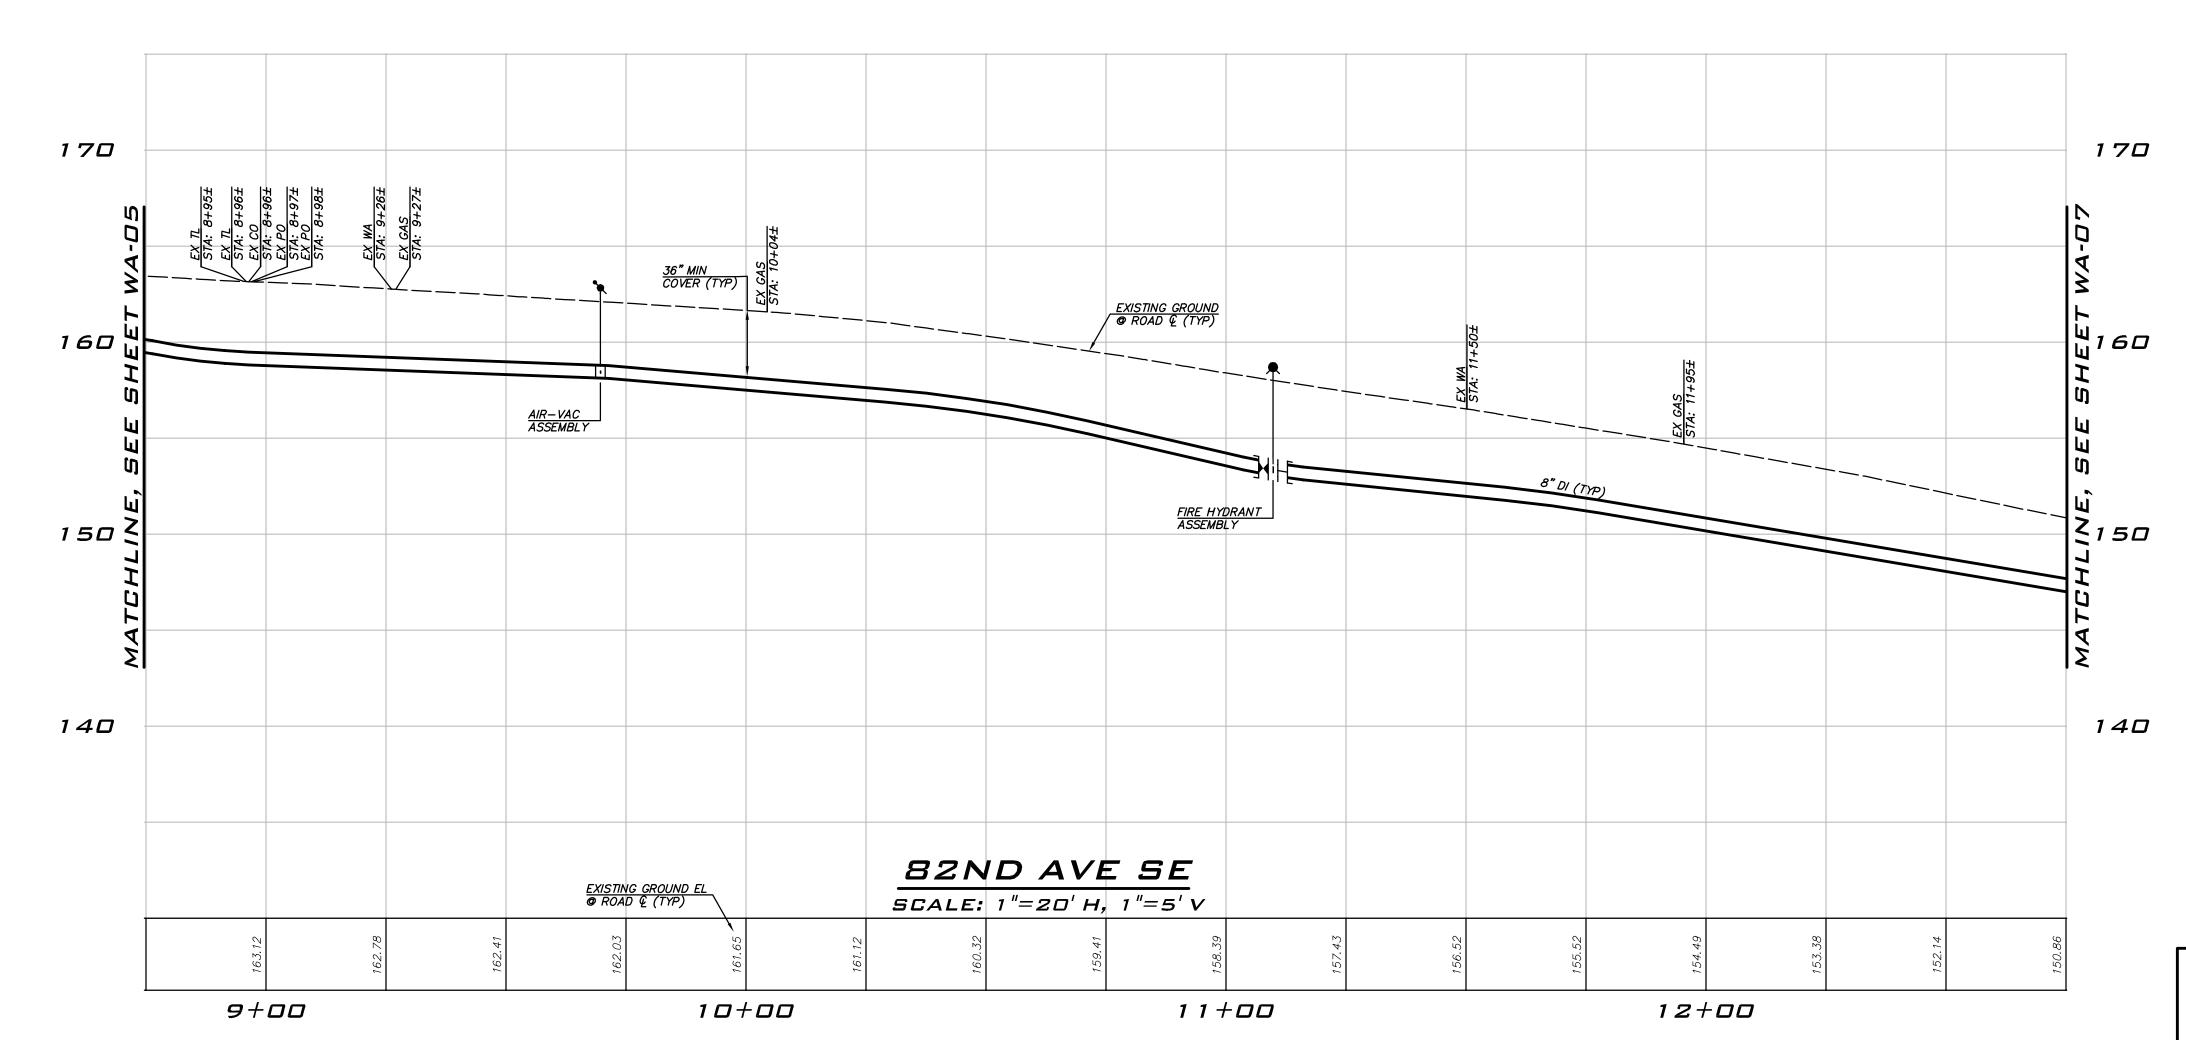

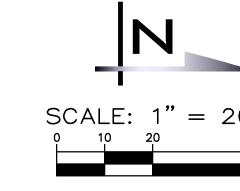

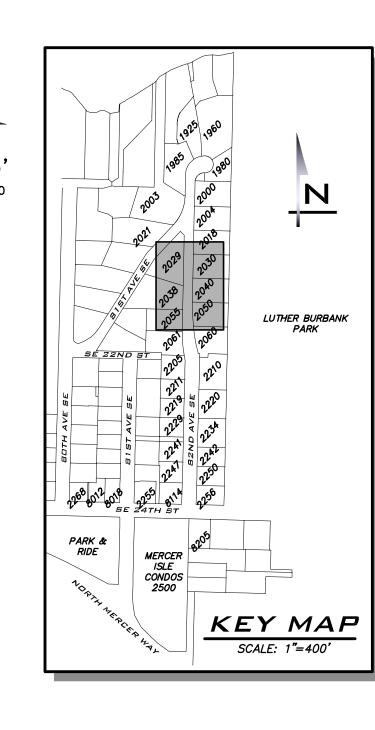

### CONSTRUCTION NOTES

- 1. ALL MECHANICAL JOINT FITTINGS SHALL BE RESTRAINED WITH MEGALUGS. FIELD LOK GASKETS SHALL ONLY BE INSTALLED AT PIPE JOINTS IN FIRE HYDRANT LEADS LONGER THAN ONE PIPE SEGMENT OR WHERE SPECIFICALLY CALLED OUT IN PROFILE.
- MAINTAIN 18" SEPARATION BETWEEN WATER MAIN AND OTHER UTILITIES. INSTALL ETHAFOAM 220 PAD TO PREVENT UTILITIES FROM BEARING ON WATER MAIN WHERE SEPARATION IS LESS THAN 6".
- 3. COORDINATE VALVE SHUTOFFS WITH CITY FOR ALL WATER MAIN CONNECTIONS. CITY STAFF SHALL OPERATE ALL WATER SYSTEM VALVES. CONTRACTOR NOT ALLOWED TO OPERATE VALVES.
- LOCATION AND DEPTHS OF EXISTING UTILITIES ARE APPROXIMATE AND BASED ON THE BEST AVAILABLE DATA AT THE TIME OF DESIGN.
  CONTRACTORS SHALL POTHOLE EXISTING UTILITIES PRIOR TO BEGINNING CONSTRUCTION TO VERIFY DEPTHS AND HORIZONTAL ALIGNMENT AT CROSSINGS AND CONNECTIONS.

### NOTES

- INSTALL 1" SHORT SIDE WATER SERVICE PER STD DETAIL W-13 AND AS DESCRIBED IN PROJECT SPECIFICATIONS. (SEE NOTES 9 & 10 BELOW)
- 2) INSTALL 1" LONG SIDE WATER SERVICE PER STD DETAIL W-13 AND AS DESCRIBED IN PROJECT SPECIFICATIONS.
  (SEE NOTES 9 & 10 BELOW)
- INSTALL 2" SHORT SIDE WATER SERVICE FOR 1-1/2" METER PER STD DETAIL W-14 AND AS DESCRIBED IN PROJECT SPECIFICATIONS. (SEE NOTES 9 & 10 BELOW)
- INSTALL 2" LONG SIDE WATER SERVICE FOR 1-1/2" METER PER STD
  DETAIL W-14 AND AS DESCRIBED IN PROJECT SPECIFICATIONS.
  (SEE NOTES 9 & 10 BELOW)
- CONTRACTOR TO POTHOLE TO LOCATE CUSTOMER SIDE SERVICE ON CORRESPONDING PROPERTY. HOLE HOG FROM BACK OF METER TO CONNECT TO EXISTING CUSTOMER SIDE SERVICE WITHIN SERVED PROPERTY
- 6 CONTRACTOR TO POTHOLE EXISTING UTILITIES IN ADVANCE TO SET HYDRANTS WITHOUT USING VERTICAL BENDS.
- REMOVE EXISTING FIRE HYDRANT. CAP OR PLUG AT THE END OF EXISTING PIPE AS DIRECTED BY THE CITY.
- 8 EXISTING GATE VALVE ON MAIN TO BE ABANDONED. CONTRACTOR TO CLOSE EXISTING VALVE, REMOVE VALVE BOX AND LID TO 1' BELOW GRADE, REPLACE LID AND ADD PVC MARKER THAT READS: "ABANDONED GATE VALVE."
- 9 METER, METER BOX, AND ADDITIONAL INFORMATION ARE PROVIDED ON SHEET GN-03.
- (10) EXACT LOCATION TO BE FIELD VERIFIED BY THE ENGINEER.
- 11 REPLACE EXISTING CONCRETE METER BOX WITH TRAFFIC RATED METER BOX. CITY TO PROVIDE NEW METER BOX.
- 12) REMOVE EXISTING FIRE HYDRANT, VALVE AND VALVE CAN. CAP THE TEE AT THE MAIN AS DIRECTED BY THE CITY. ALL REMOVED ITEMS SHALL BE RETURNED TO THE CITY OF MERCER ISLAND.

### EXISTING UTILITY NOTE

EXISTING UTILITIES ARE SHOWN IN THE APPROXIMATE LOCATION. THERE IS NO GUARANTEE THAT ALL UTILITY LINES ARE SHOWN, OR THAT THE LOCATION, SIZE AND MATERIAL IS ACCURATE. THE CONTRACTOR SHALL UNCOVER ALL INDICATED PIPING WHERE CROSSING, INTERFERENCES, OR CONNECTIONS OCCUR PRIOR TO TRENCHING OR EXCAVATION FOR ANY PIPE OR STRUCTURES, TO DETERMINE ACTUAL LOCATIONS, SIZE AND MATERIAL. THE CONTRACTOR SHALL MAKE THE APPROPRIATE PROVISION FOR PROTECTION OF SAID FACILITIES. THE CONTRACTOR SHALL NOTIFY ONE CALL AT 8-1-1 (WASHINGTON811.COM) AND ARRANGE FOR FIELD LOCATION OF EXISTING FACILITIES BEFORE CONSTRUCTION.



	25 C k 425 WW	(IRKI 5.216.	_AND 4051	, WA F:⊿	980 125.2	33 16.4
SCAL <b>AS NO</b>						
PROJ <b>DEANN</b>						
PROJ <b>GRACE</b>					ER:	
DESIC CAROL			ΤT			
ISSUE <b>2/23</b> /			<u>:</u> :			
87						
REVISIONS						
REV						

2021 WATER SYSTEM PROVEMENTS PROJECT

WASHING WASHIN


2/23/21

JOB NUMBER: 20-286


SHEET NAME: **WA-D6** 

sнт <u>15</u> ог <u>26</u>

EX 12" SD IE 134.30 8" WA CE 133.80

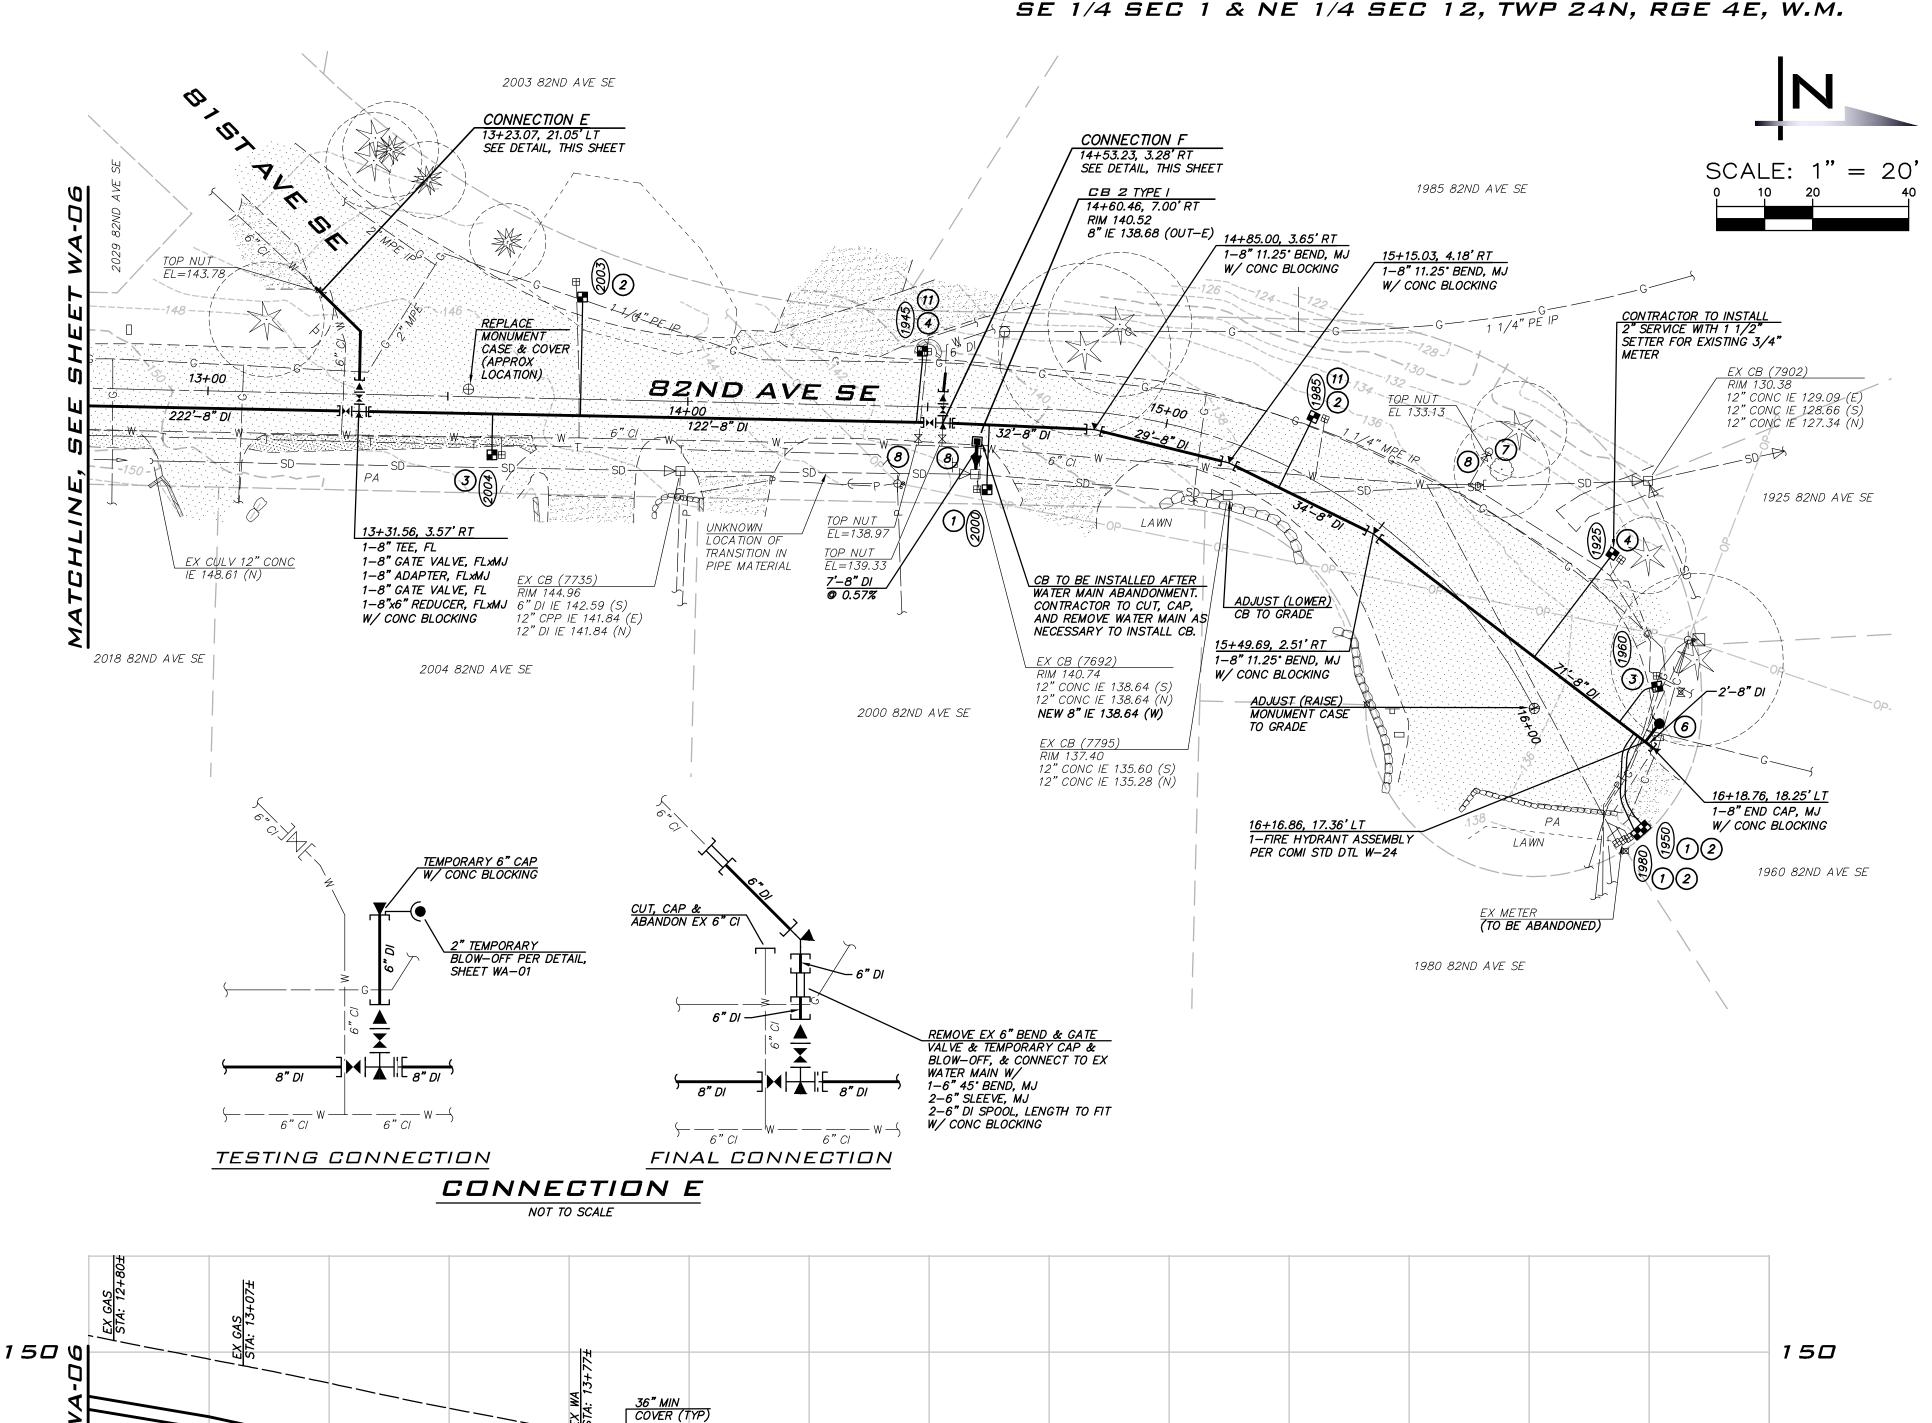


EX 6" WA IE 138.16 8" WA CE 137.66

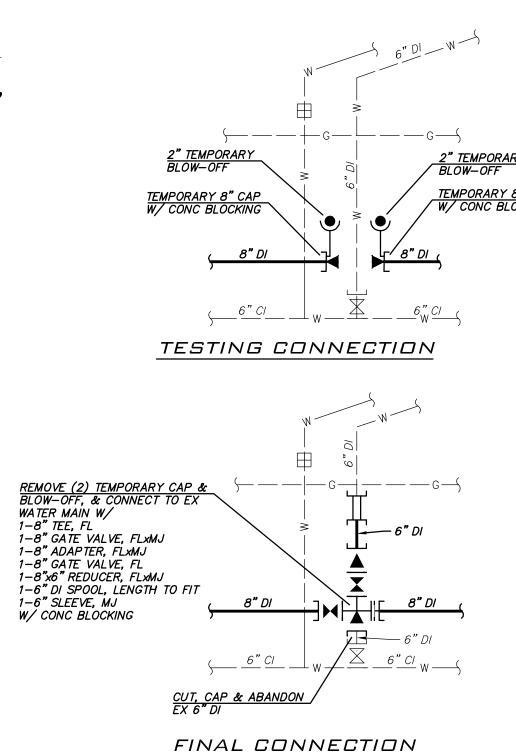

CONNECTION F

NOT TO SCALE

140

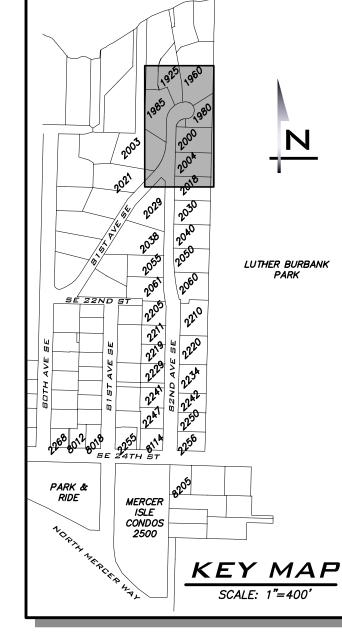

### CONSTRUCTION NOTES


- ALL MECHANICAL JOINT FITTINGS SHALL BE RESTRAINED WITH MEGALUGS. FIELD LOK GASKETS SHALL ONLY BE INSTALLED AT PIPE JOINTS IN FIRE HYDRANT LEADS LONGER THAN ONE PIPE SEGMENT OR WHERE SPECIFICALLY CALLED OUT IN PROFILE.
- MAINTAIN 18" SEPARATION BETWEEN WATER MAIN AND OTHER UTILITIES. INSTALL ETHAFOAM 220 PAD TO PREVENT UTILITIES FROM BEARING ON WATER MAIN WHERE SEPARATION IS LESS THAN 6".
- 3. COORDINATE VALVE SHUTOFFS WITH CITY FOR ALL WATER MAIN CONNECTIONS. CITY STAFF SHALL OPERATE ALL WATER SYSTEM VALVES. CONTRACTOR NOT ALLOWED TO OPERATE VALVES.
- LOCATION AND DEPTHS OF EXISTING UTILITIES ARE APPROXIMATE AND BASED ON THE BEST AVAILABLE DATA AT THE TIME OF DESIGN. CONTRACTORS SHALL POTHOLE EXISTING UTILITIES PRIOR TO BEGINNING CONSTRUCTION TO VERIFY DEPTHS AND HORIZONTAL ALIGNMENT AT CROSSINGS AND CONNECTIONS.

### NOTES

- INSTALL 1" SHORT SIDE WATER SERVICE PER STD DETAIL W-13 AND AS DESCRIBED IN PROJECT SPECIFICATIONS. (SEE NOTES 9 & 10 BELOW)
- 2 INSTALL 1" LONG SIDE WATER SERVICE PER STD DETAIL W-13 AND AS DESCRIBED IN PROJECT SPECIFICATIONS. (SEE NOTES 9 & 10 BELOW)
- 3 INSTALL 2" SHORT SIDE WATER SERVICE FOR 1-1/2" METER PER STD DETAIL W-14 AND AS DESCRIBED IN PROJECT SPECIFICATIONS. (SEE NOTES 9 & 10 BELOW)
- 4) INSTALL 2" LONG SIDE WATER SERVICE FOR 1-1/2" METER PER STD DETAIL W-14 AND AS DESCRIBED IN PROJECT SPECIFICATIONS. (SEE NOTES 9 & 10 BELOW)
- CONTRACTOR TO POTHOLE TO LOCATE CUSTOMER SIDE SERVICE ON CORRESPONDING PROPERTY. HOLE HOG FROM BACK OF METER TO CONNECT TO EXISTING CUSTOMER SIDE SERVICE WITHIN SERVED
- 6 CONTRACTOR TO POTHOLE EXISTING UTILITIES IN ADVANCE TO SET HYDRANTS WITHOUT USING VERTICAL BENDS.
- REMOVE EXISTING FIRE HYDRANT. CAP OR PLUG AT THE END OF EXISTING PIPE AS DIRECTED BY THE CITY.
- EXISTING GATE VALVE ON MAIN TO BE ABANDONED. CONTRACTOR TO CLOSE EXISTING VALVE, REMOVE VALVE BOX AND LID TO 1' BELOW GRADE, REPLACE LID AND ADD PVC MARKER THAT READS: "ABANDONED GATE VALVE."
- 9 METER, METER BOX, AND ADDITIONAL INFORMATION ARE PROVIDED ON SHEET GN-03.
- (10) EXACT LOCATION TO BE FIELD VERIFIED BY THE ENGINEER.
- REPLACE EXISTING CONCRETE METER BOX WITH TRAFFIC RATED METER BOX. CITY TO PROVIDE NEW METER BOX.
- REMOVE EXISTING FIRE HYDRANT, VALVE AND VALVE CAN. CAP THE TEE AT THE MAIN AS DIRECTED BY THE CITY. ALL REMOVED ITEMS SHALL BE RETURNED TO THE CITY OF MERCER ISLAND.

### EXISTING UTILITY NOTE

EXISTING UTILITIES ARE SHOWN IN THE APPROXIMATE LOCATION. THERE IS NO GUARANTEE THAT ALL UTILITY LINES ARE SHOWN, OR THAT THE LOCATION, SIZE AND MATERIAL IS ACCURATE. THE CONTRACTOR SHALL UNCOVER ALL INDICATED PIPING WHERE CROSSING, INTERFERENCES, OR CONNECTIONS OCCUR PRIOR TO TRENCHING OR EXCAVATION FOR ANY PIPE OR STRUCTURES, TO DETERMINE ACTUAL LOCATIONS, SIZE AND MATERIAL. THE CONTRACTOR SHALL MAKE THE APPROPRIATE PROVISION FOR PROTECTION OF SAID FACILITIES. THE CONTRACTOR SHALL NOTIFY ONE CALL AT 8-1-1 (WASHINGTON811.COM) AND ARRANGE FOR FIELD LOCATION OF EXISTING FACILITIES BEFORE CONSTRUCTION.

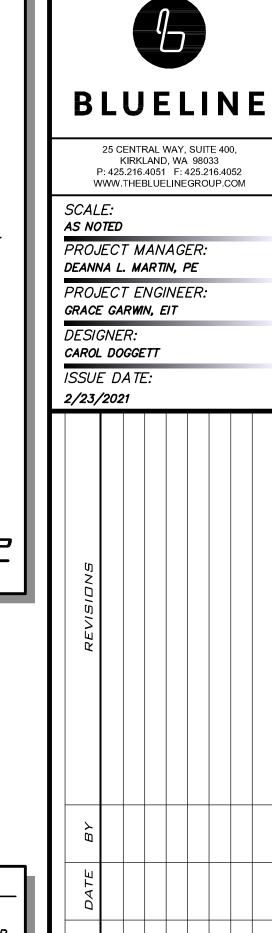




2/23/21


20-286


SHEET NAME: WA-07


sнт **16** ог **26** 

8" WA IE 144.42 EX 6" WA CE 142.45

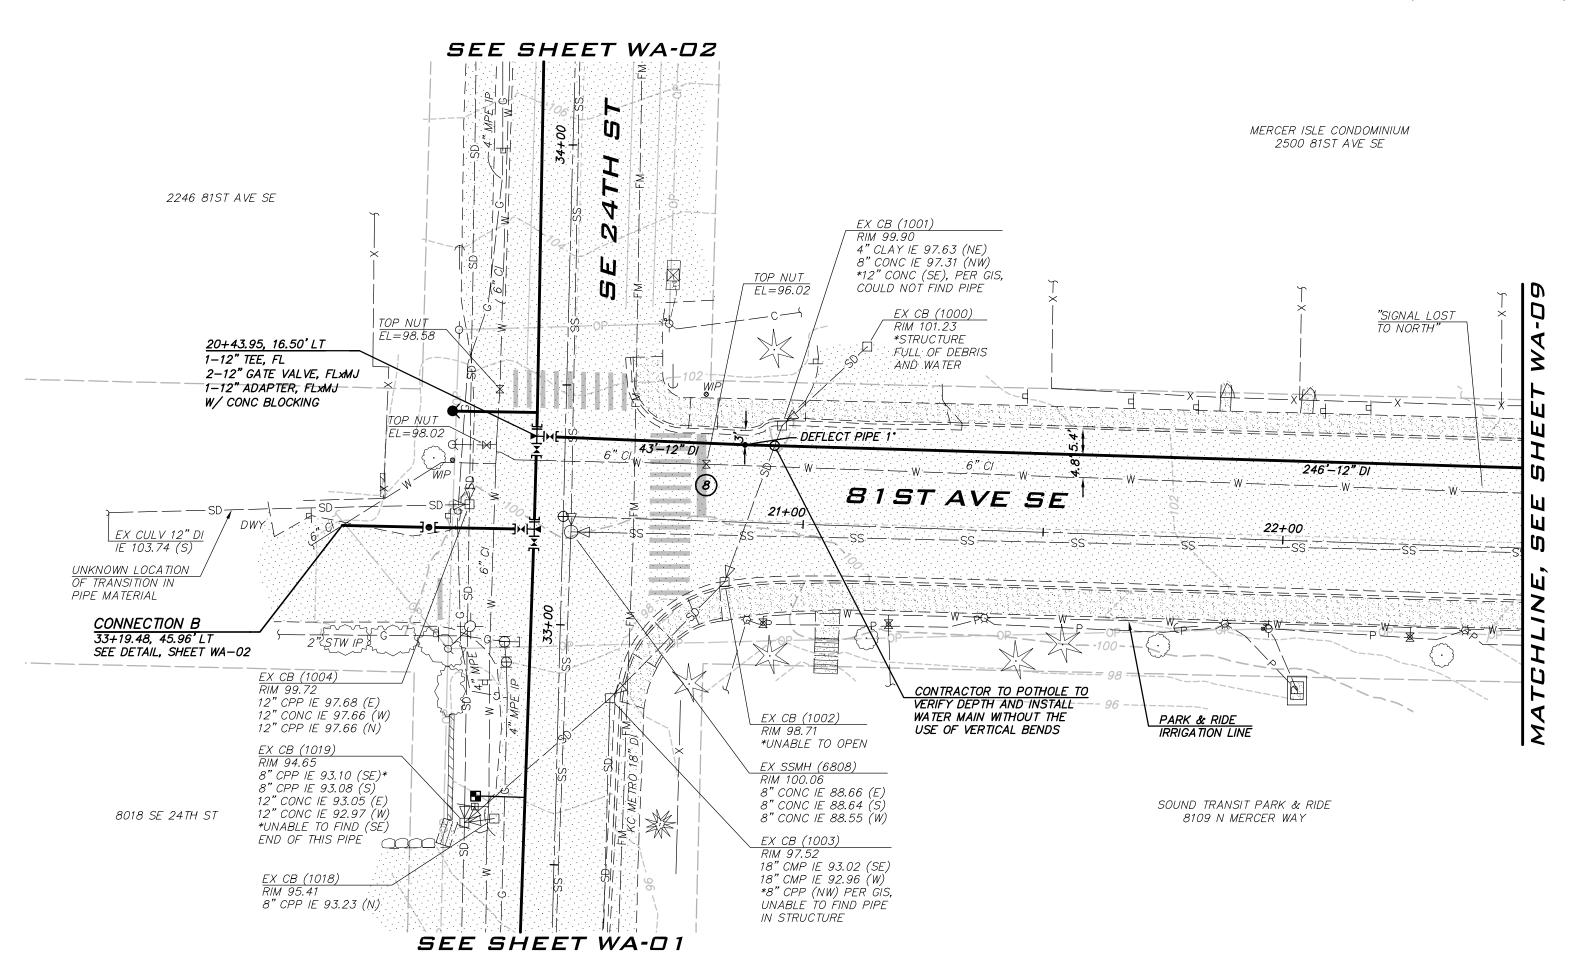

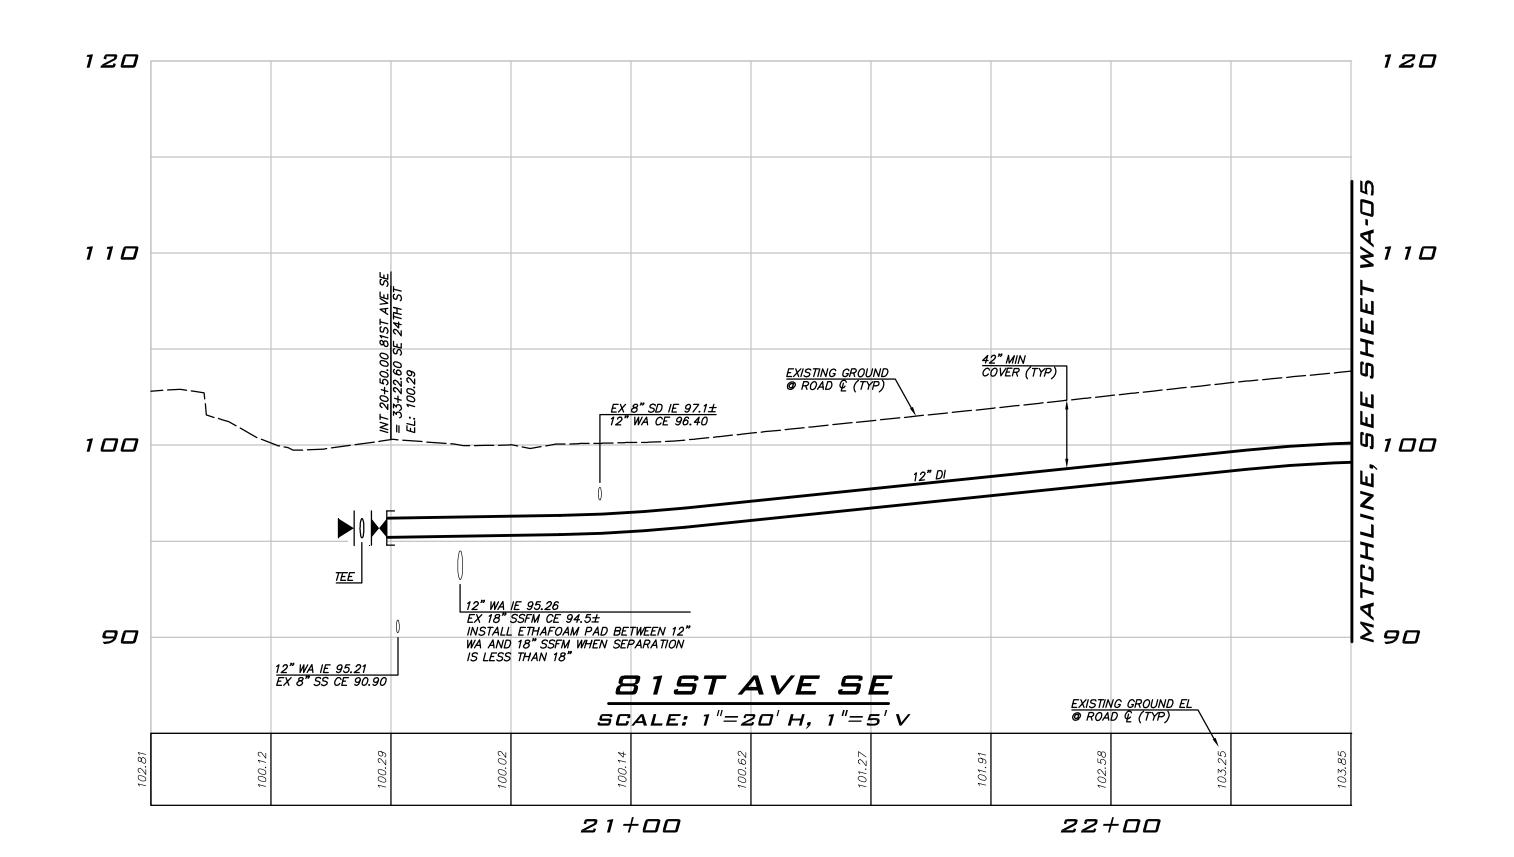

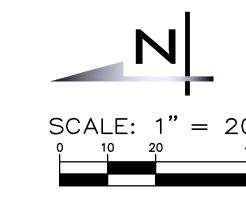

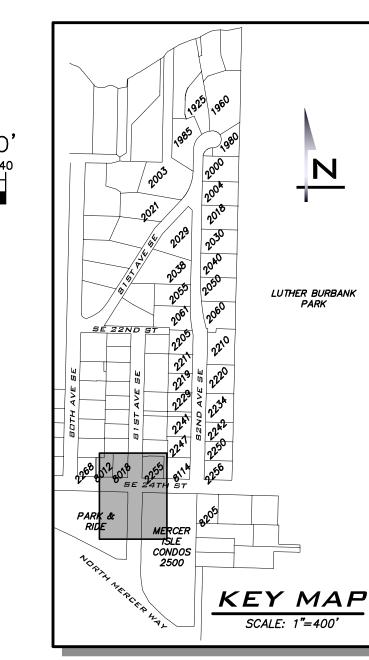

# 2/23/2021 BY REVISIONS

BLUELINE

25 CENTRAL WAY, SUITE 400, KIRKLAND, WA 98033 P: 425.216.4051 F: 425.216.4052

WWW.THEBLUELINEGROUP.COM

PROJECT MANAGER:

DEANNA L. MARTIN. PE

PROJECT ENGINEER: GRACE GARWIN, EIT

AS NOTED

DESIGNER:

CAROL DOGGETT

ISSUE DATE:

### CONSTRUCTION NOTES


- 1. ALL MECHANICAL JOINT FITTINGS SHALL BE RESTRAINED WITH MEGALUGS. FIELD LOK GASKETS SHALL ONLY BE INSTALLED AT PIPE JOINTS IN FIRE HYDRANT LEADS LONGER THAN ONE PIPE SEGMENT OR WHERE SPECIFICALLY CALLED OUT IN PROFILE.
- MAINTAIN 18" SEPARATION BETWEEN WATER MAIN AND OTHER UTILITIES.
  INSTALL ETHAFOAM 220 PAD TO PREVENT UTILITIES FROM BEARING ON
  WATER MAIN WHERE SEPARATION IS LESS THAN 6".
- 3. COORDINATE VALVE SHUTOFFS WITH CITY FOR ALL WATER MAIN CONNECTIONS. CITY STAFF SHALL OPERATE ALL WATER SYSTEM VALVES. CONTRACTOR NOT ALLOWED TO OPERATE VALVES.
- LOCATION AND DEPTHS OF EXISTING UTILITIES ARE APPROXIMATE AND BASED ON THE BEST AVAILABLE DATA AT THE TIME OF DESIGN.
  CONTRACTORS SHALL POTHOLE EXISTING UTILITIES PRIOR TO BEGINNING CONSTRUCTION TO VERIFY DEPTHS AND HORIZONTAL ALIGNMENT AT CROSSINGS AND CONNECTIONS.

### NOTES

- INSTALL 1" SHORT SIDE WATER SERVICE PER STD DETAIL W-13 AND AS DESCRIBED IN PROJECT SPECIFICATIONS.
  (SEE NOTES 9 & 10 BELOW)
- 2 INSTALL 1" LONG SIDE WATER SERVICE PER STD DETAIL W-13 AND AS DESCRIBED IN PROJECT SPECIFICATIONS. (SEE NOTES 9 & 10 BELOW)
- INSTALL 2" SHORT SIDE WATER SERVICE FOR 1-1/2" METER PER STD DETAIL W-14 AND AS DESCRIBED IN PROJECT SPECIFICATIONS. (SEE NOTES 9 & 10 BELOW)
- 4 INSTALL 2" LONG SIDE WATER SERVICE FOR 1-1/2" METER PER STD DETAIL W-14 AND AS DESCRIBED IN PROJECT SPECIFICATIONS. (SEE NOTES 9 & 10 BELOW)
- 5 CONTRACTOR TO POTHOLE TO LOCATE CUSTOMER SIDE SERVICE ON CORRESPONDING PROPERTY. HOLE HOG FROM BACK OF METER TO CONNECT TO EXISTING CUSTOMER SIDE SERVICE WITHIN SERVED PROPERTY
- 6 CONTRACTOR TO POTHOLE EXISTING UTILITIES IN ADVANCE TO SET HYDRANTS WITHOUT USING VERTICAL BENDS.
- REMOVE EXISTING FIRE HYDRANT. CAP OR PLUG AT THE END OF EXISTING PIPE AS DIRECTED BY THE CITY.
- 8 EXISTING GATE VALVE ON MAIN TO BE ABANDONED. CONTRACTOR TO CLOSE EXISTING VALVE, REMOVE VALVE BOX AND LID TO 1' BELOW GRADE, REPLACE LID AND ADD PVC MARKER THAT READS: "ABANDONED GATE VALVE."
- METER, METER BOX, AND ADDITIONAL INFORMATION ARE PROVIDED ON SHEET GN-03.
- (10) EXACT LOCATION TO BE FIELD VERIFIED BY THE ENGINEER.
- 1 REPLACE EXISTING CONCRETE METER BOX WITH TRAFFIC RATED METER BOX. CITY TO PROVIDE NEW METER BOX.
- REMOVE EXISTING FIRE HYDRANT, VALVE AND VALVE CAN. CAP THE TEE AT THE MAIN AS DIRECTED BY THE CITY. ALL REMOVED ITEMS SHALL BE RETURNED TO THE CITY OF MERCER ISLAND.

### EXISTING UTILITY NOTE

EXISTING UTILITIES ARE SHOWN IN THE APPROXIMATE LOCATION. THERE IS NO GUARANTEE THAT ALL UTILITY LINES ARE SHOWN, OR THAT THE LOCATION, SIZE AND MATERIAL IS ACCURATE. THE CONTRACTOR SHALL UNCOVER ALL INDICATED PIPING WHERE CROSSING, INTERFERENCES, OR CONNECTIONS OCCUR PRIOR TO TRENCHING OR EXCAVATION FOR ANY PIPE OR STRUCTURES, TO DETERMINE ACTUAL LOCATIONS, SIZE AND MATERIAL. THE CONTRACTOR SHALL MAKE THE APPROPRIATE PROVISION FOR PROTECTION OF SAID FACILITIES. THE CONTRACTOR SHALL NOTIFY ONE CALL AT 8-1-1 (WASHINGTON811.COM) AND ARRANGE FOR FIELD LOCATION OF EXISTING FACILITIES BEFORE CONSTRUCTION.

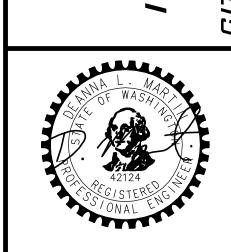



2/23/21

JOB NUMBER: 20-286

> sheet name: **WA-08**


sнт <u>17</u> оғ <u>26</u>

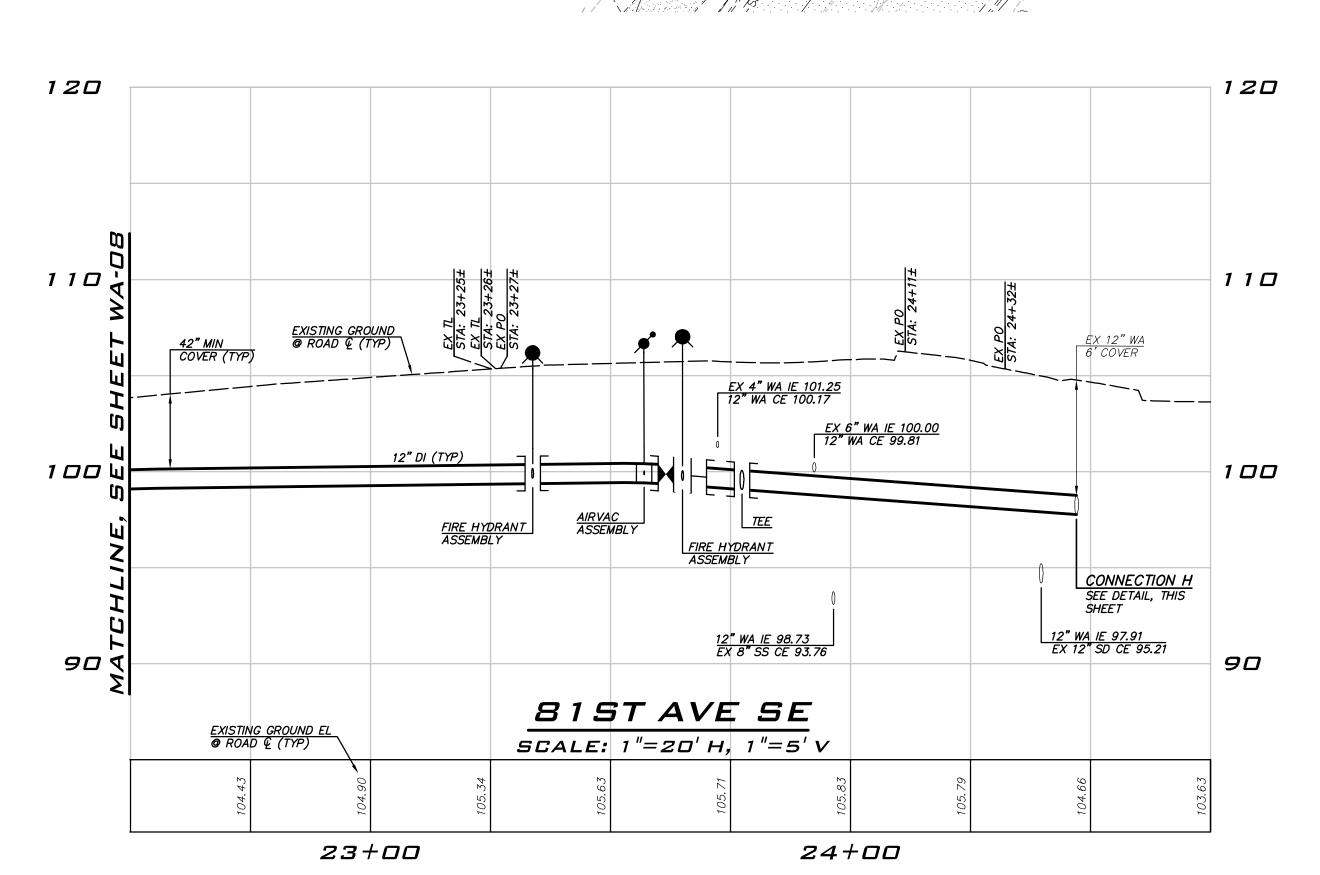


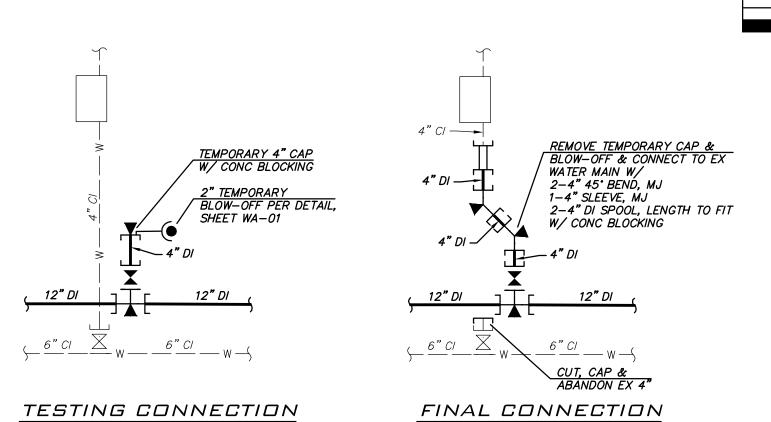

CONNECTION G

NOT TO SCALE

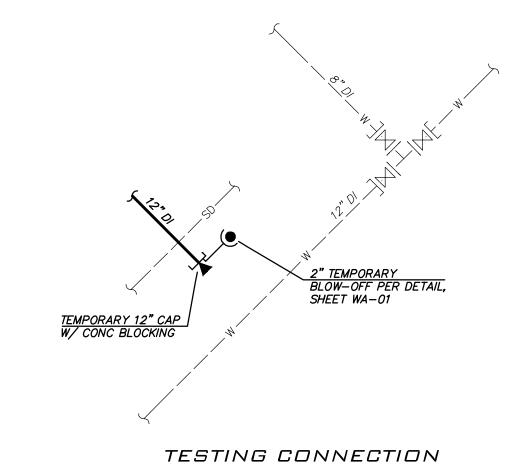


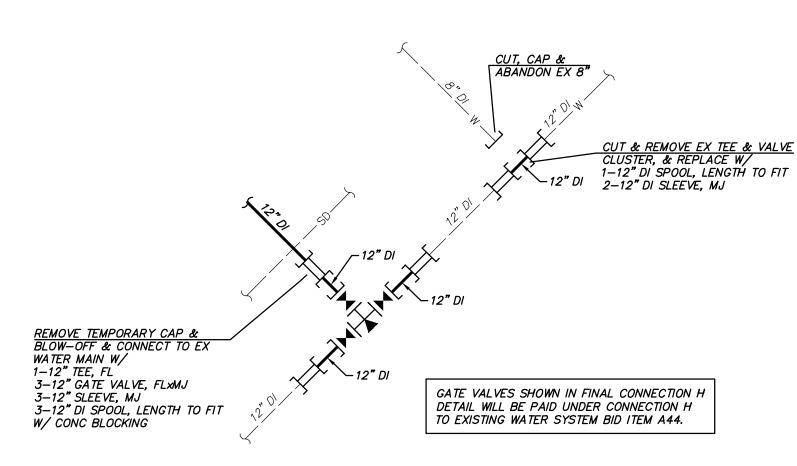

FINAL CONNECTION

CONNECTION H

NOT TO SCALE

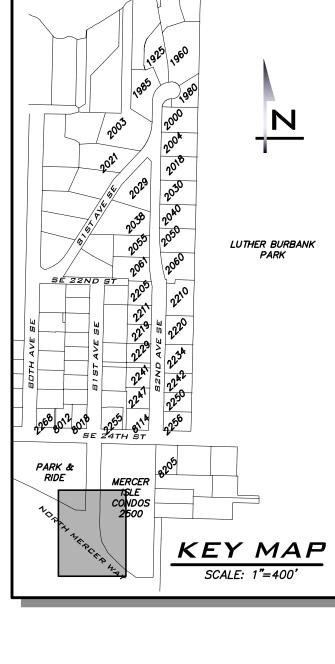

### CONSTRUCTION NOTES

- 1. ALL MECHANICAL JOINT FITTINGS SHALL BE RESTRAINED WITH MEGALUGS. FIELD LOK GASKETS SHALL ONLY BE INSTALLED AT PIPE JOINTS IN FIRE HYDRANT LEADS LONGER THAN ONE PIPE SEGMENT OR WHERE SPECIFICALLY CALLED OUT IN PROFILE.
- MAINTAIN 18" SEPARATION BETWEEN WATER MAIN AND OTHER UTILITIES. INSTALL ETHAFOAM 220 PAD TO PREVENT UTILITIES FROM BEARING ON WATER MAIN WHERE SEPARATION IS LESS THAN 6".
- S. COORDINATE VALVE SHUTOFFS WITH CITY FOR ALL WATER MAIN CONNECTIONS. CITY STAFF SHALL OPERATE ALL WATER SYSTEM VALVES. CONTRACTOR NOT ALLOWED TO OPERATE VALVES.
- LOCATION AND DEPTHS OF EXISTING UTILITIES ARE APPROXIMATE AND BASED ON THE BEST AVAILABLE DATA AT THE TIME OF DESIGN.
  CONTRACTORS SHALL POTHOLE EXISTING UTILITIES PRIOR TO BEGINNING CONSTRUCTION TO VERIFY DEPTHS AND HORIZONTAL ALIGNMENT AT CROSSINGS AND CONNECTIONS.

### NOTES

- INSTALL 1" SHORT SIDE WATER SERVICE PER STD DETAIL W-13 AND AS DESCRIBED IN PROJECT SPECIFICATIONS.
  (SEE NOTES 9 & 10 BELOW)
- (2) INSTALL 1" LONG SIDE WATER SERVICE PER STD DETAIL W-13 AND AS DESCRIBED IN PROJECT SPECIFICATIONS.
  (SEE NOTES 9 & 10 BELOW)
- 3 INSTALL 2" SHORT SIDE WATER SERVICE FOR 1-1/2" METER PER STD DETAIL W-14 AND AS DESCRIBED IN PROJECT SPECIFICATIONS. (SEE NOTES 9 & 10 BELOW)
- INSTALL 2" LONG SIDE WATER SERVICE FOR 1-1/2" METER PER STD
  DETAIL W-14 AND AS DESCRIBED IN PROJECT SPECIFICATIONS.
  (SEE NOTES 9 & 10 BELOW)
- 5 CONTRACTOR TO POTHOLE TO LOCATE CUSTOMER SIDE SERVICE ON CORRESPONDING PROPERTY. HOLE HOG FROM BACK OF METER TO CONNECT TO EXISTING CUSTOMER SIDE SERVICE WITHIN SERVED PROPERTY
- 6 CONTRACTOR TO POTHOLE EXISTING UTILITIES IN ADVANCE TO SET HYDRANTS WITHOUT USING VERTICAL BENDS.
- 7 REMOVE EXISTING FIRE HYDRANT. CAP OR PLUG AT THE END OF EXISTING PIPE AS DIRECTED BY THE CITY.
- 8 EXISTING GATE VALVE ON MAIN TO BE ABANDONED. CONTRACTOR TO CLOSE EXISTING VALVE, REMOVE VALVE BOX AND LID TO 1' BELOW GRADE, REPLACE LID AND ADD PVC MARKER THAT READS: "ABANDONED GATE VALVE."
- METER, METER BOX, AND ADDITIONAL INFORMATION ARE PROVIDED ON SHEET GN-03.
- (10) EXACT LOCATION TO BE FIELD VERIFIED BY THE ENGINEER.
- 1 REPLACE EXISTING CONCRETE METER BOX WITH TRAFFIC RATED METER BOX. CITY TO PROVIDE NEW METER BOX.
- REMOVE EXISTING FIRE HYDRANT, VALVE AND VALVE CAN. CAP THE TEE AT THE MAIN AS DIRECTED BY THE CITY. ALL REMOVED ITEMS SHALL BE RETURNED TO THE CITY OF MERCER ISLAND.

### EXISTING UTILITY NOTE

EXISTING UTILITIES ARE SHOWN IN THE APPROXIMATE LOCATION. THERE IS NO GUARANTEE THAT ALL UTILITY LINES ARE SHOWN, OR THAT THE LOCATION, SIZE AND MATERIAL IS ACCURATE. THE CONTRACTOR SHALL UNCOVER ALL INDICATED PIPING WHERE CROSSING, INTERFERENCES, OR CONNECTIONS OCCUR PRIOR TO TRENCHING OR EXCAVATION FOR ANY PIPE OR STRUCTURES, TO DETERMINE ACTUAL LOCATIONS, SIZE AND MATERIAL. THE CONTRACTOR SHALL MAKE THE APPROPRIATE PROVISION FOR PROTECTION OF SAID FACILITIES. THE CONTRACTOR SHALL NOTIFY ONE CALL AT 8-1-1 (WASHINGTON811.COM) AND ARRANGE FOR FIELD LOCATION OF EXISTING FACILITIES BEFORE CONSTRUCTION.

BLUELINE

25 CENTRAL WAY, SUITE 400,
KIRKLAND, WA 98033
P: 425.216.4051 F: 425.216.4052
WWW.THEBLUELINEGROUP.COM

SCALE:
AS NOTED

PROJECT MANAGER:
DEANNA L. MARTIN, PE

PROJECT ENGINEER:
GRACE GARWIN, EIT

DESIGNER:
CAROL DOGGETT

ISSUE DATE:
2/23/2021

2021 WATER SYSTEM MPROVEMENTS PROJECT


TO WASH 100 A 2124 A 21


2/23/21


JOB NUMBER: **20-286** 


SHEET NAME:
WA-D9

sнт <u>18</u> ог <u>26</u>

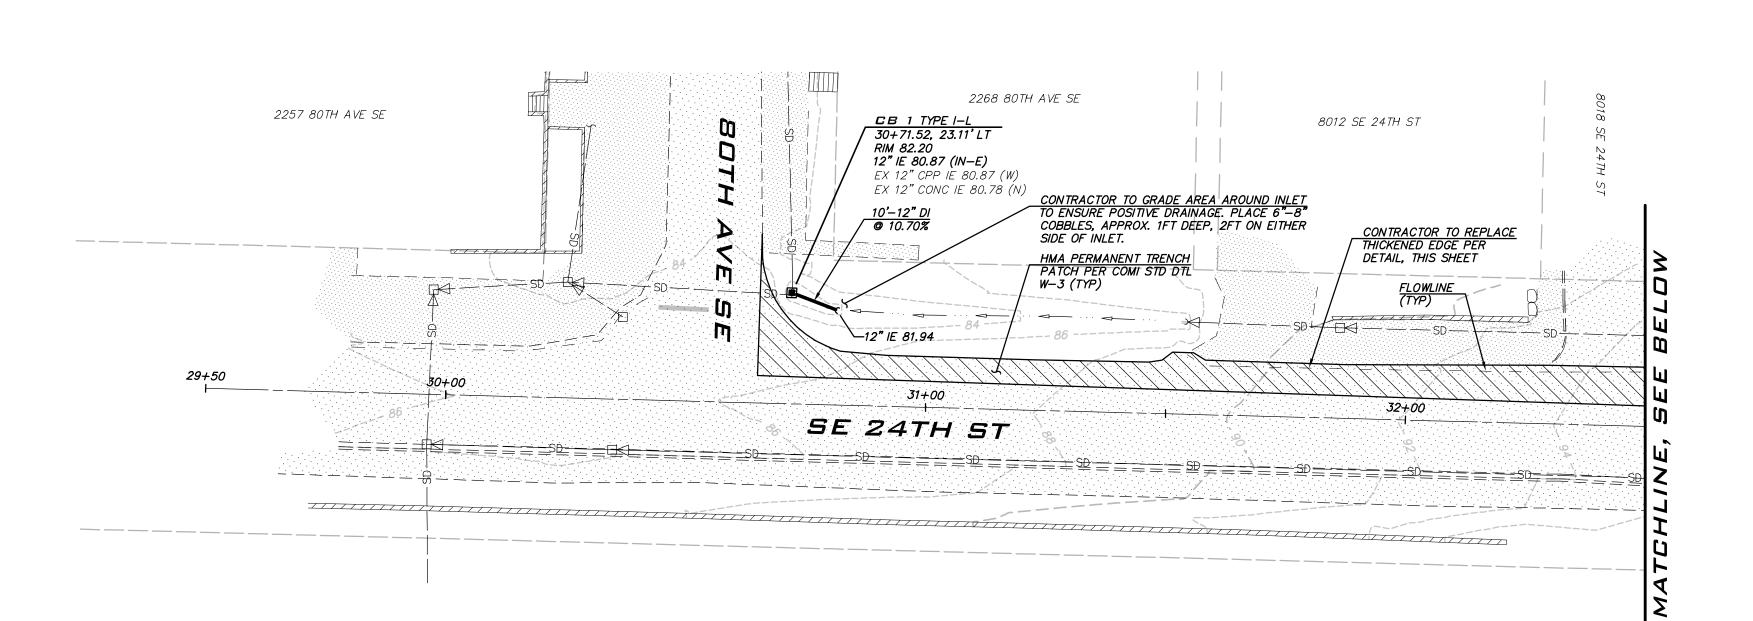


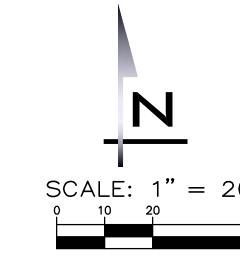

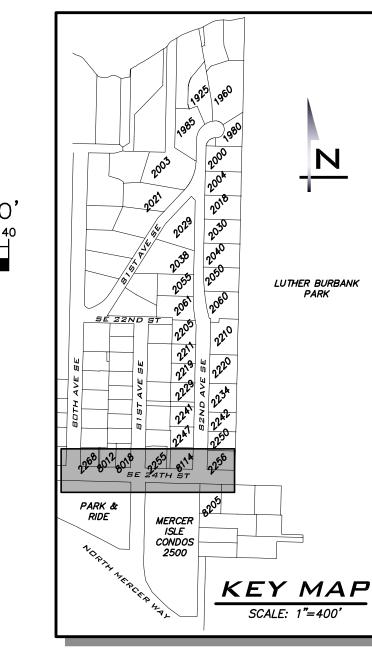

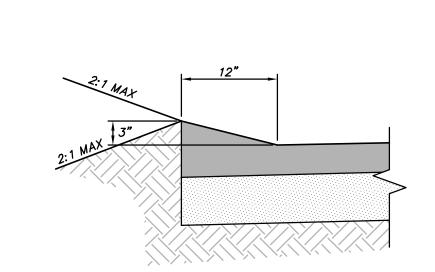

ASPHALT THICKENED EDGE

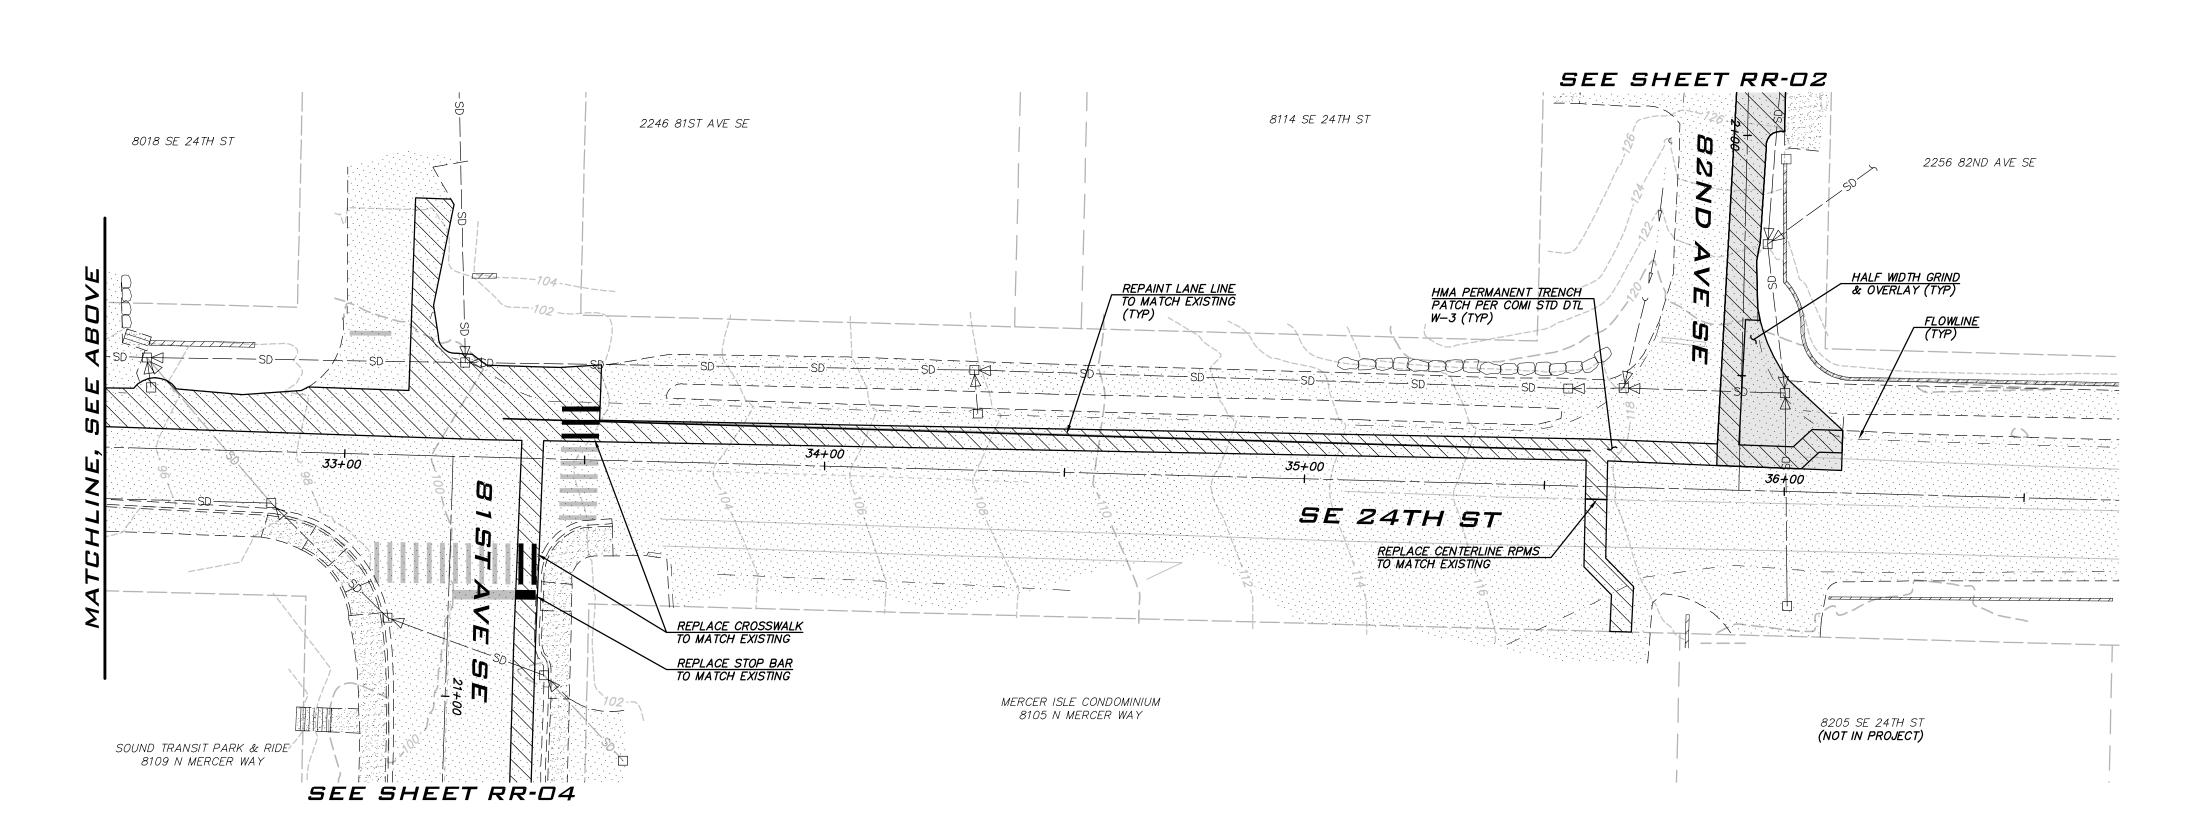



PERMANENT HMA TRENCH PATCH (SEE COMI STD DTL W-3)

HALF WIDTH GRIND AND OVERLAY WITH 2" GRIND AND 2" OVERLAY

ROADWAY RECONSTRUCTION AREA TO INCLUDE FULL DEPTH ASPHALT
REMOVAL, PRELEVELING WITH CSTC, 4" MINIMUM COMPACTED HMA PLACED
IN 2 LIFTS TO ACHIEVE 2% MINIMUM CROSS SLOPE.


### NOTES

1. THE LOCATION OF THE PAVEMENT RESTORATION SHOWN IS APPROXIMATE ONLY AND THE EXACT LOCATION SHALL BE AS DIRECTED BY THE CITY CONSTRUCTION INSPECTOR DURING CONSTRUCTION.

2. CONTRACTOR IS RESPONSIBLE FOR BARRICADES & SIGNS OR OTHER NOTIFICATIONS AS APPROPRIATE IN ORDER TO ENSURE THAT RESIDENTS REMOVE AUTOMOBILES OR OTHER OBSTRUCTIONS FROM THE ROAD PRIOR TO PAVEMENT RESTORATION.

### EXISTING UTILITY NOTE

EXISTING UTILITIES ARE SHOWN IN THE APPROXIMATE LOCATION. THERE IS NO GUARANTEE THAT ALL UTILITY LINES ARE SHOWN, OR THAT THE LOCATION, SIZE AND MATERIAL IS ACCURATE. THE CONTRACTOR SHALL UNCOVER ALL INDICATED PIPING WHERE CROSSING, INTERFERENCES, OR CONNECTIONS OCCUR PRIOR TO TRENCHING OR EXCAVATION FOR ANY PIPE OR STRUCTURES, TO DETERMINE ACTUAL LOCATIONS, SIZE AND MATERIAL. THE CONTRACTOR SHALL MAKE THE APPROPRIATE PROVISION FOR PROTECTION OF SAID FACILITIES. THE CONTRACTOR SHALL NOTIFY ONE CALL AT 8-1-1 (WASHINGTON811.COM) AND ARRANGE FOR FIELD LOCATION OF EXISTING FACILITIES BEFORE CONSTRUCTION.

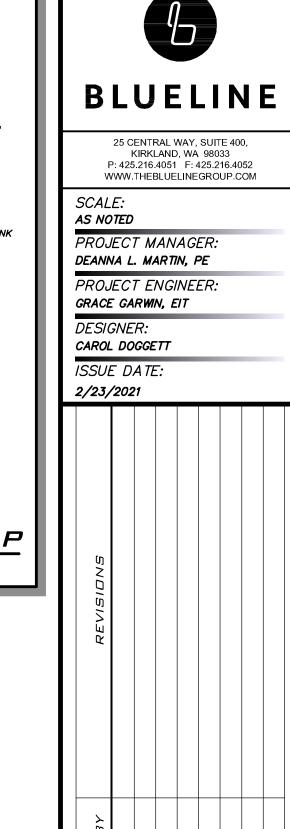



SE 24TH ST SE 24TH ST 3021 WATER SYSTEM PROVEMENTS PROJECT


JOB NUMBER: **20-286** 


> SHEET NAME: RR-01


sнт <u>19</u> ог <u>26</u>

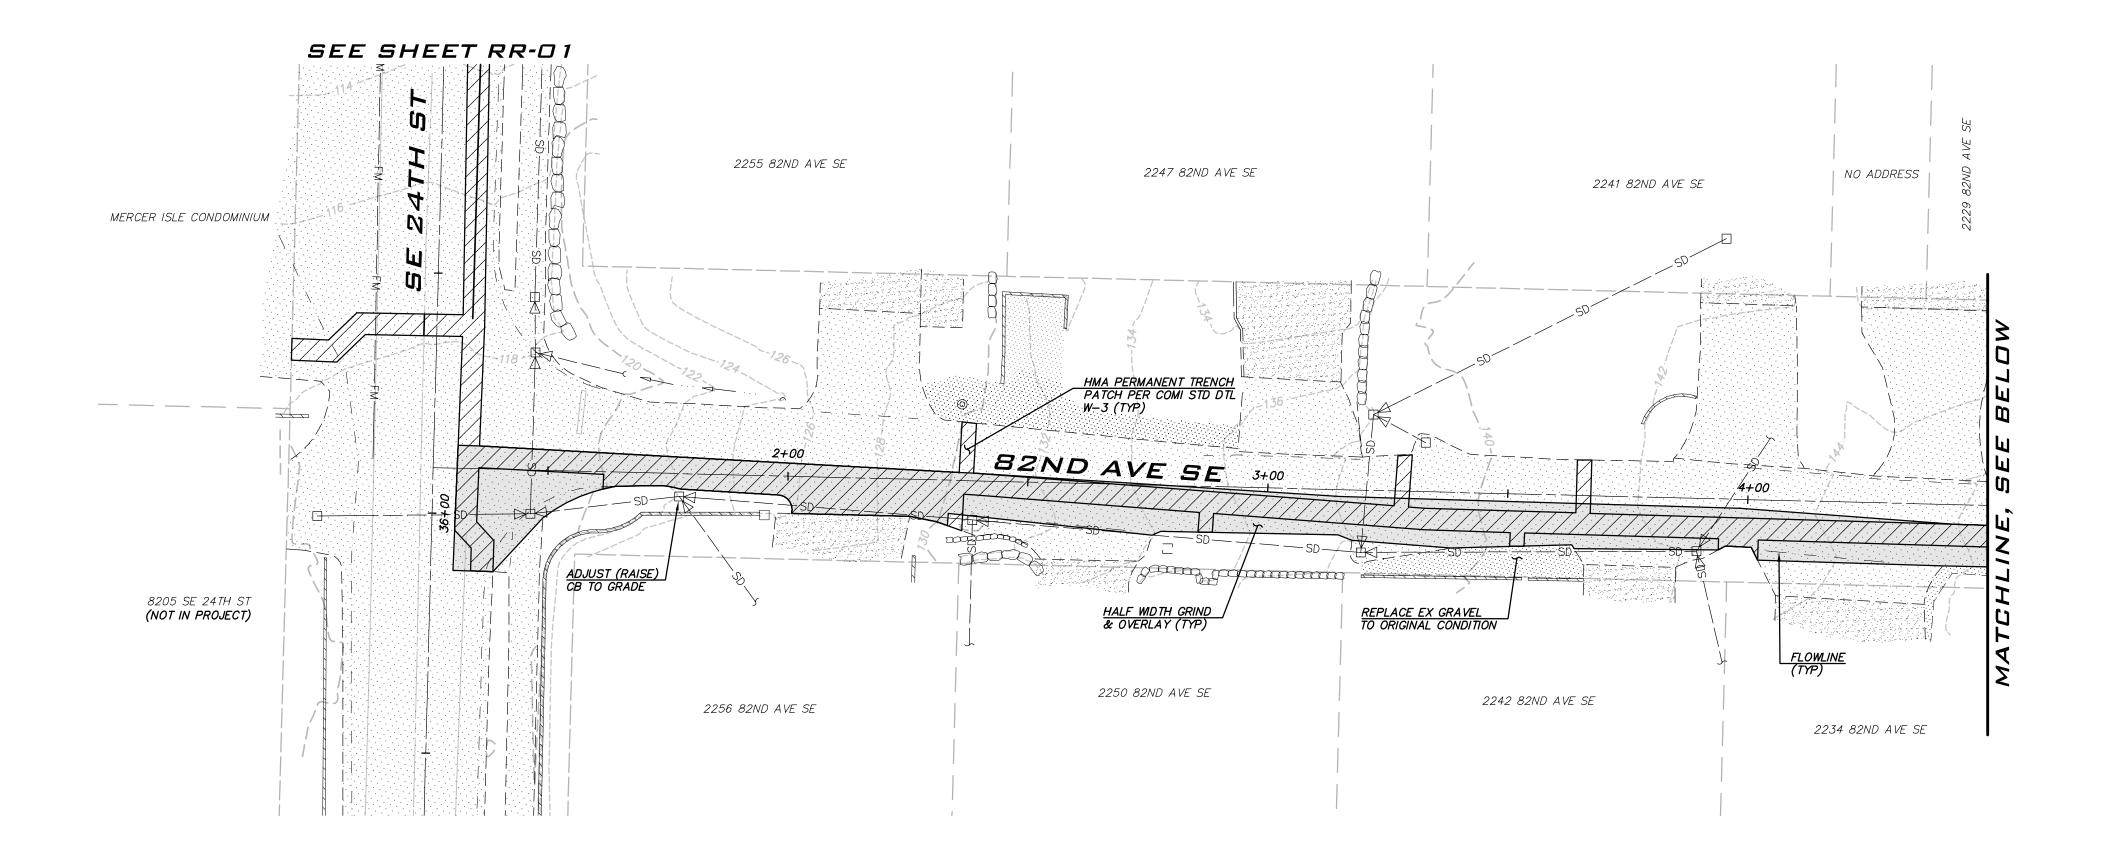

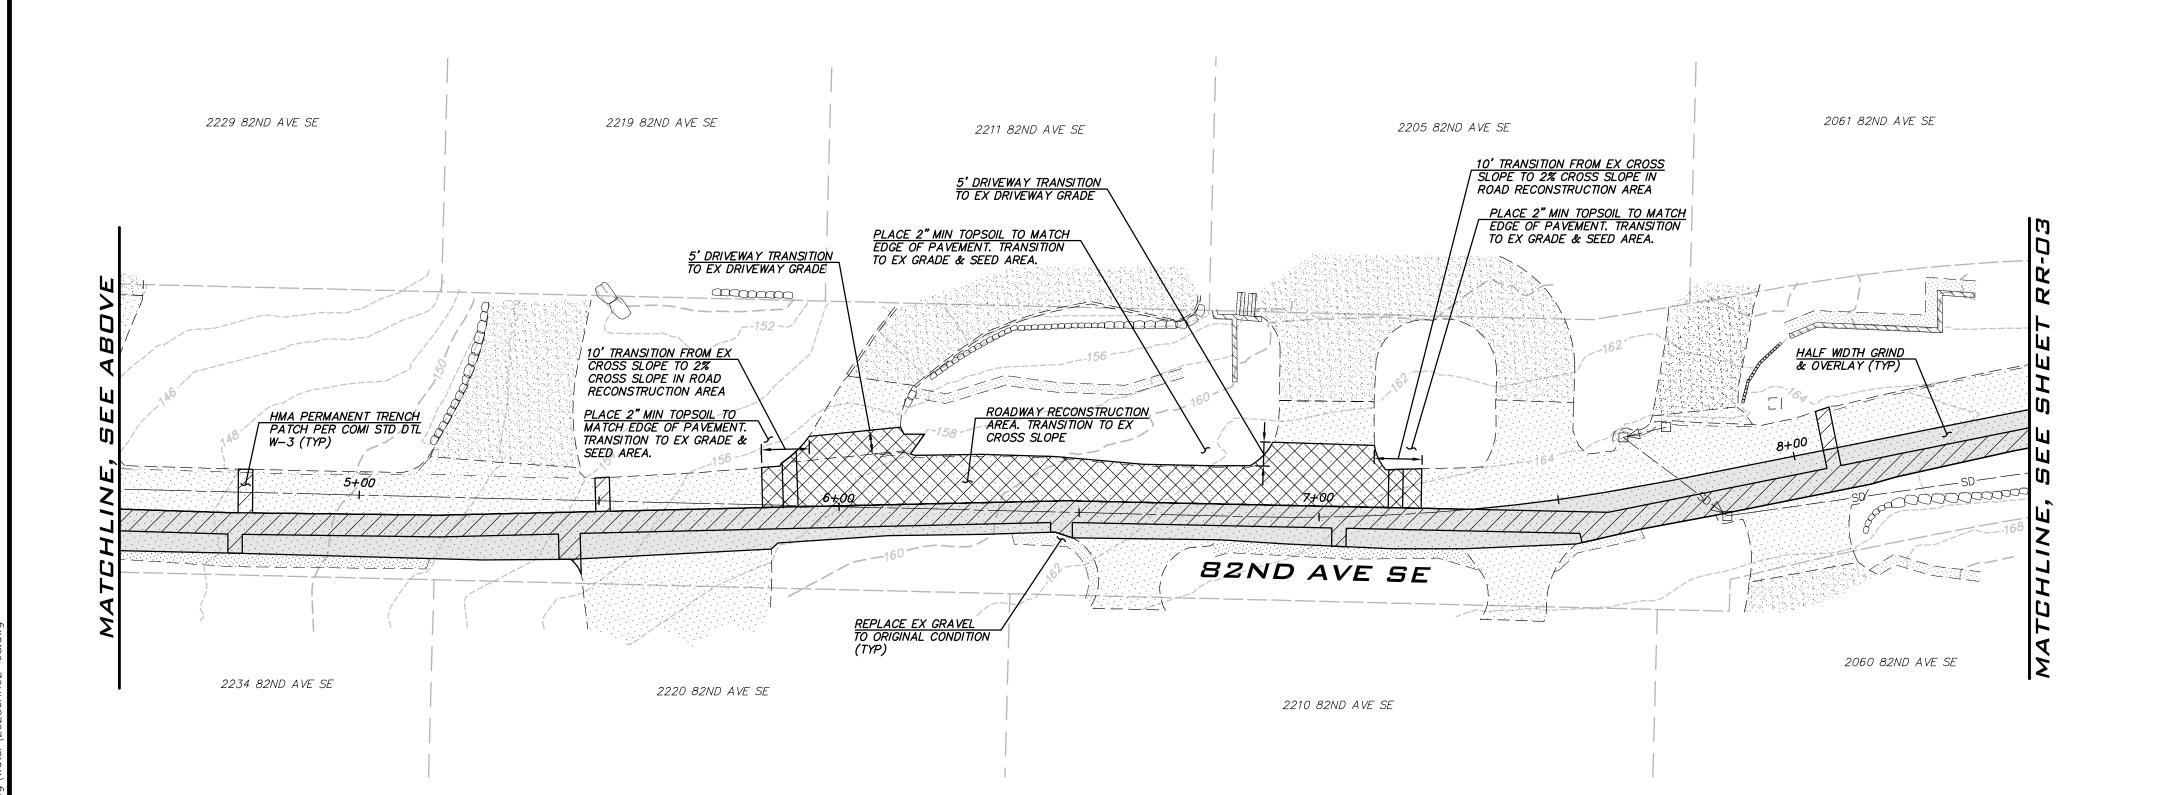

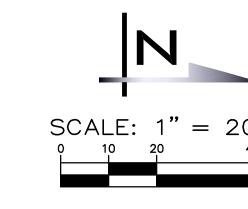

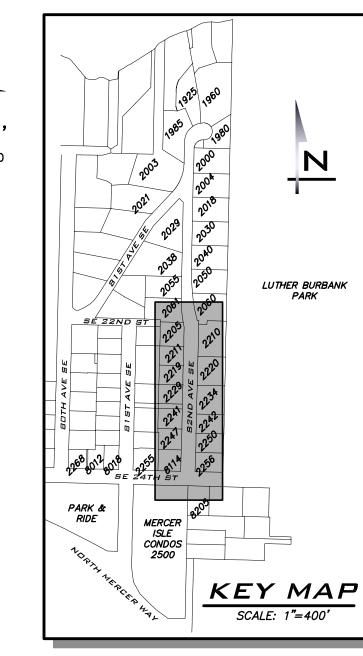

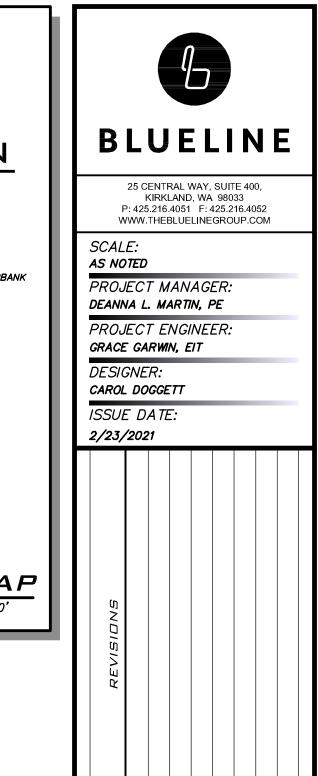

LEGEND

PERMANENT HMA TRENCH PATCH (SEE COMI STD DTL W-3)

HALF WIDTH GRIND AND OVERLAY WITH 2" GRIND AND 2" OVERLAY

ROADWAY RECONSTRUCTION AREA TO INCLUDE FULL DEPTH ASPHALT REMOVAL, PRELEVELING WITH CSTC, 4" MINIMUM COMPACTED HMA PLACED IN 2 LIFTS TO ACHIEVE 2% MINIMUM CROSS SLOPE.


### NOTES

1. THE LOCATION OF THE PAVEMENT RESTORATION SHOWN IS APPROXIMATE ONLY AND THE EXACT LOCATION SHALL BE AS DIRECTED BY THE CITY CONSTRUCTION INSPECTOR DURING CONSTRUCTION.

2. CONTRACTOR IS RESPONSIBLE FOR BARRICADES & SIGNS OR OTHER NOTIFICATIONS AS APPROPRIATE IN ORDER TO ENSURE THAT RESIDENTS REMOVE AUTOMOBILES OR OTHER OBSTRUCTIONS FROM THE ROAD PRIOR TO PAVEMENT RESTORATION.

### EXISTING UTILITY NOTE

EXISTING UTILITIES ARE SHOWN IN THE APPROXIMATE LOCATION. THERE IS NO GUARANTEE THAT ALL UTILITY LINES ARE SHOWN, OR THAT THE LOCATION, SIZE AND MATERIAL IS ACCURATE. THE CONTRACTOR SHALL UNCOVER ALL INDICATED PIPING WHERE CROSSING, INTERFERENCES, OR CONNECTIONS OCCUR PRIOR TO TRENCHING OR EXCAVATION FOR ANY PIPE OR STRUCTURES, TO DETERMINE ACTUAL LOCATIONS, SIZE AND MATERIAL. THE CONTRACTOR SHALL MAKE THE APPROPRIATE PROVISION FOR PROTECTION OF SAID FACILITIES. THE CONTRACTOR SHALL NOTIFY ONE CALL AT 8-1-1 (WASHINGTON811.COM) AND ARRANGE FOR FIELD LOCATION OF EXISTING FACILITIES BEFORE CONSTRUCTION.

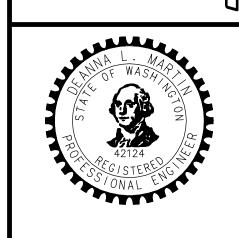


JOB NUMBER: **20-286** 


RR-02


<u> 20</u> of <u>26</u>


### SE 1/4 SEC 1 & NE 1/4 SEC 12, TWP 24N, RGE 4E, W.M.

1980 82ND AVE SE

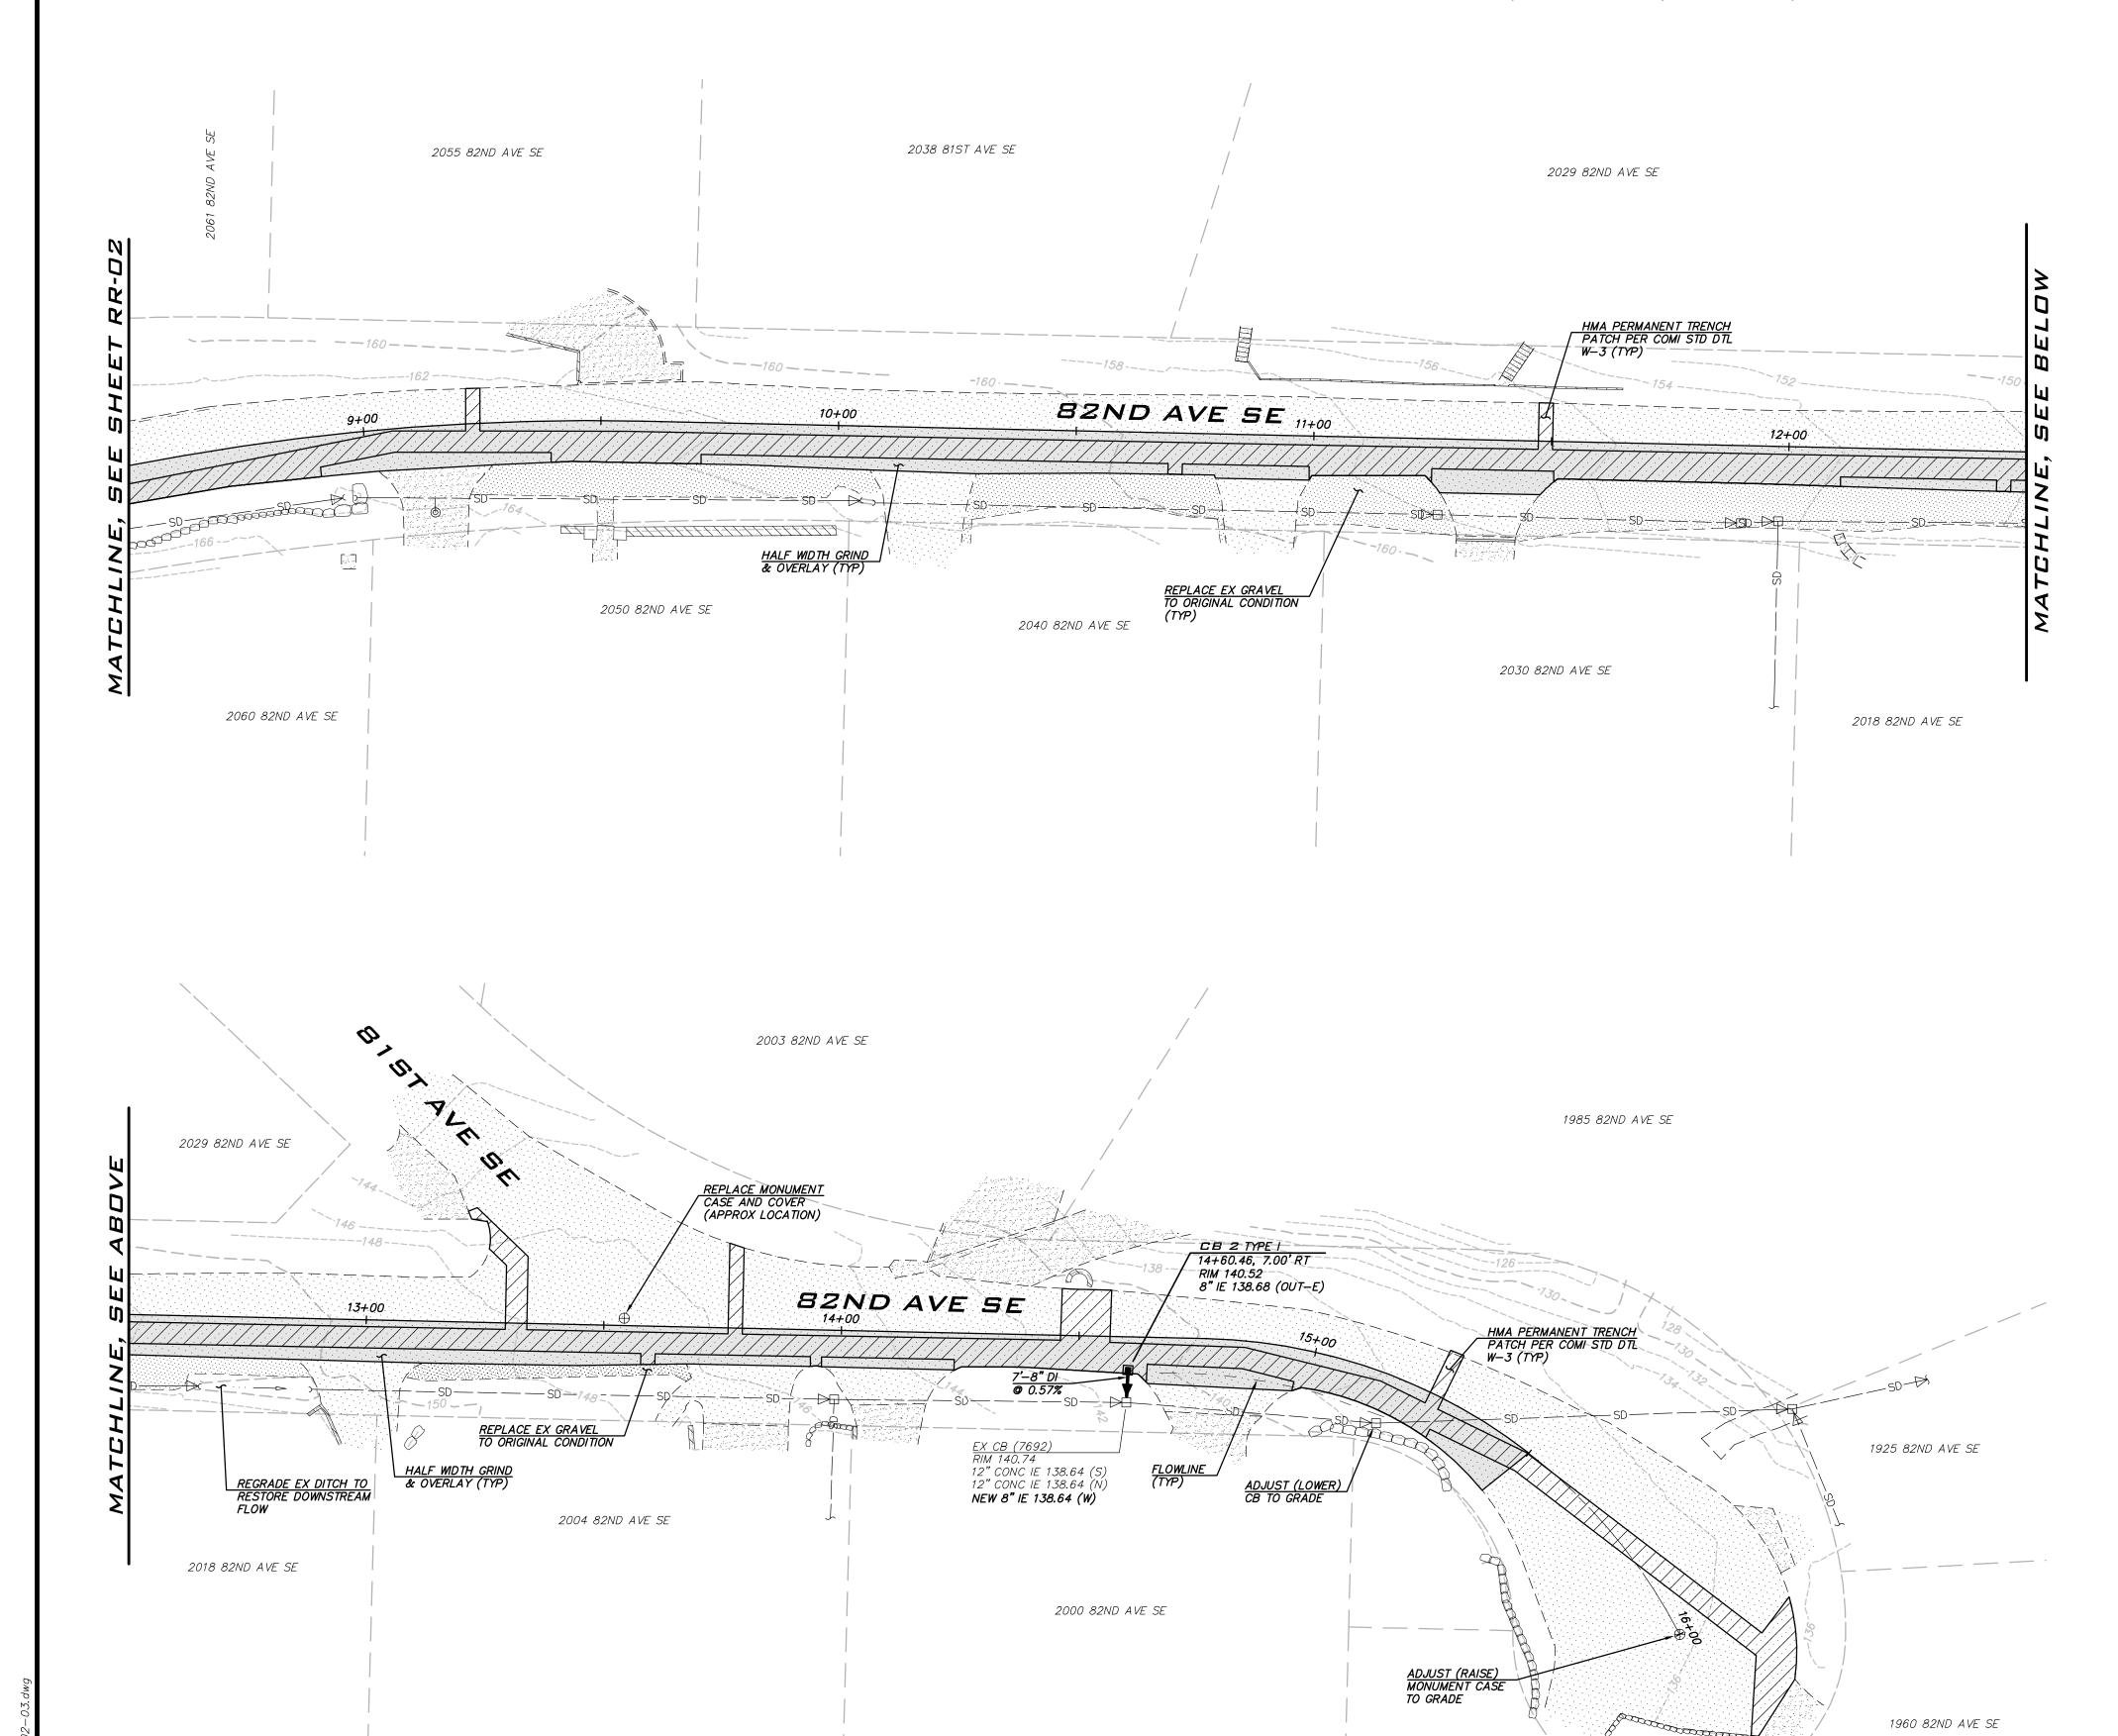

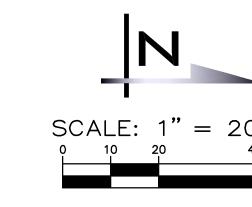

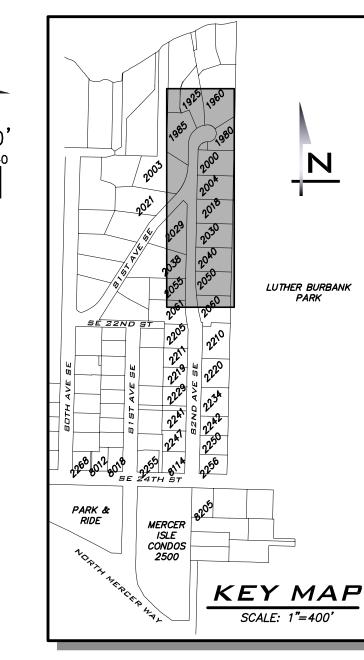

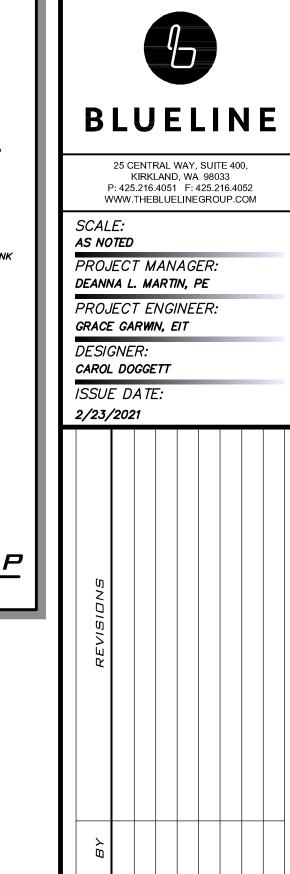


LE	GEND
	PERMANENT HMA TRENCH PATCH (SEE COMI STD DTL W-3)
	HALF WIDTH GRIND AND OVERLAY WITH 2" GRIND AND 2" OVERLAY
	ROADWAY RECONSTRUCTION AREA TO INCLUDE FULL DEPTH ASPHALT REMOVAL, PRELEVELING WITH CSTC, 4" MINIMUM COMPACTED HMA PLACED IN 2 LIFTS TO ACHIEVE 2% MINIMUM CROSS SLOPE.

### NOTES

- THE LOCATION OF THE PAVEMENT RESTORATION SHOWN IS APPROXIMATE ONLY AND THE EXACT LOCATION SHALL BE AS DIRECTED BY THE CITY CONSTRUCTION INSPECTOR DURING CONSTRUCTION.
- 2. CONTRACTOR IS RESPONSIBLE FOR BARRICADES & SIGNS OR OTHER NOTIFICATIONS AS APPROPRIATE IN ORDER TO ENSURE THAT RESIDENTS REMOVE AUTOMOBILES OR OTHER OBSTRUCTIONS FROM THE ROAD PRIOR TO PAVEMENT RESTORATION.

### EXISTING UTILITY NOTE


EXISTING UTILITIES ARE SHOWN IN THE APPROXIMATE LOCATION. THERE IS NO GUARANTEE THAT ALL UTILITY LINES ARE SHOWN, OR THAT THE LOCATION, SIZE AND MATERIAL IS ACCURATE. THE CONTRACTOR SHALL UNCOVER ALL INDICATED PIPING WHERE CROSSING, INTERFERENCES, OR CONNECTIONS OCCUR PRIOR TO TRENCHING OR EXCAVATION FOR ANY PIPE OR STRUCTURES, TO DETERMINE ACTUAL LOCATIONS, SIZE AND MATERIAL. THE CONTRACTOR SHALL MAKE THE APPROPRIATE PROVISION FOR PROTECTION OF SAID FACILITIES. THE CONTRACTOR SHALL NOTIFY ONE CALL AT 8-1-1 (WASHINGTON811.COM) AND ARRANGE FOR FIELD LOCATION OF EXISTING FACILITIES BEFORE CONSTRUCTION.

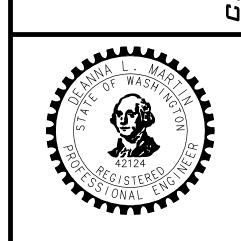



JOB NUMBER: 20-286


RR-03

sнт <u>21</u> ог <u>26</u>

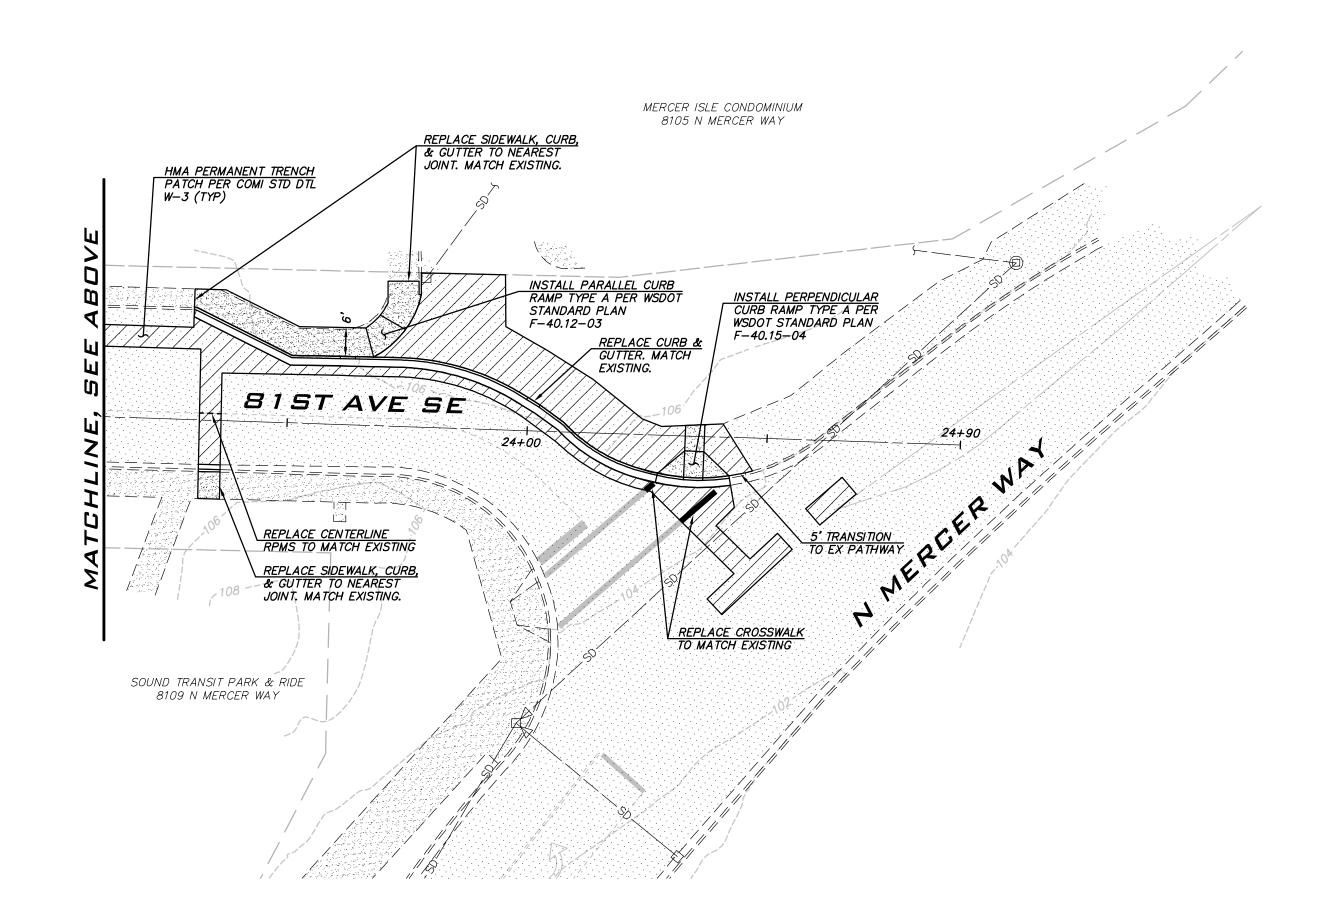

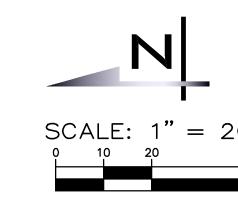

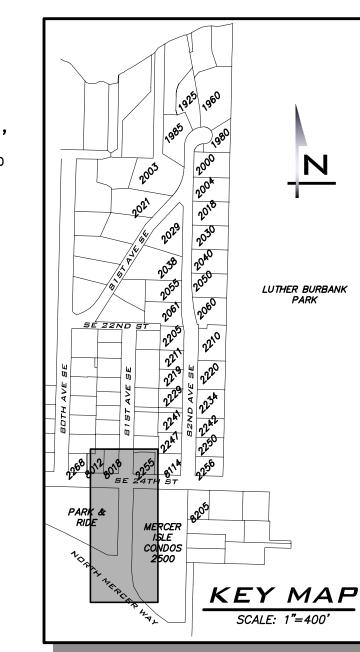

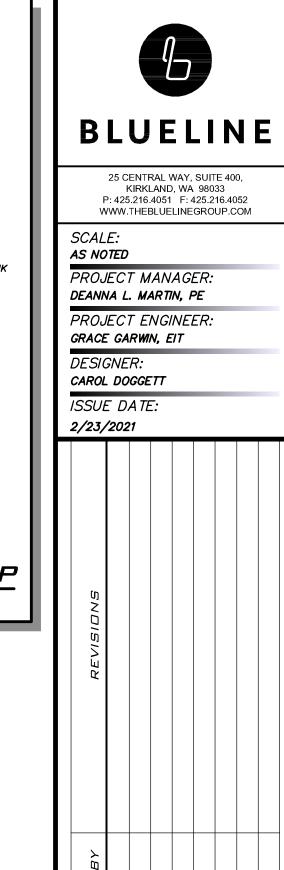

PERMANENT HMA TRENCH PATCH (SEE COMI STD DTL W-3)

HALF WIDTH GRIND AND OVERLAY WITH 2" GRIND AND 2" OVERLAY

ROADWAY RECONSTRUCTION AREA TO INCLUDE FULL DEPTH ASPHALT


REMOVAL, PRELEVELING WITH CSTC, 4" MINIMUM COMPACTED HMA PLACED IN 2 LIFTS TO ACHIEVE 2% MINIMUM CROSS SLOPE.

### NOTES

- 1. THE LOCATION OF THE PAVEMENT RESTORATION SHOWN IS APPROXIMATE ONLY AND THE EXACT LOCATION SHALL BE AS DIRECTED BY THE CITY CONSTRUCTION INSPECTOR DURING CONSTRUCTION.
- 2. CONTRACTOR IS RESPONSIBLE FOR BARRICADES & SIGNS OR OTHER NOTIFICATIONS AS APPROPRIATE IN ORDER TO ENSURE THAT RESIDENTS REMOVE AUTOMOBILES OR OTHER OBSTRUCTIONS FROM THE ROAD PRIOR TO PAVEMENT RESTORATION.

### EXISTING UTILITY NOTE


EXISTING UTILITIES ARE SHOWN IN THE APPROXIMATE LOCATION. THERE IS NO GUARANTEE THAT ALL UTILITY LINES ARE SHOWN, OR THAT THE LOCATION, SIZE AND MATERIAL IS ACCURATE. THE CONTRACTOR SHALL UNCOVER ALL INDICATED PIPING WHERE CROSSING, INTERFERENCES, OR CONNECTIONS OCCUR PRIOR TO TRENCHING OR EXCAVATION FOR ANY PIPE OR STRUCTURES, TO DETERMINE ACTUAL LOCATIONS, SIZE AND MATERIAL. THE CONTRACTOR SHALL MAKE THE APPROPRIATE PROVISION FOR PROTECTION OF SAID FACILITIES. THE CONTRACTOR SHALL NOTIFY ONE CALL AT 8-1-1 (WASHINGTON811.COM) AND ARRANGE FOR FIELD LOCATION OF EXISTING FACILITIES BEFORE CONSTRUCTION.

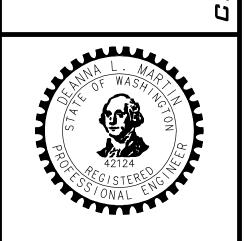

JOB NUMBER: **20-286** 

RR-04

T <u>22</u> of <u>26</u>

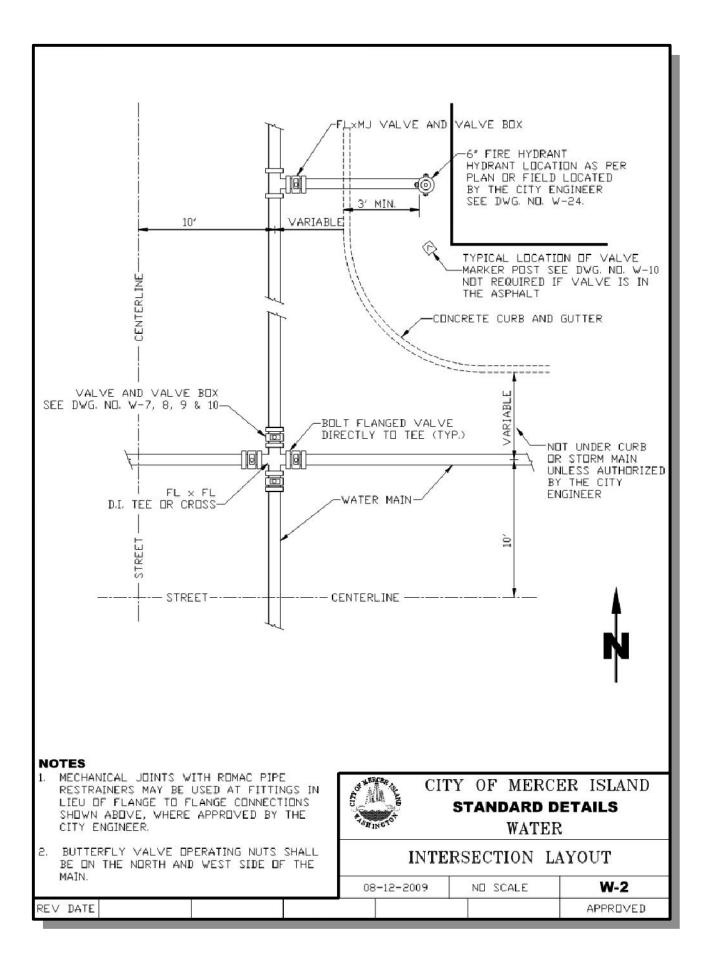

15/16"

**VALVE BOX LID** 

6 7/8" DIA.

6 3/4" DIA.

9 1/4" DIA.

6 5/8″ DIA.

6 1/8" DIA.

7 3/16° DIA.

VALVE BOX TOP

VALVE BOX SHALL BE OLYMPIC FOUNDRY PART NO. VB940 OR EQUAL.

LOCKING LID, WHEN REQUIRED, SHALL BE

OLYMPIC FOUNDRY PART NO. 13-5200 OR EQUAL.

THE TOP AND LID SHALL HAVE A MACHINED

5 5/8" DIA.

5 1/8" DIA.

7 1/2" DIA.

8" DIA.

**VALVE BOX BOTTOM** 

WATER VALVE BOX

3-20-2006 ND SCALE

8 3/4″ DIA.

CITY OF MERCER ISLAND

STANDARD DETAILS


WATER


-3/8" R


W-7

APPROVED


REV DATE

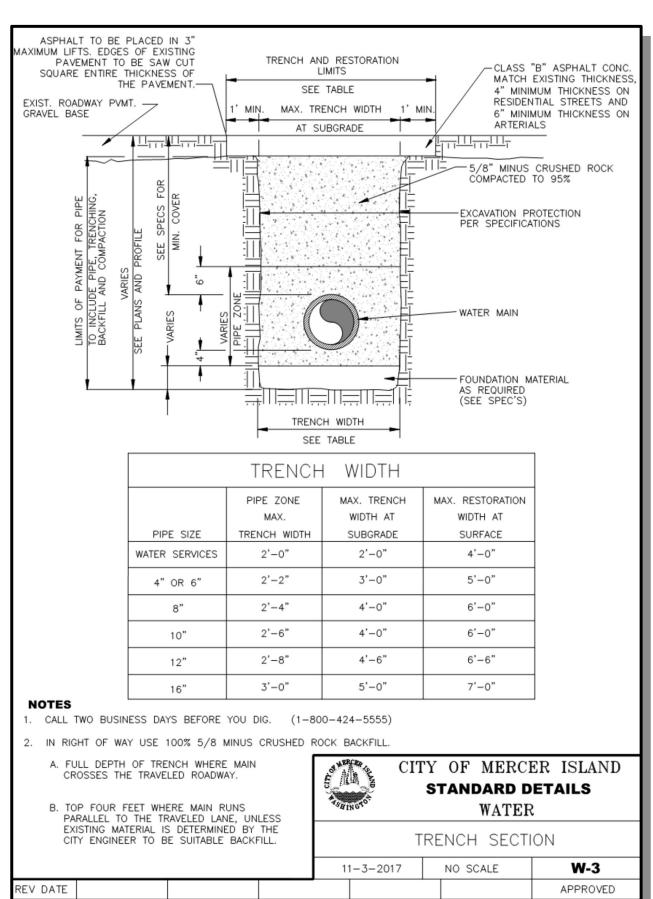


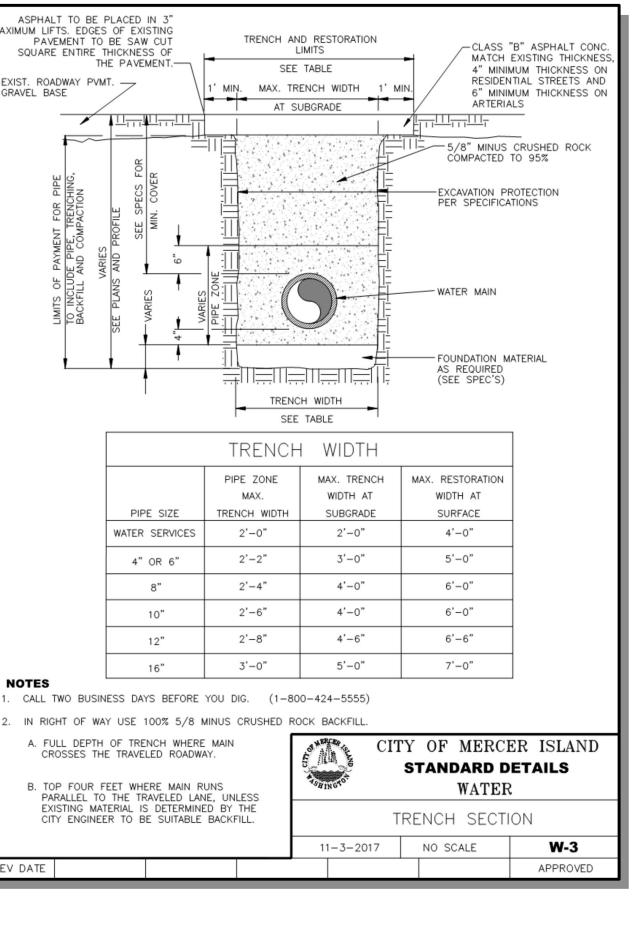


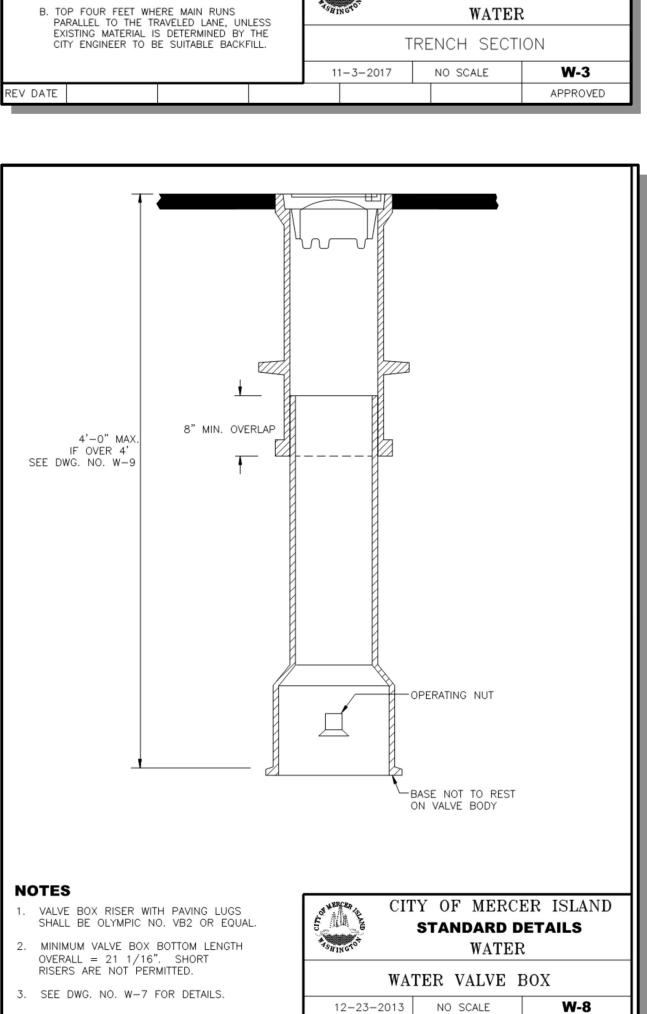


APPROVED

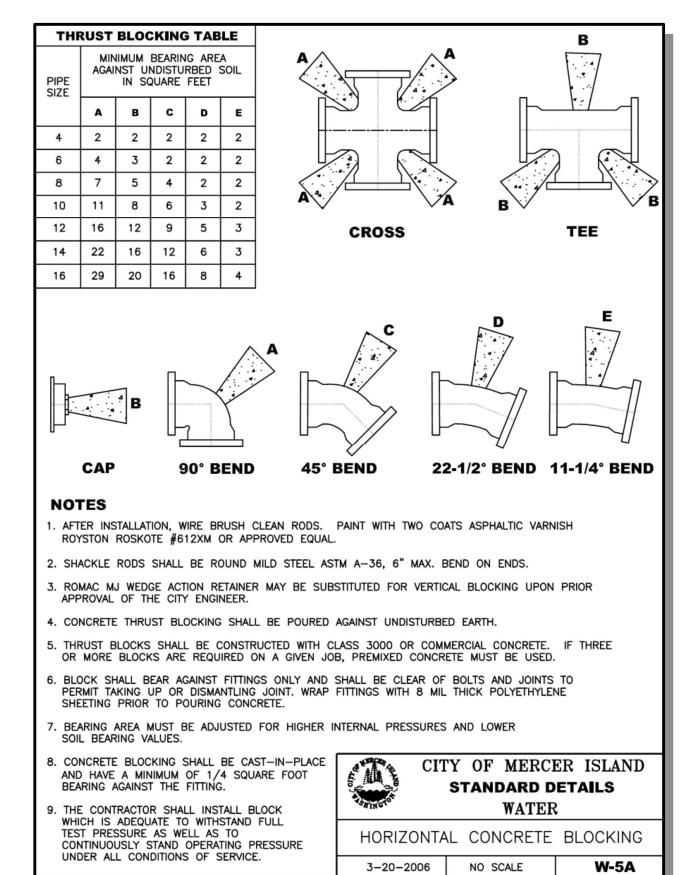


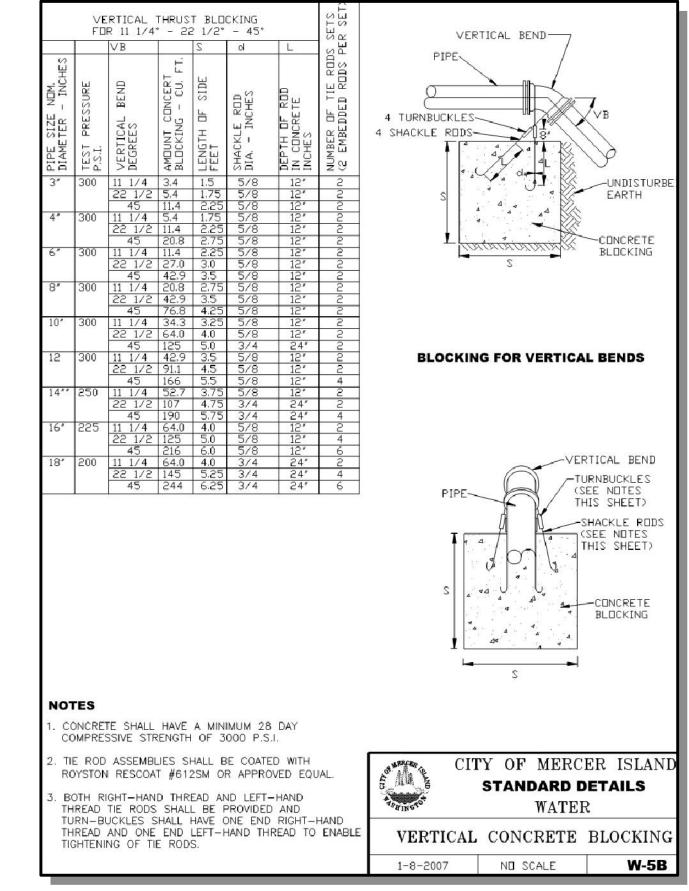

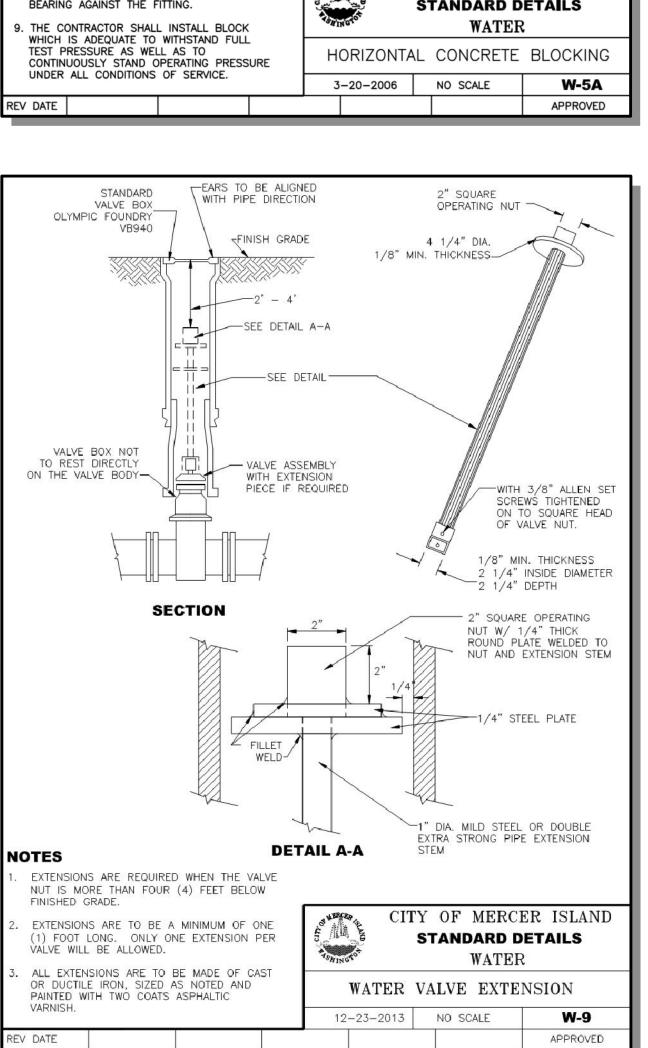

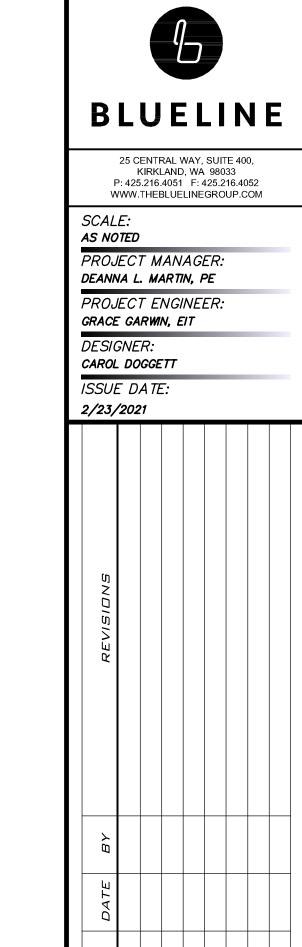



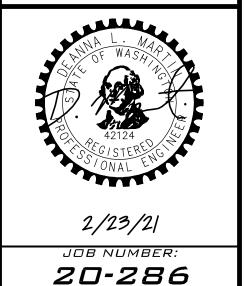


SHEET NAME: DT-01

sнт <u>23</u> ог <u>26</u>

NOTES


REV DATE

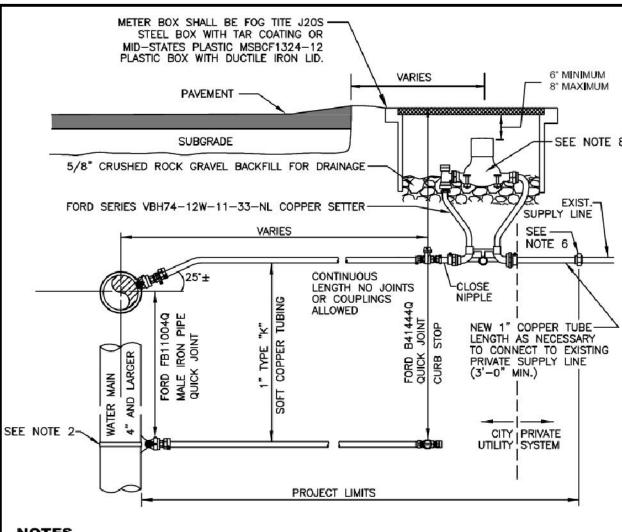



### NOTES

- . WATER SERVICES SHALL COMPLY WITH THE REDUCTION OF LEAD IN DRINKING WATER ACT DATED 01/04/2014. 2. ON EXISTING WATER MAINS USE NYLON COATED D.I. SADDLE WITH STAINLESS STEEL DOUBLE STRAPS, ROMAC 202NS, OR APPROVED EQUAL.
- 3. MINIMUM DISTANCE BETWEEN CORP STOPS SHALL BE 18". MINIMUM DISTANCE BETWEEN TAPS, BETWEEN CORP STOP AND PIPE ENDS SHALL BE 24", ALL HORIZONALLY STAGGERED.
- 4. PLASTIC METER BOXES SHALL NOT BE INSTALLED WITHIN ROADWAY, SIDEWALK, OR DRIVEWAYS.
- 5. UPON CITY ENGINEER'S APPROVAL, METER BOXES ARE ALLOWED TO BE INSTALLED IN PORTLAND CEMENT CONCRETE PAVEMENT OR SIDEWALK.
- 3. WHEN CONNECTING TO EXISTING PRIVATE SUPPLY LINE CONTAINING FERROUS METAL, PROVIDE INSULATING COUPLING (DB SERIES WITH C21 SERIES ADAPTERS) AND PROVIDE REDUCER AS NECESSARY TO MATCH EXISTING PRIVATE SUPPLY LINE DIAMETER.
- 7. SERVICE LINE SHALL BE PERPENDICULAR TO THE WATER MAIN AND STRAIGHT TO WATER METER, UNLESS OTHERWISE APPROVED BY CITY ENGINEER. PROVIDE WINDING SLACK IN THE SERVICE LINE BETWEEN THE MAIN AND WATER METER.
- B. WATER METER SUPPLIED BY CITY.
- ALL FITTINGS TO BE BRASS COMPRESSION TYPE, FORD QUICK JOINT OR EQUAL.

10. NO SERVICE CONNECTIONS BETWEEN BLOW-OFF REV DATE

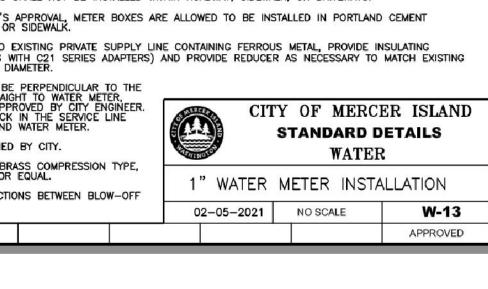

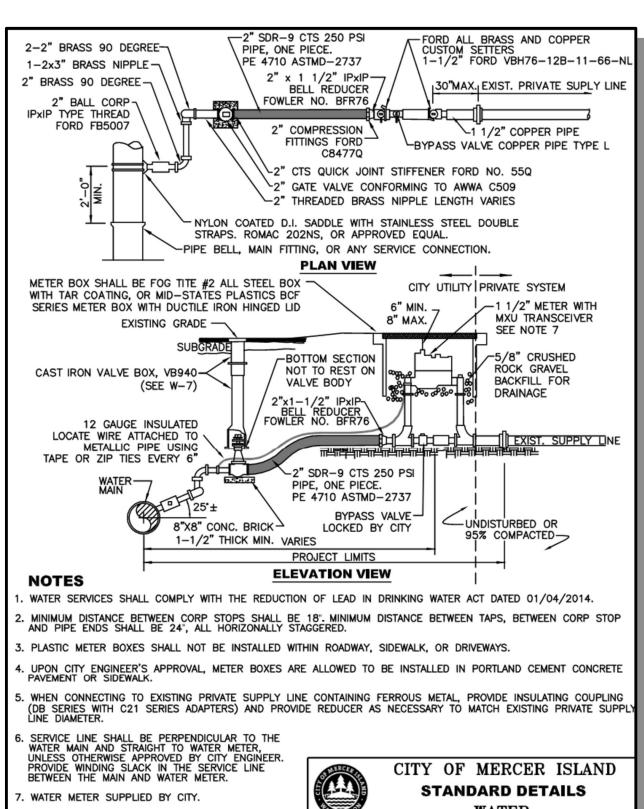

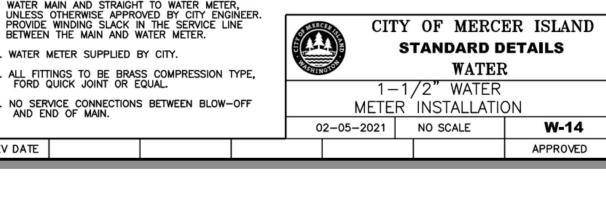

REV DATE

" BRASS COUPLING -

" THREADED BRASS -

STAINLESS STEEL

THREADED PVC

HOLE DRILLED


CAP WITH A 1/4"


COMPACTED SOIL

OR CRUSHED ROCK


NOTES


REV DATE

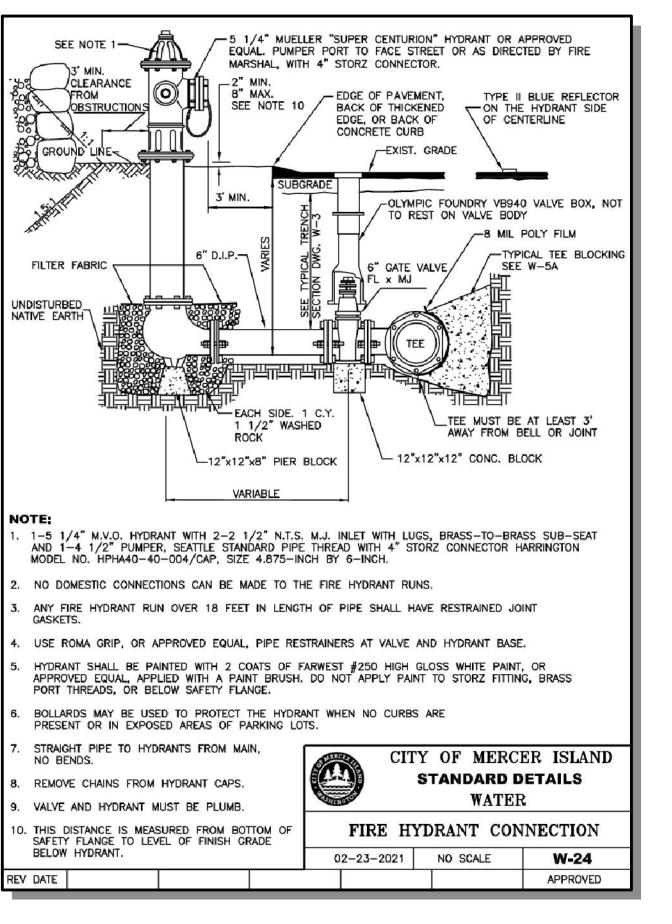


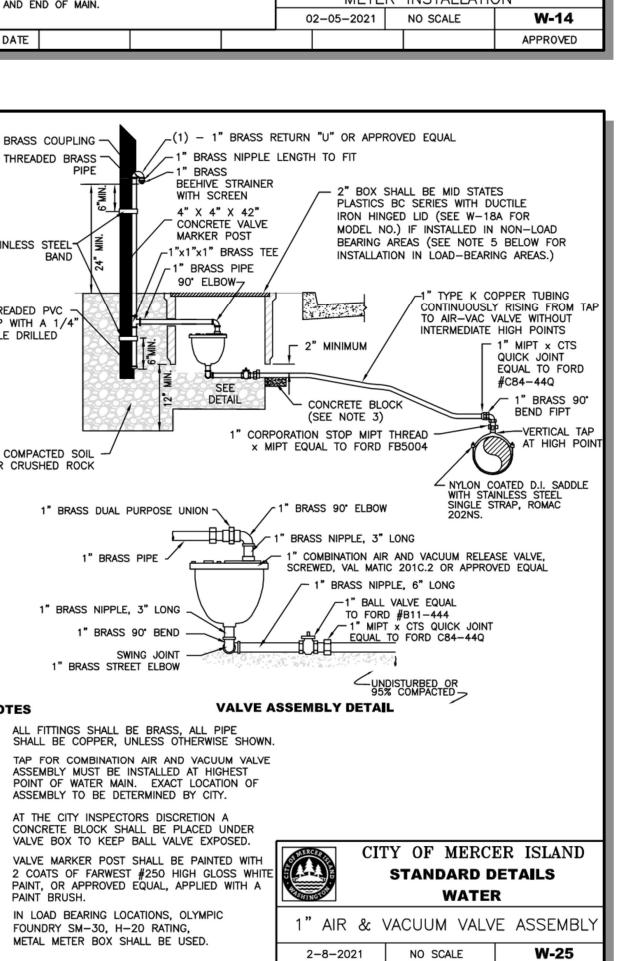



APPROVED

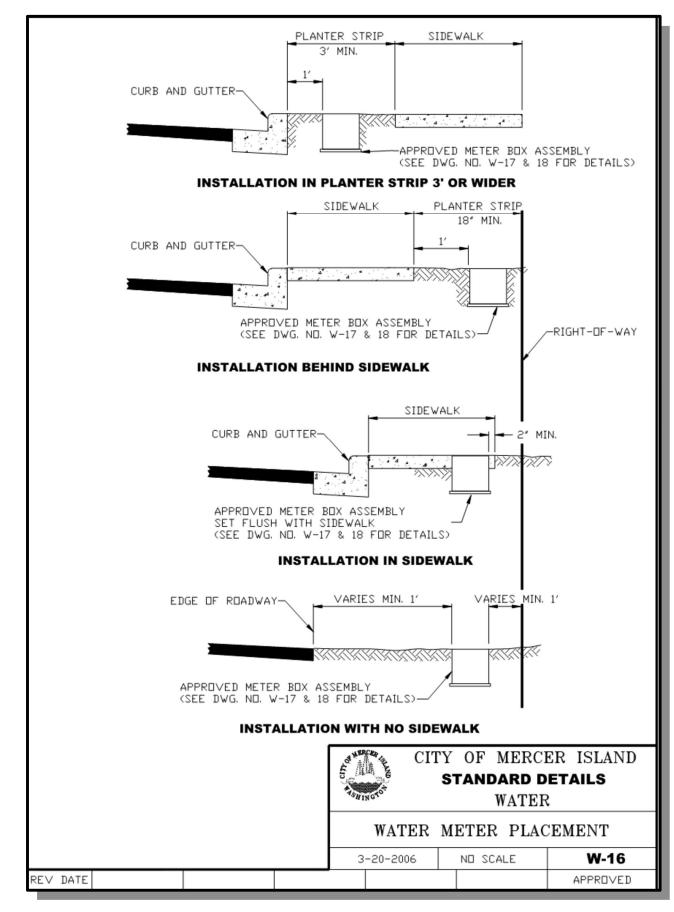


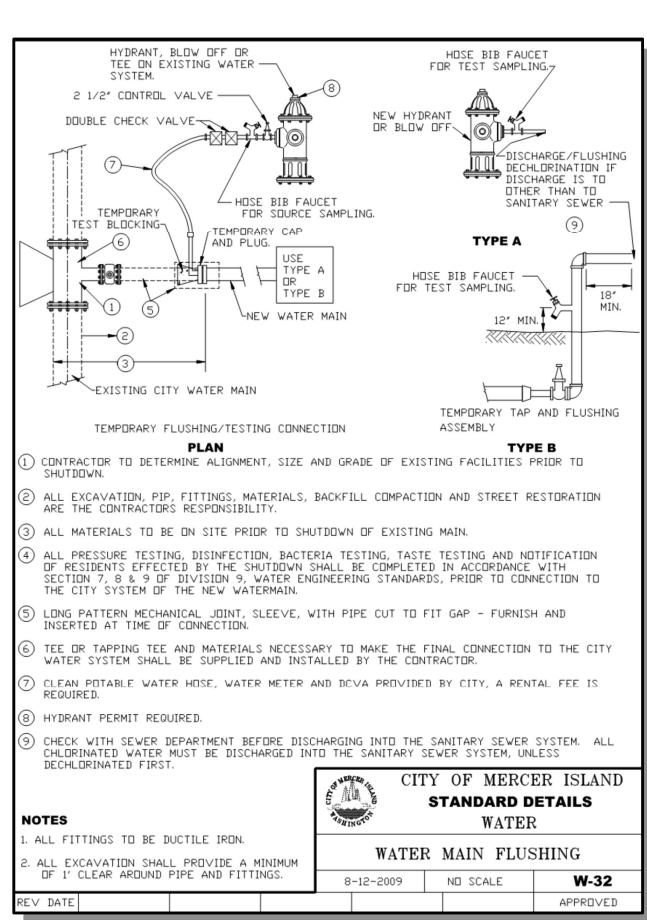

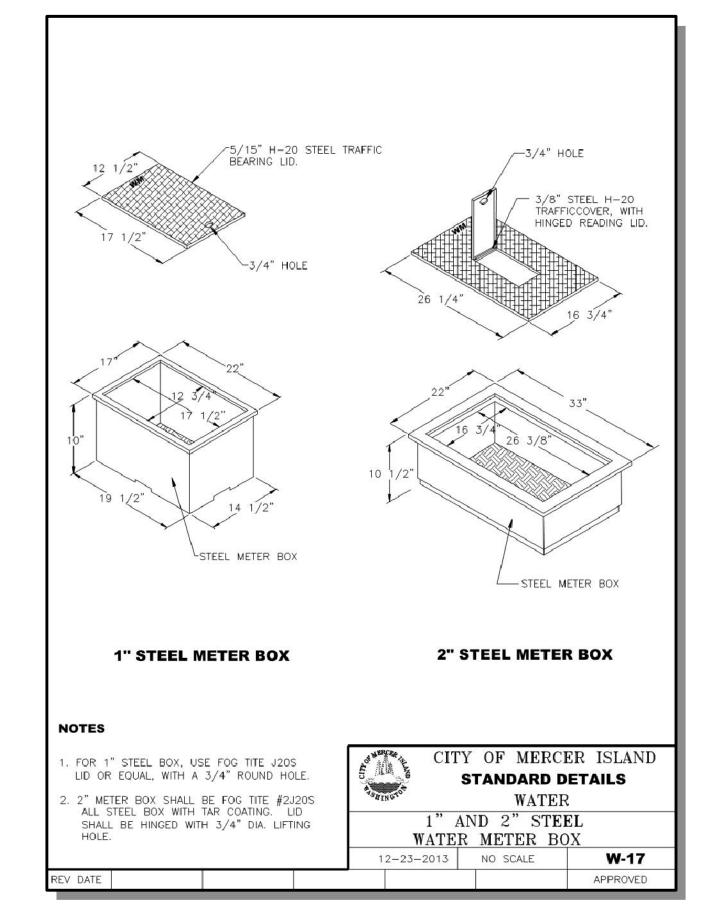

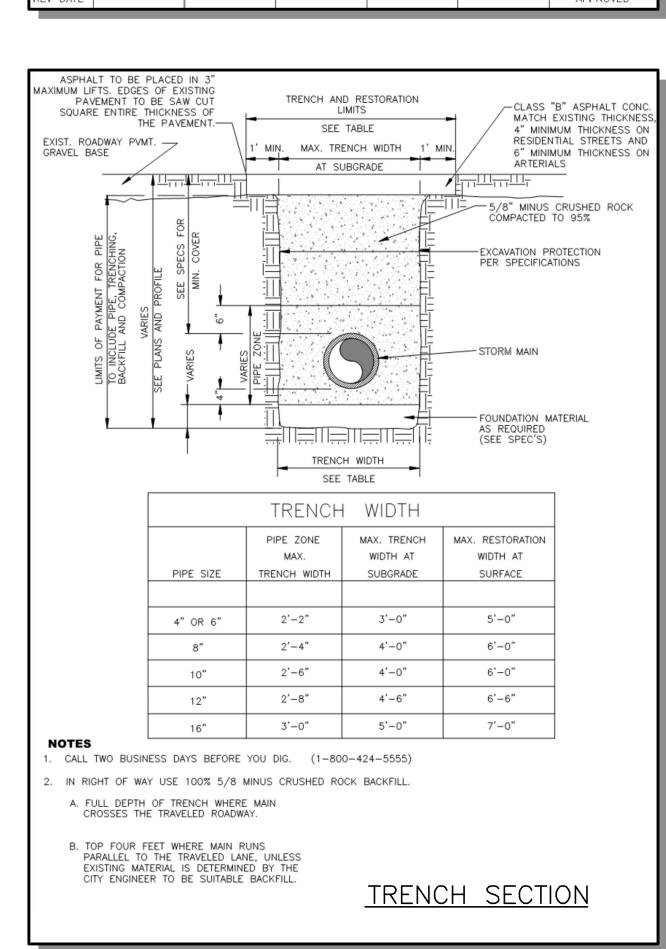

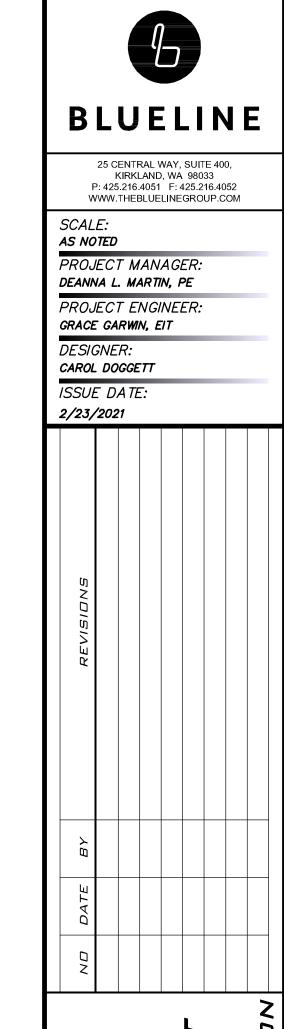


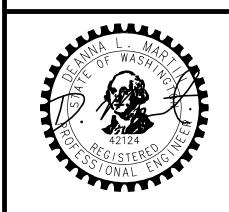



JOB NUMBER: 20-286 SHEET NAME:


DT-02

© 2021 THE BLUELINE GROUP

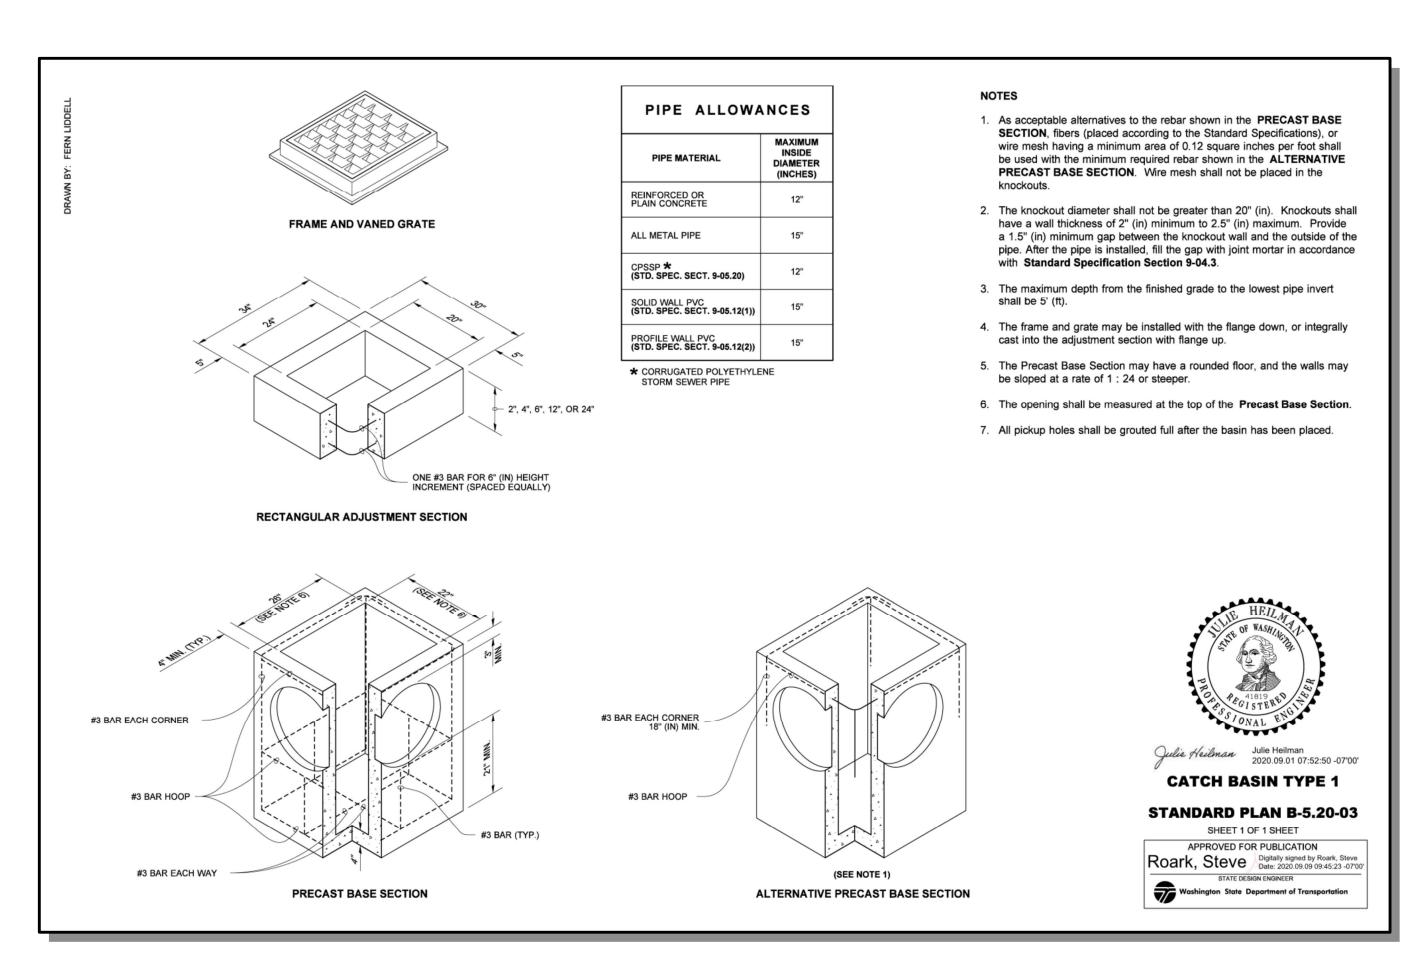

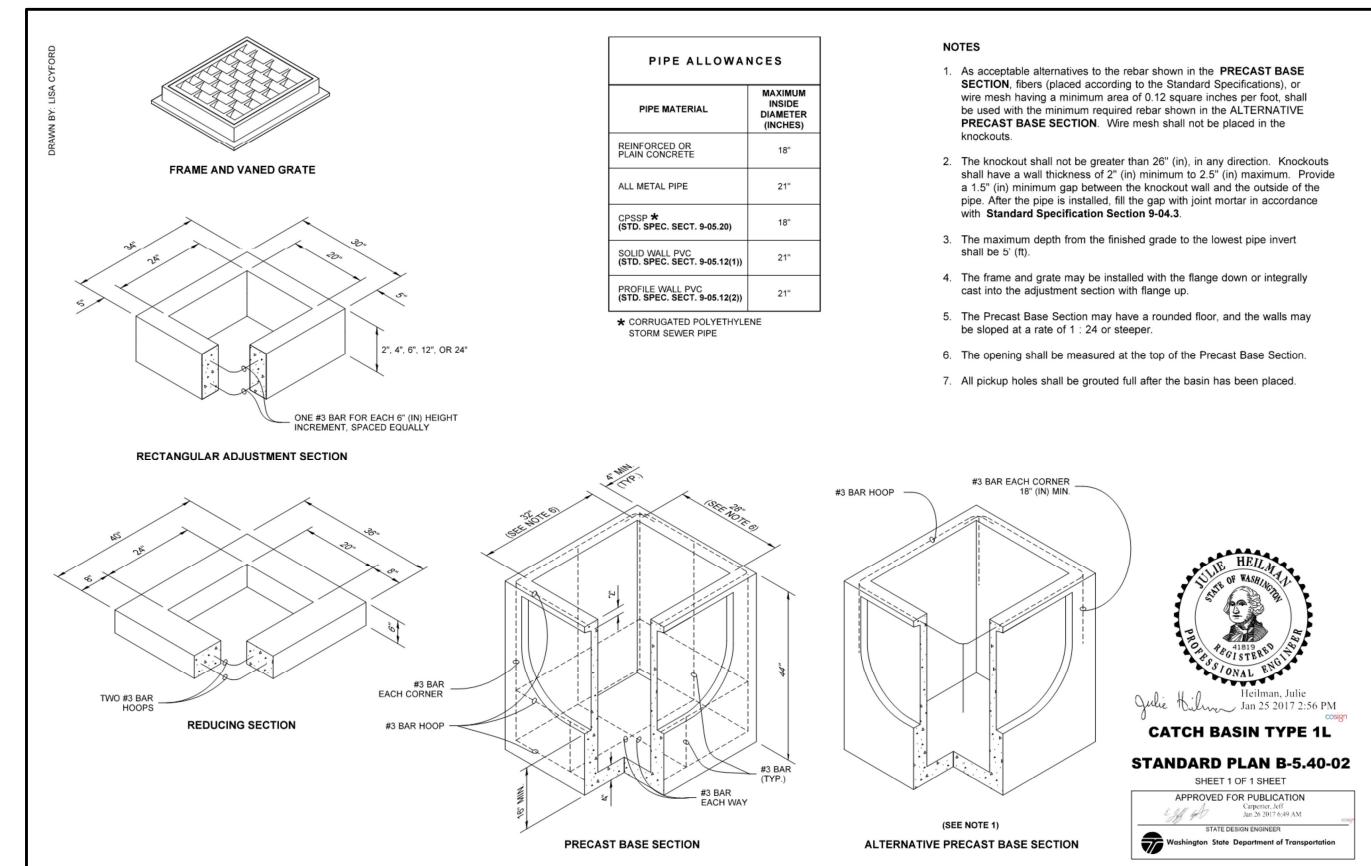

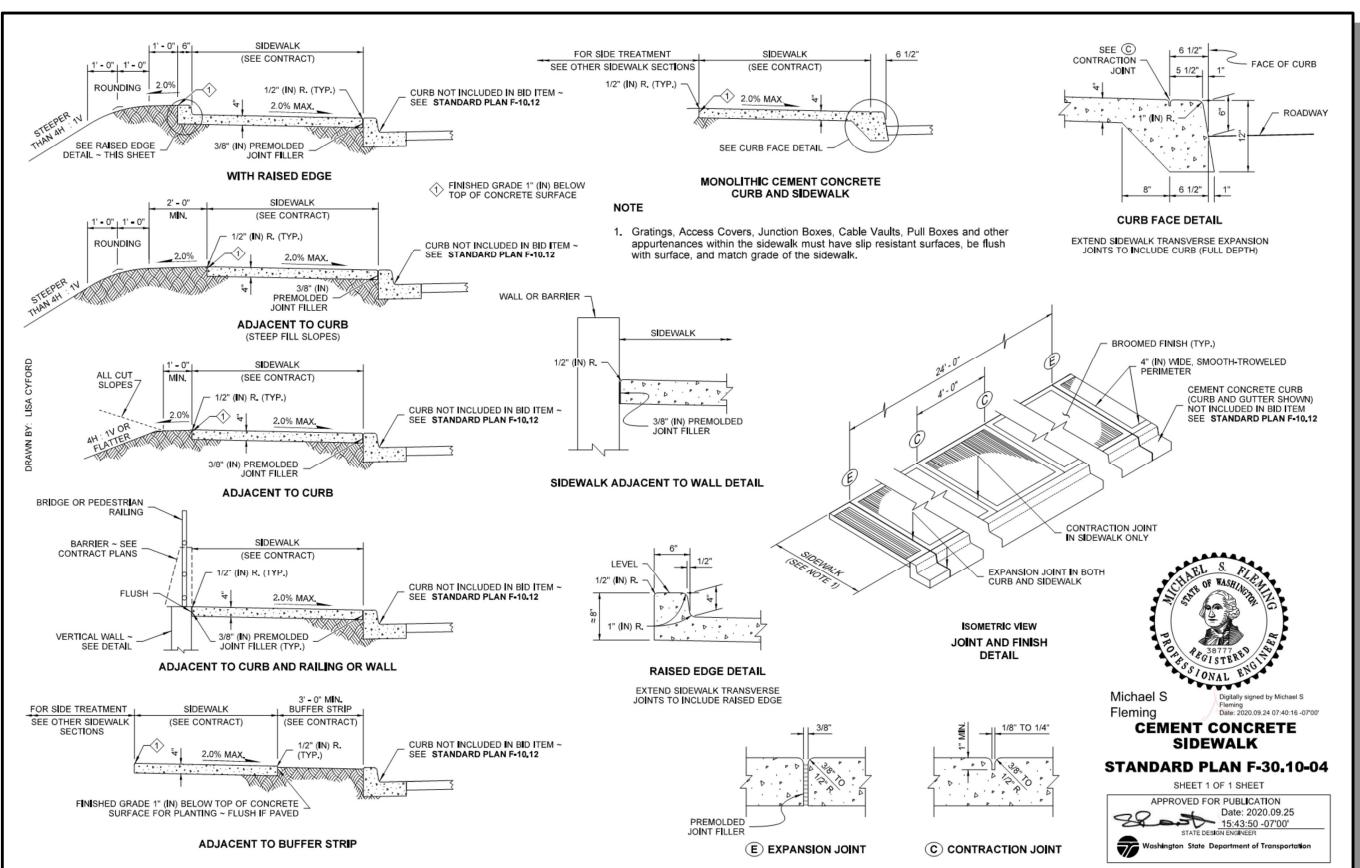

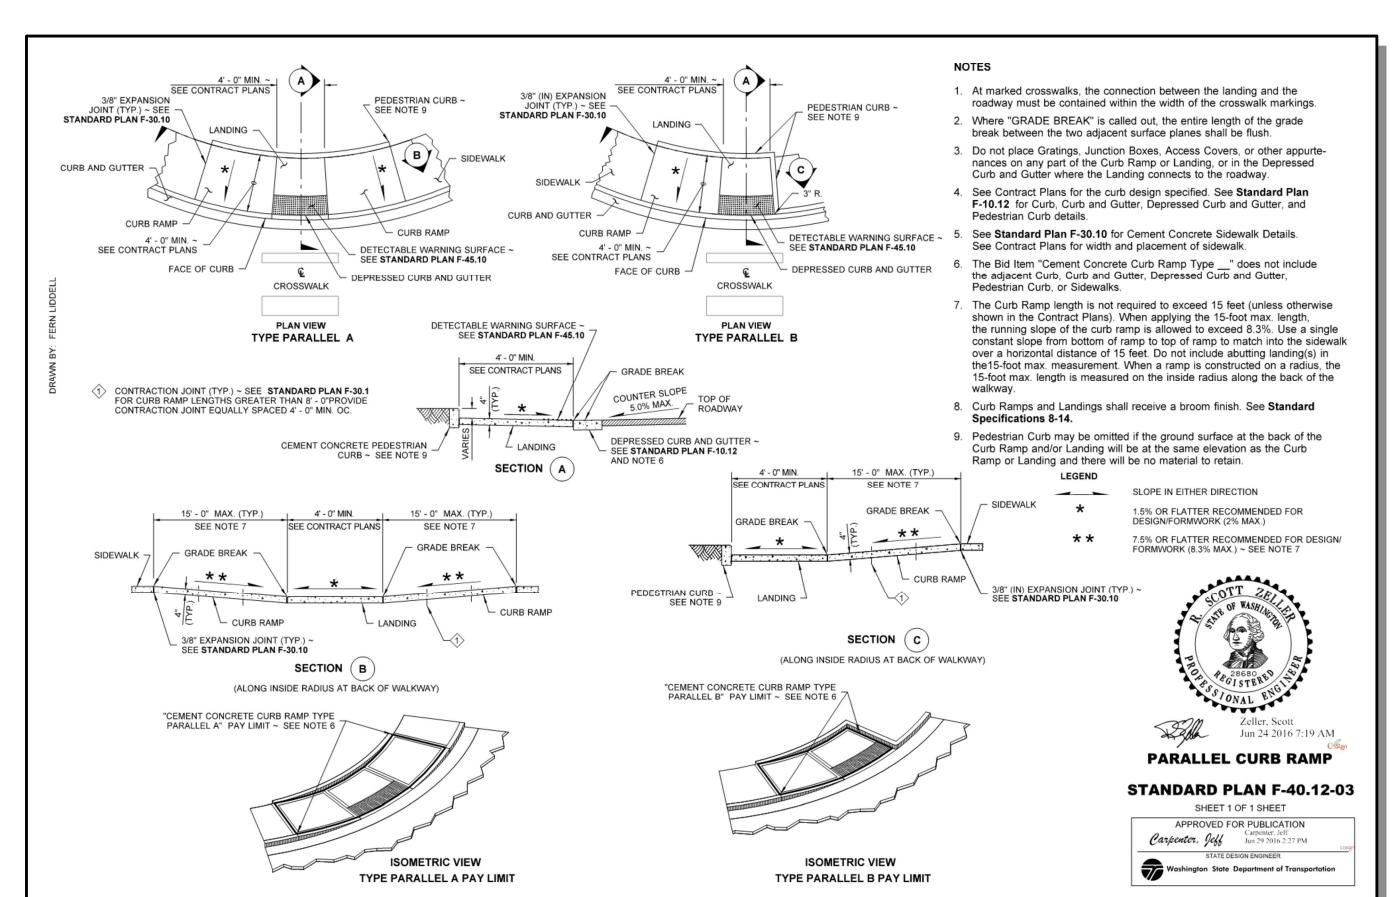



25 CENTRAL WAY, SUITE 400, KIRKLAND, WA 98033 P: 425.216.4051 F: 425.216.4052 WWW.THEBLUELINEGROUP.COM

SCALE: AS NOTED

PROJECT MANAGER: DEANNA L. MARTIN, PE

PROJECT ENGINEER:

GRACE GARWIN, EIT

DESIGNER:


CAROL DOGGETT

ISSUE DATE:

2/23/2021

JOB NUMBER: 20-286

SHEET NAME: DT-03

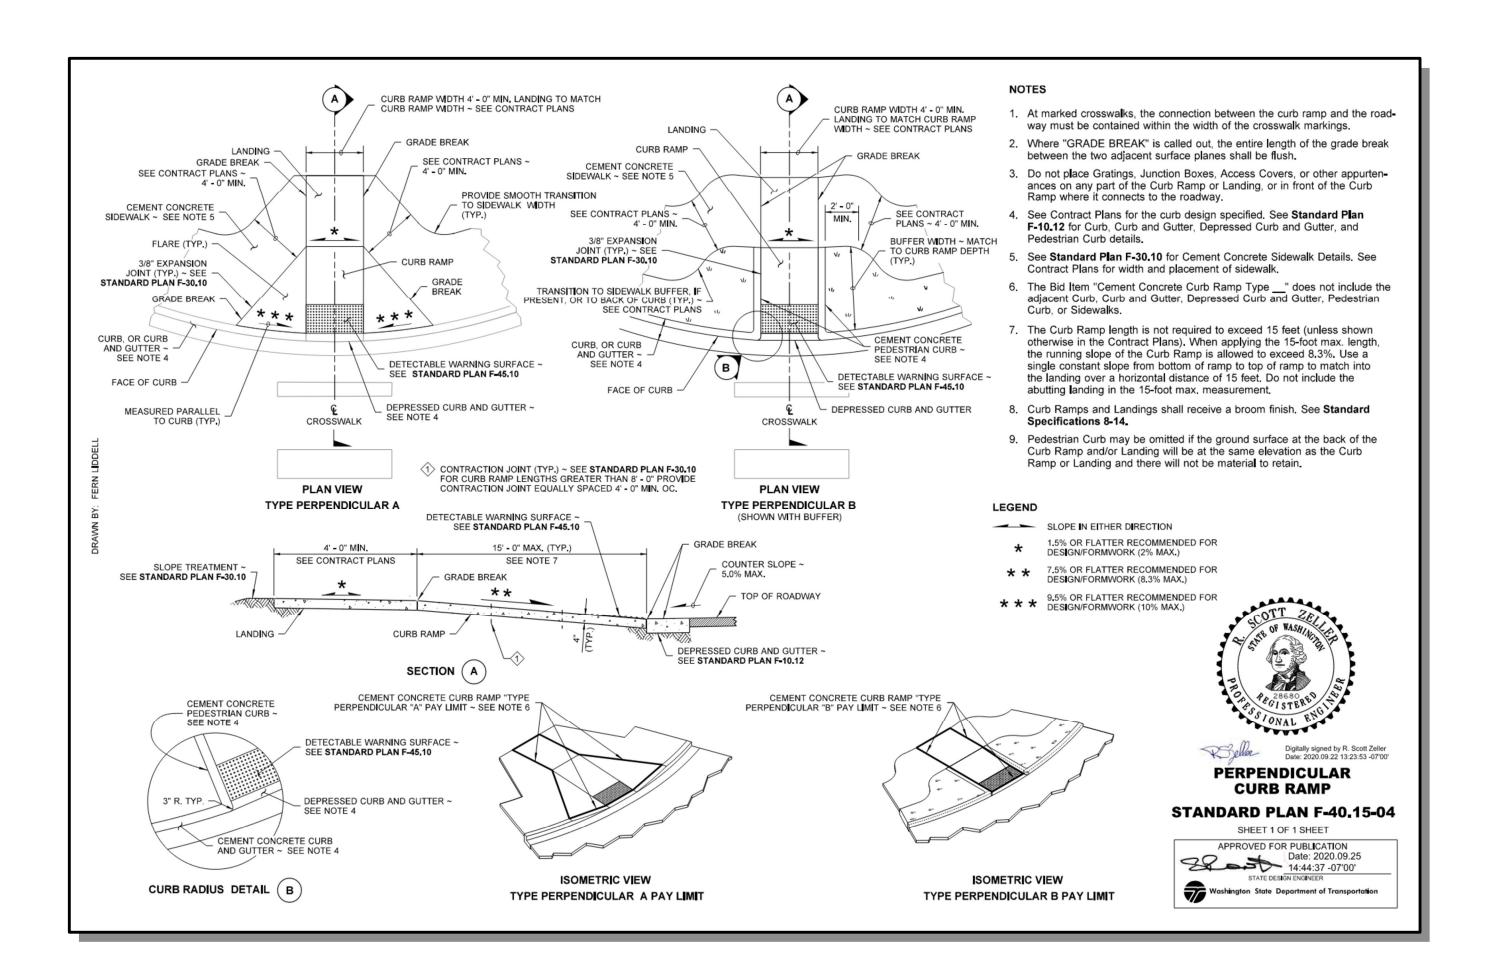



25 CENTRAL WAY, SUITE 400, KIRKLAND, WA 98033 P: 425.216.4051 F: 425.216.4052 WWW.THEBLUELINEGROUP.COM

SCALE: AS NOTED

PROJECT MANAGER: DEANNA L. MARTIN, PE


PROJECT ENGINEER: GRACE GARWIN, EIT

DESIGNER:

CAROL DOGGETT

ISSUE DATE:

2/23/2021

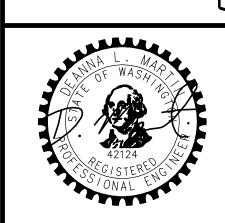

JOB NUMBER: 20-286

DT-04

sнт <u>26</u> ог <u>26</u>

## © 2021 THE BLUELINE GROUP