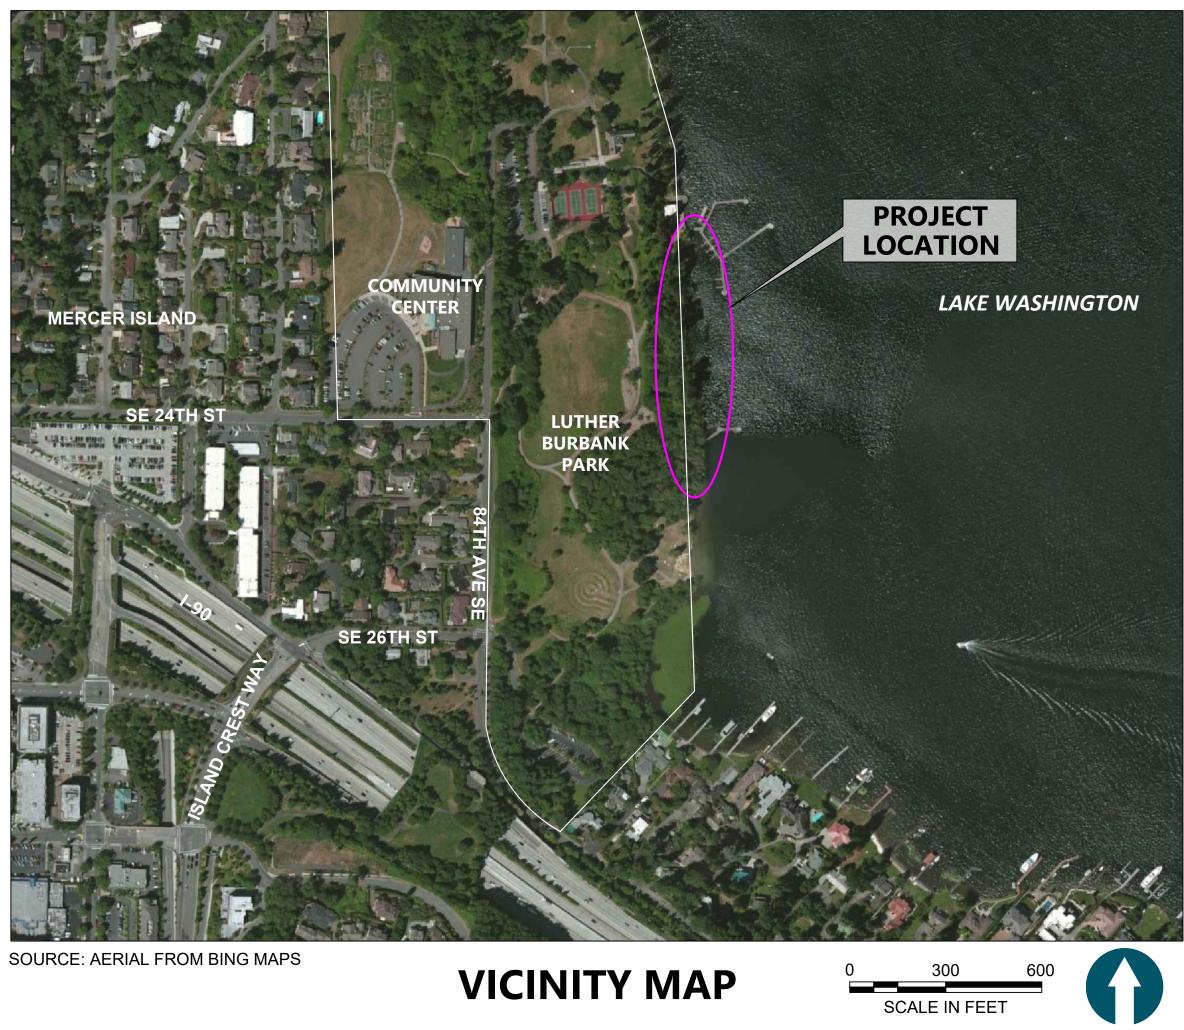
BID SET 22-35 LUTHER BURBANK SOUTH SHORELINE RESTORATION CITY OF MERCER ISLAND PUBLIC WORKS DEPARTMENT







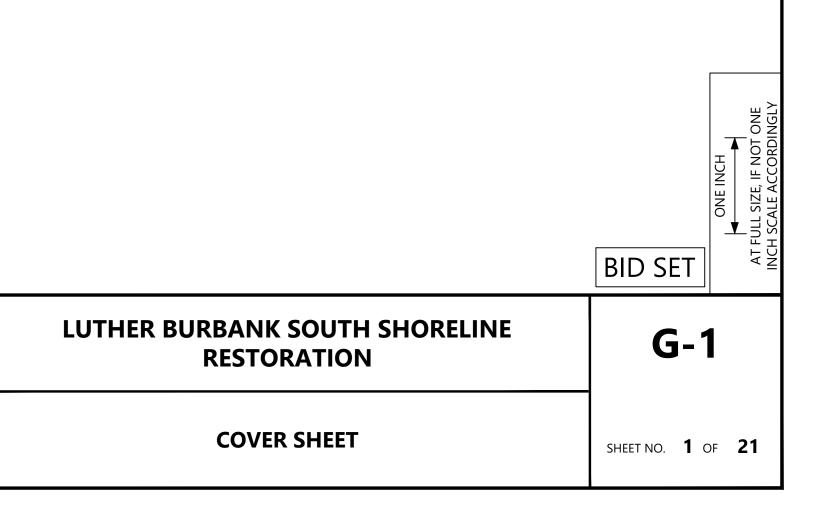
SHEET SEQUENCE S	SHEET NO.						
1		SHEET DESCRIPTION					
	G-1	COVER SHEET					
2	G-2	COMPOSITE SITE PLAN AND SHEET LAYOUT KEY					
3	G-3	EXISTING CONDITIONS PLAN (SURVEY)					
4	G-4	EXISTING CONDITIONS PLAN (SURVEY)					
5	G-5	EXISTING CONDITIONS PHOTOGRAPHS					
6	D-1	DEMOLITION, CLEARING, AND TESC PLAN					
7	D-2	DEMOLITION, CLEARING, AND TESC PLAN					
8	D-3	DEMOLITION, CLEARING, TESC DETAILS & NOTES					
9	C-1	GRADING AND DRAINAGE PLAN					
10	C-2	GRADING AND DRAINAGE PLAN					
11	C-3	GRADING CROSS SECTIONS					
12	CM-1	CONSTRUCTION MATERIALS & LAYOUT PLAN					
13	CM-2	CONSTRUCTION MATERIALS & LAYOUT PLAN					
14	CM-3	CONSTRUCTION DETAILS					
15	CM-4	CONSTRUCTION DETAILS					
16	I-1	IRRIGATION PLAN					
17	I-2	IRRIGATION PLAN					
18	I-3	IRRIGATION DETAILS					

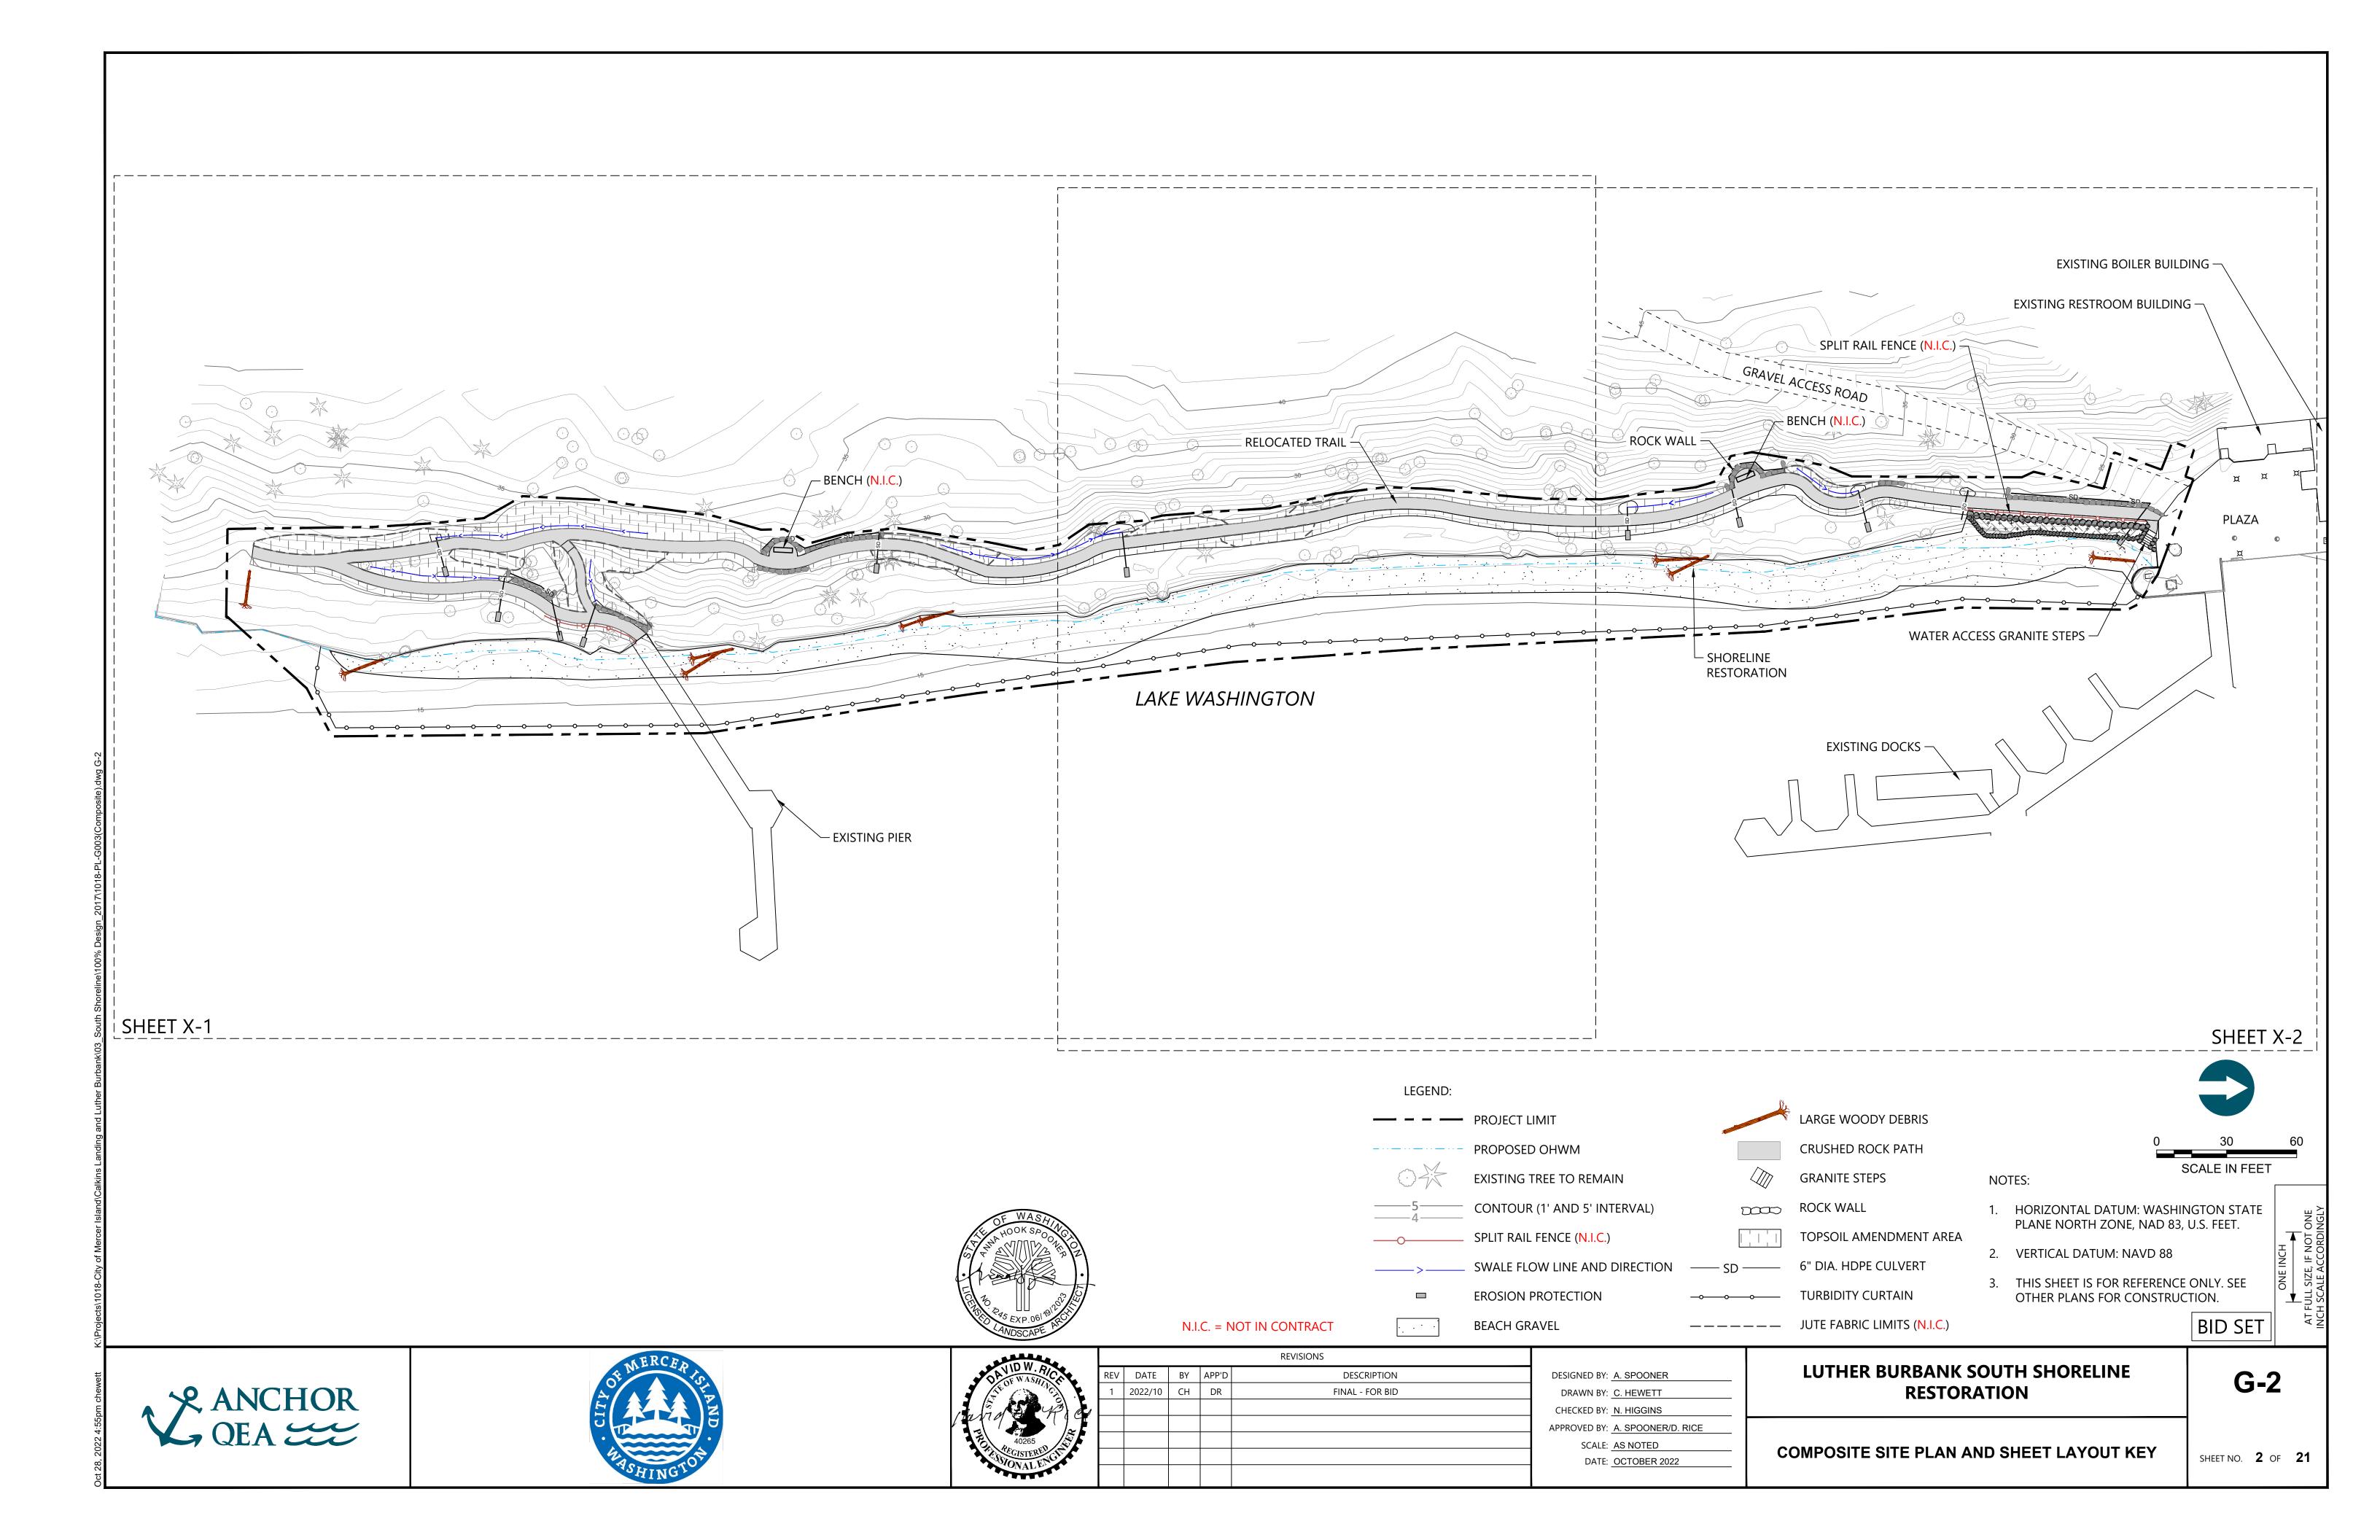
DRAWING INDEX (NOT IN CONTRACT, PROVIDED FOR CLARITY ONLY)

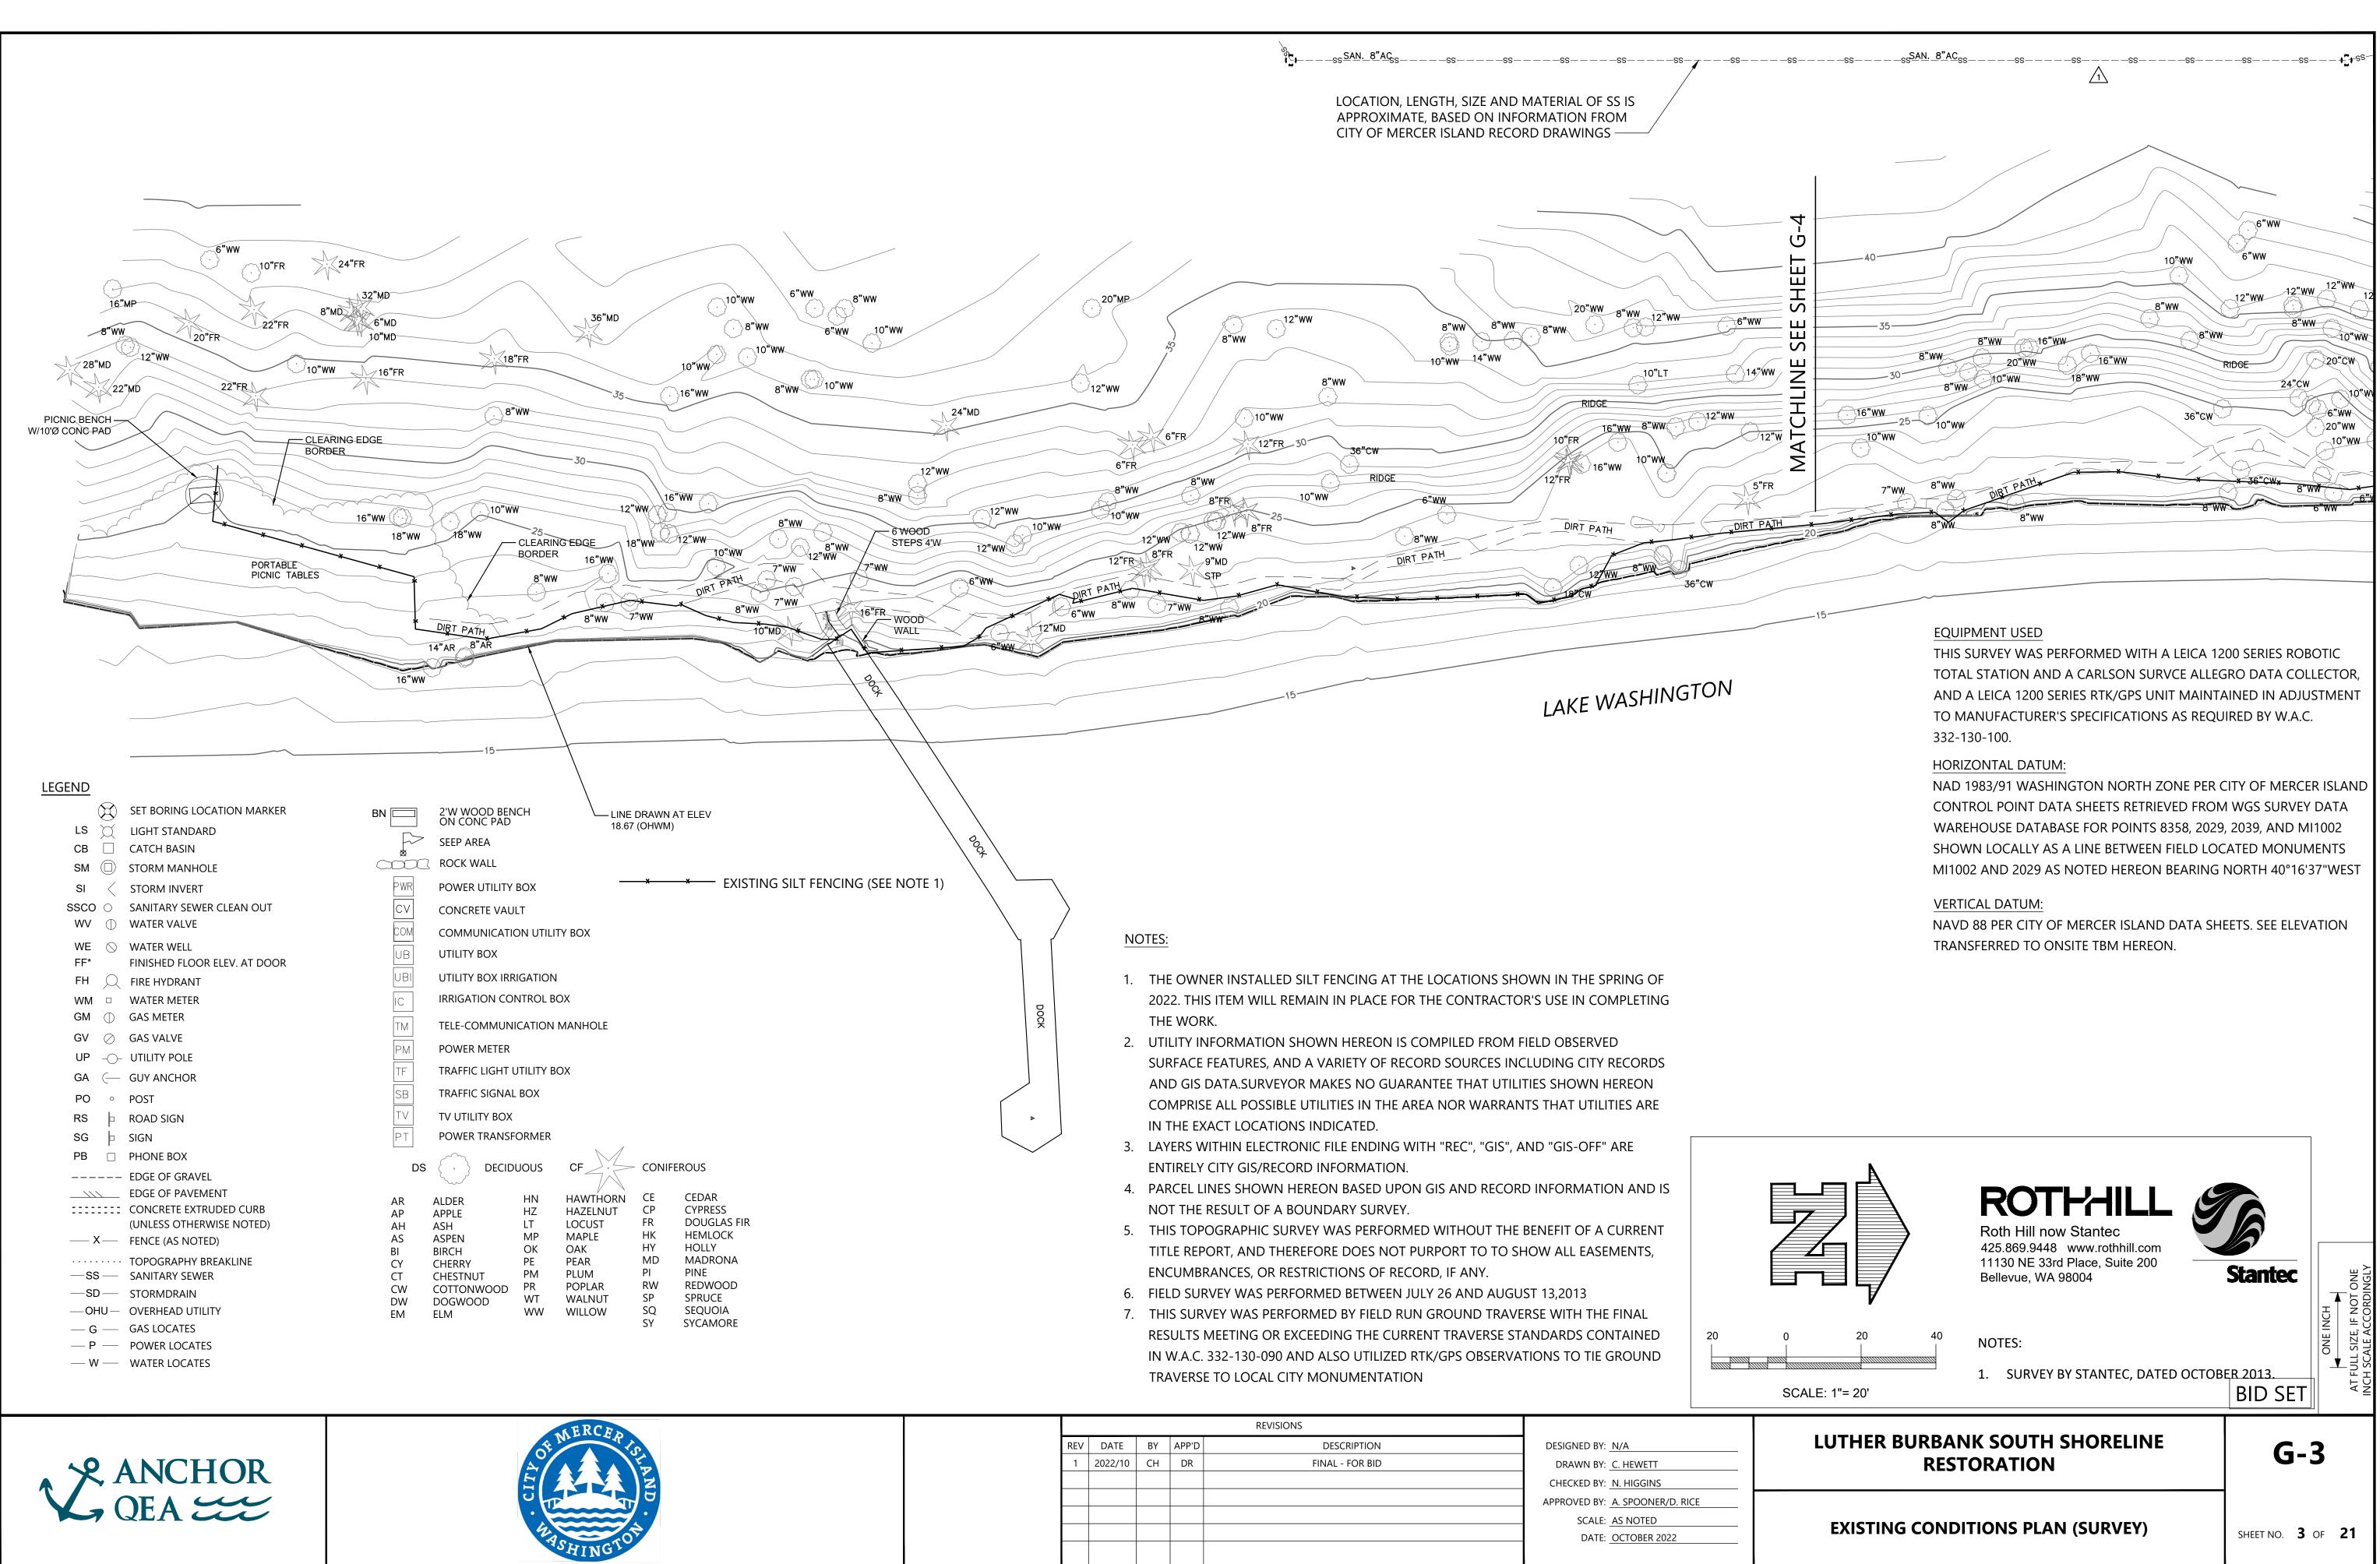
SHEET SEQUENCE	SHEET NO.	SHEET DESCRIPTION
19	L-1	PLANTING PLAN
20	L-2	PLANTING PLAN
21	L-3	PLANTING DETAILS



					REVISIONS	
e.	REV	DATE	BY	APP'D	DESCRIPTION	DESIGNED BY: A. SPOONER
	1	2022/10	СН	DR	FINAL - FOR BID	DRAWN BY: <u>C. HEWETT</u>
a						CHECKED BY: N. HIGGINS
ER .						APPROVED BY: <u>A. SPOONER/D. RICE</u>
						SCALE: AS NOTED
						DATE: OCTOBER 2022



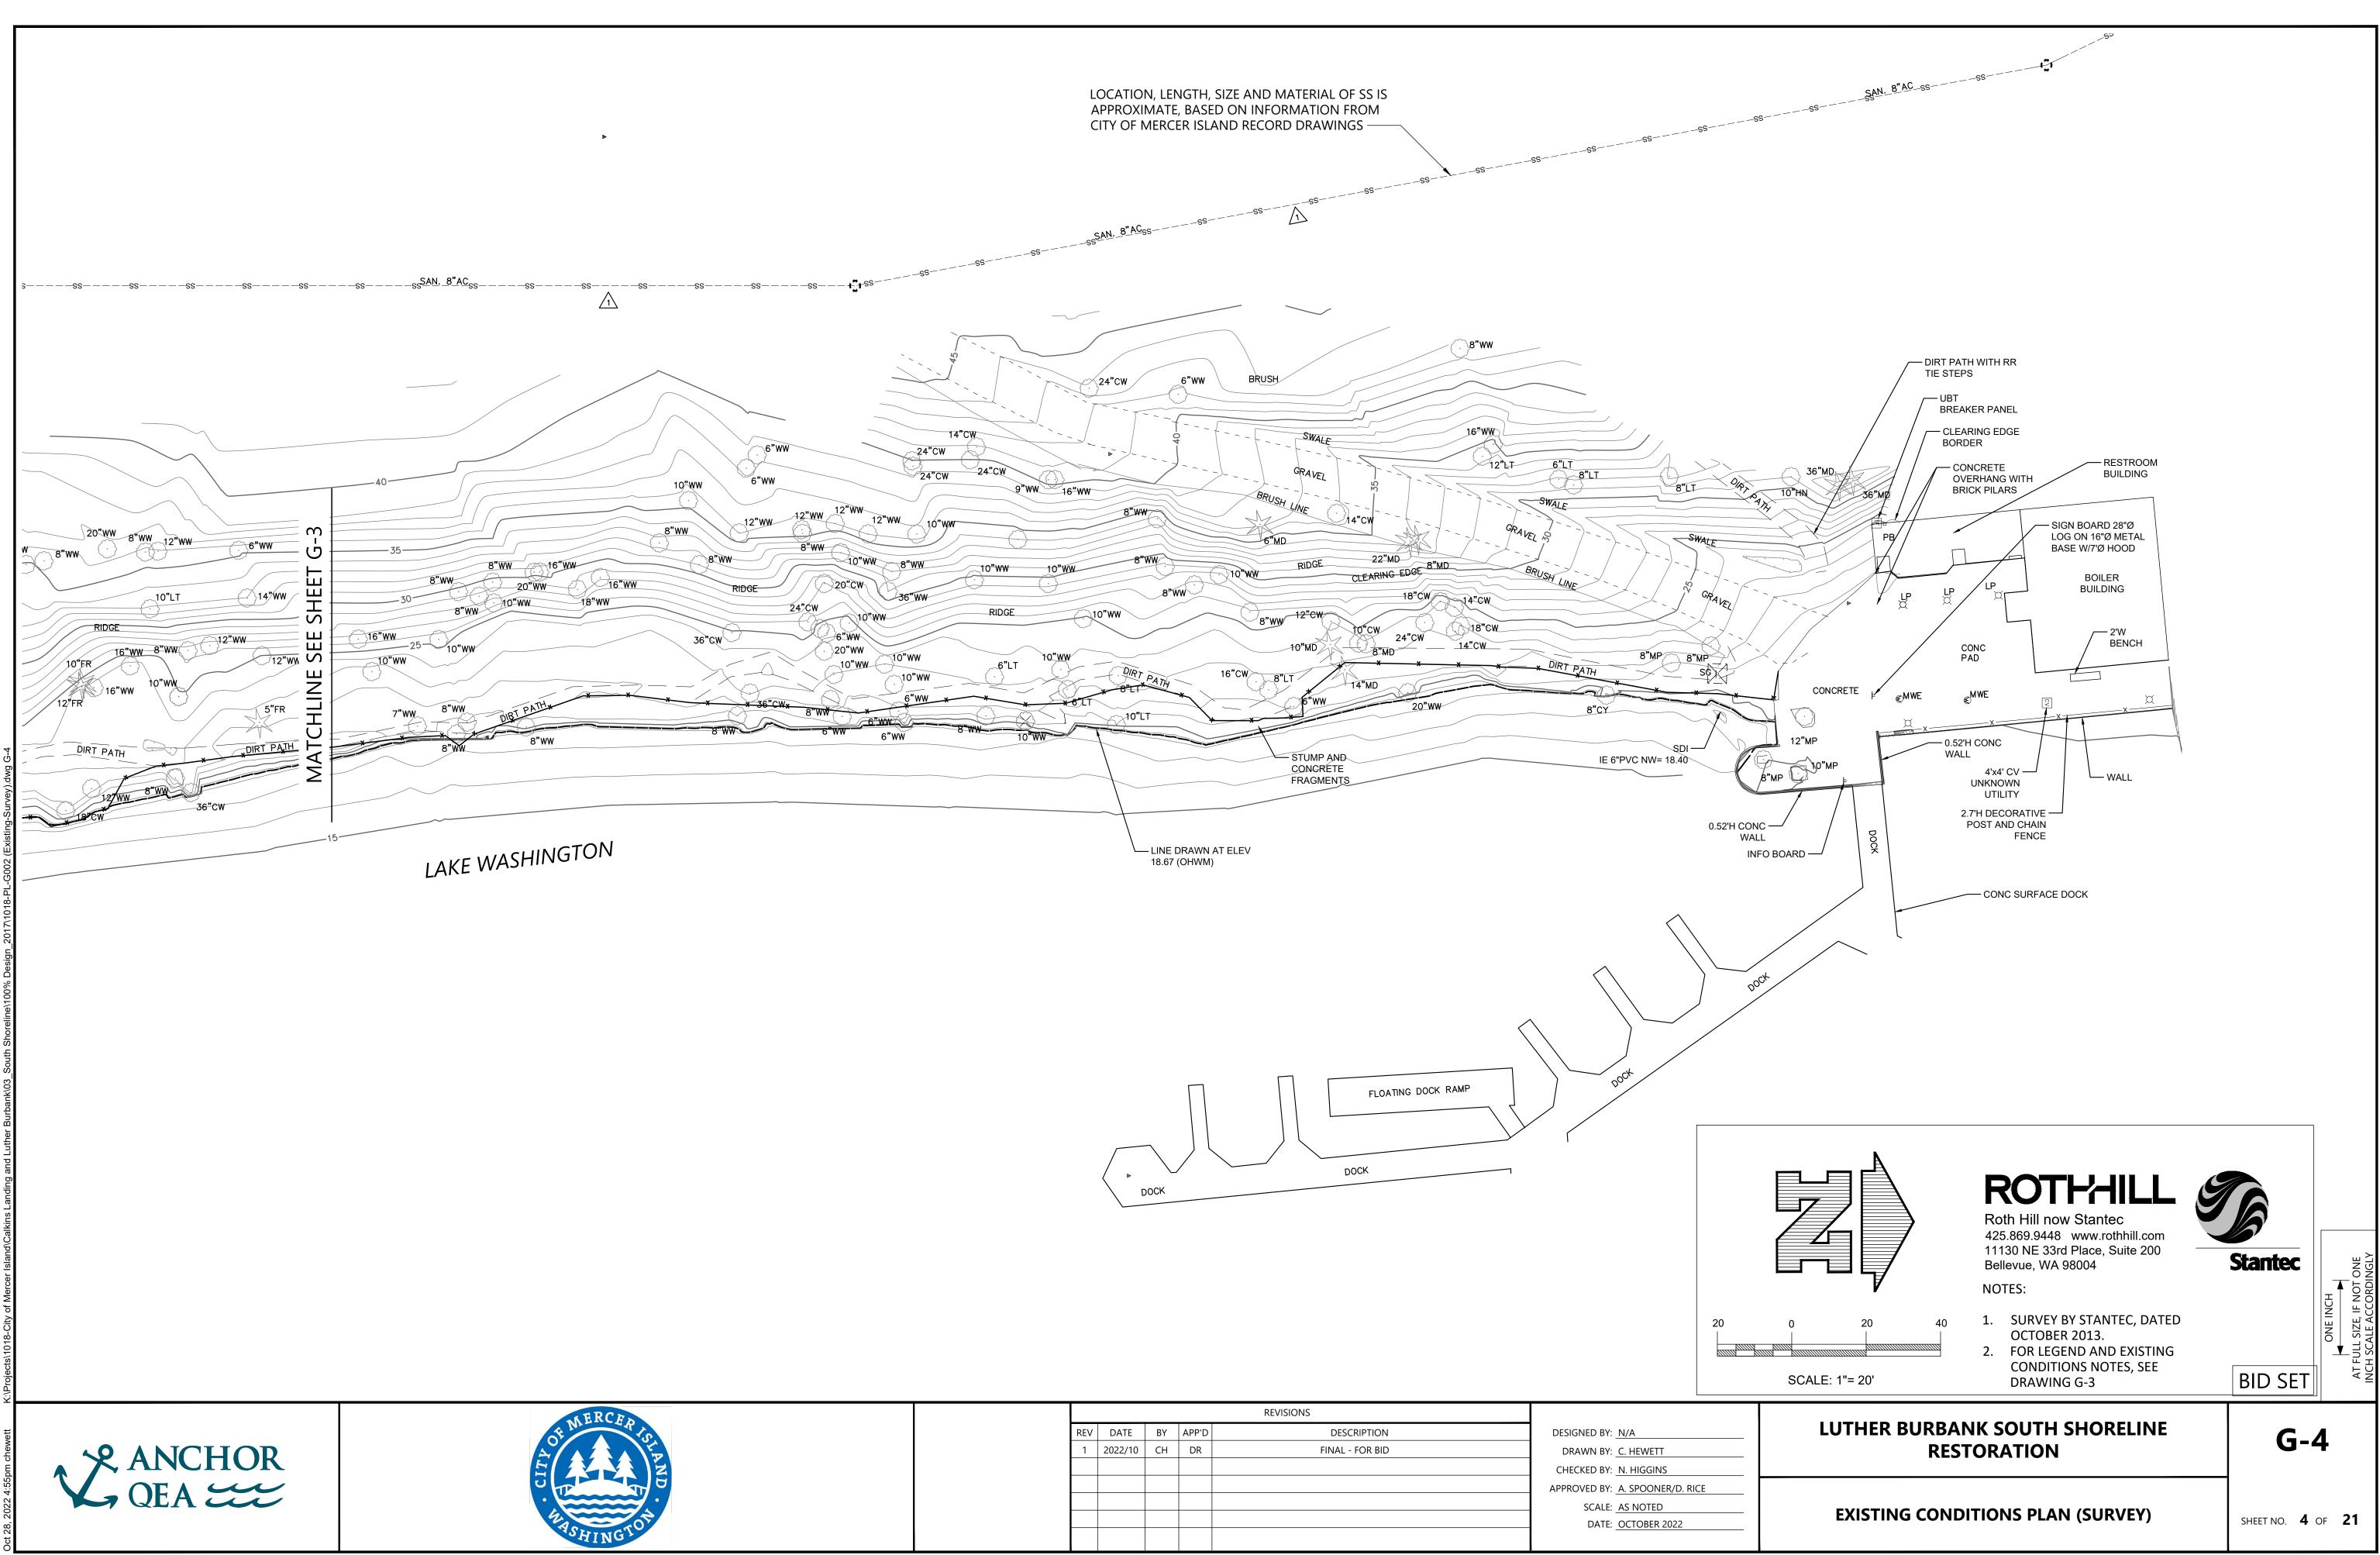




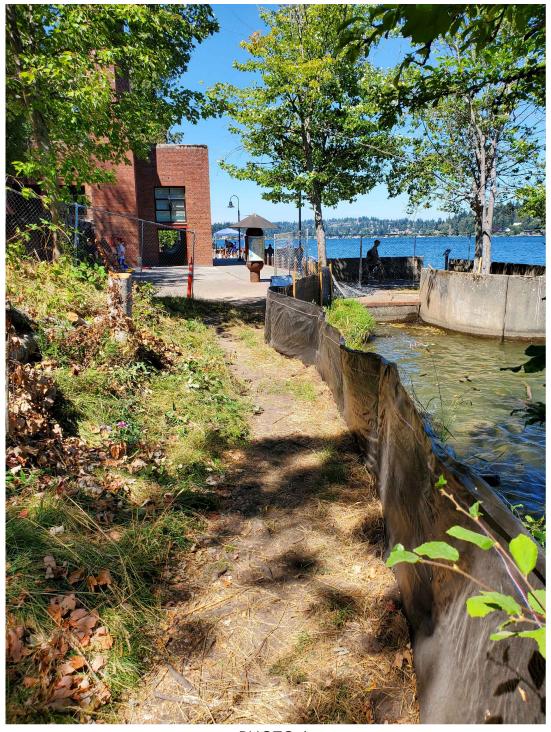




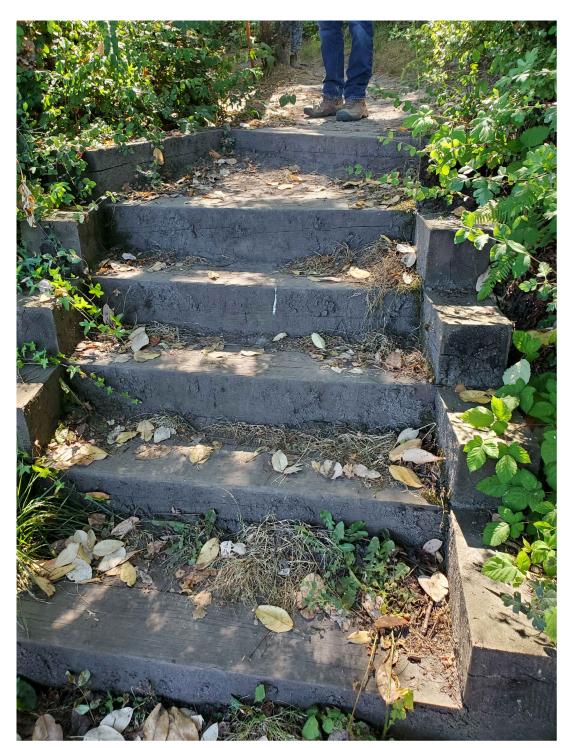
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REV	/ DATE	BY	APP'D	DESCRIPTION	DESIGNED BY: <u>N/A</u>
1	2022/10	СН	DR	FINAL - FOR BID	DRAWN BY: <u>C. HEWETT</u>
					CHECKED BY: N. HIGGINS
					APPROVED BY: <u>A. SPOONER/D. RICE</u>
					SCALE: AS NOTED
					DATE: OCTOBER 2022



<u>PHOTO 1:</u> CURRENT SILT FENCING NOTE: CHAIN LINK CONSTRUCTION FENCING HAS BEEN REMOVED SINCE THIS PHOTOGRAPH WAS TAKEN



<u>PHOTO 4:</u> EXISTING TIMBER STEPS







PHOTO 2: EXISTING SILT FENCING AT EXISTING TRAIL

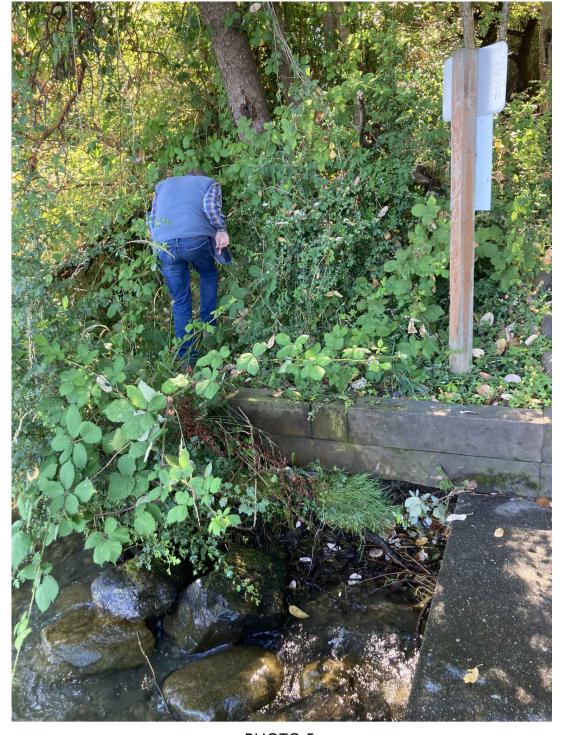
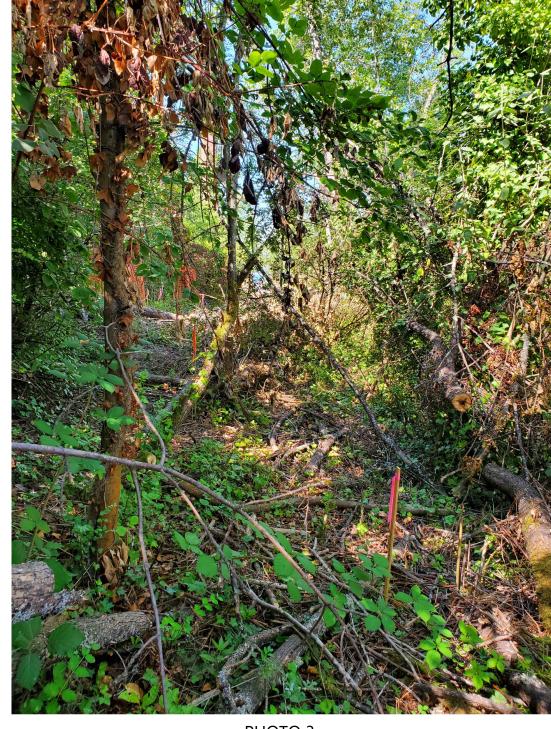


PHOTO 5: TIMBER STEPS VIEW SOUTH

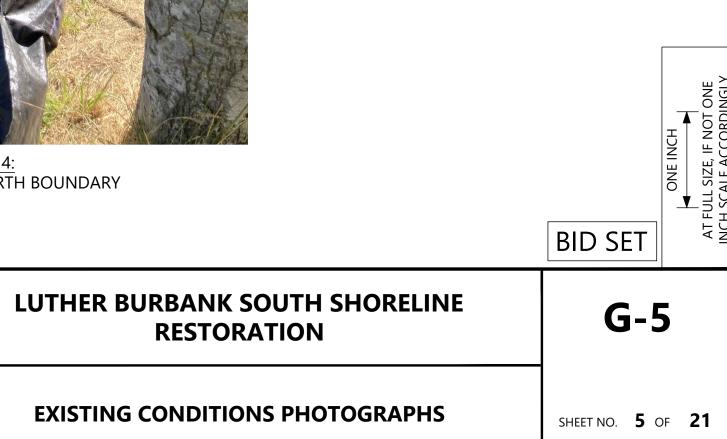


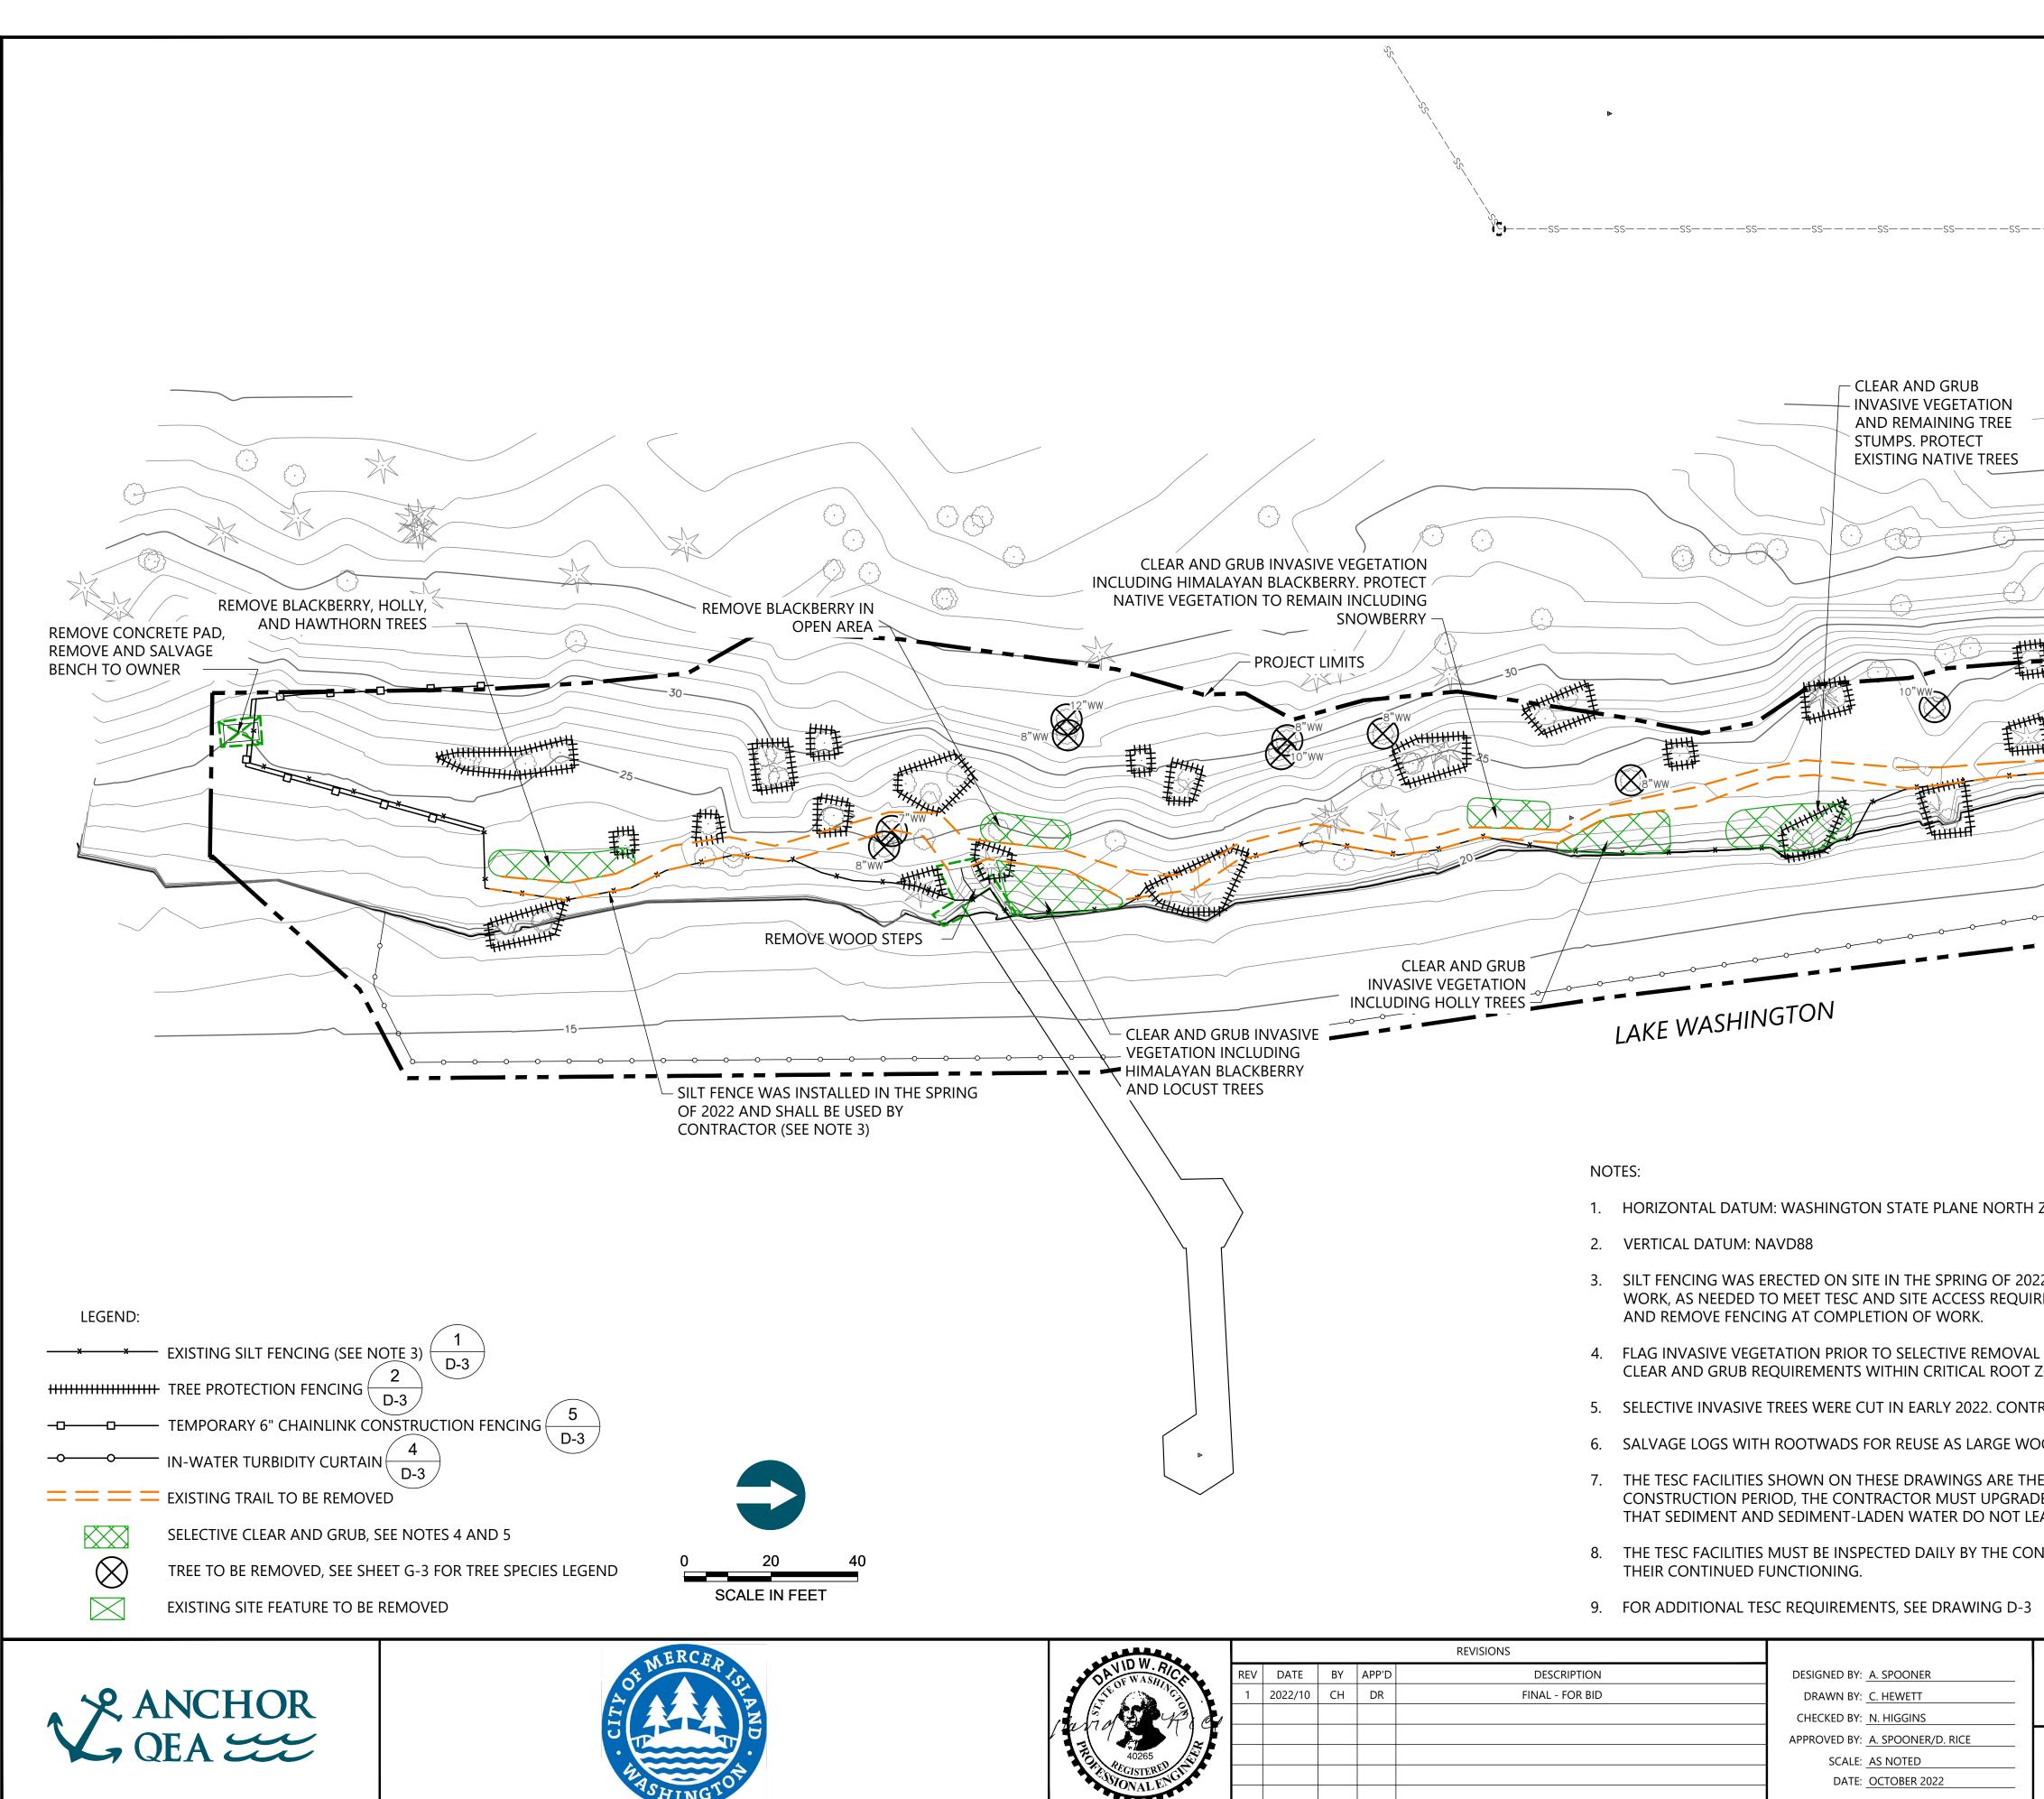


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	1	2022/10	СН	DR	FINAL - FOR BID	DRAWN BY:	C. HEWETT
						CHECKED BY:	N. HIGGINS
						APPROVED BY:	A. SPOONER/D. RICE
						SCALE:	AS NOTED
						DATE:	OCTOBER 2022

PHOTO 3: EXISTING INVASIVE VEGETATION

<u>PHOTO 4:</u> SILT FENCING AT NORTH BOUNDARY

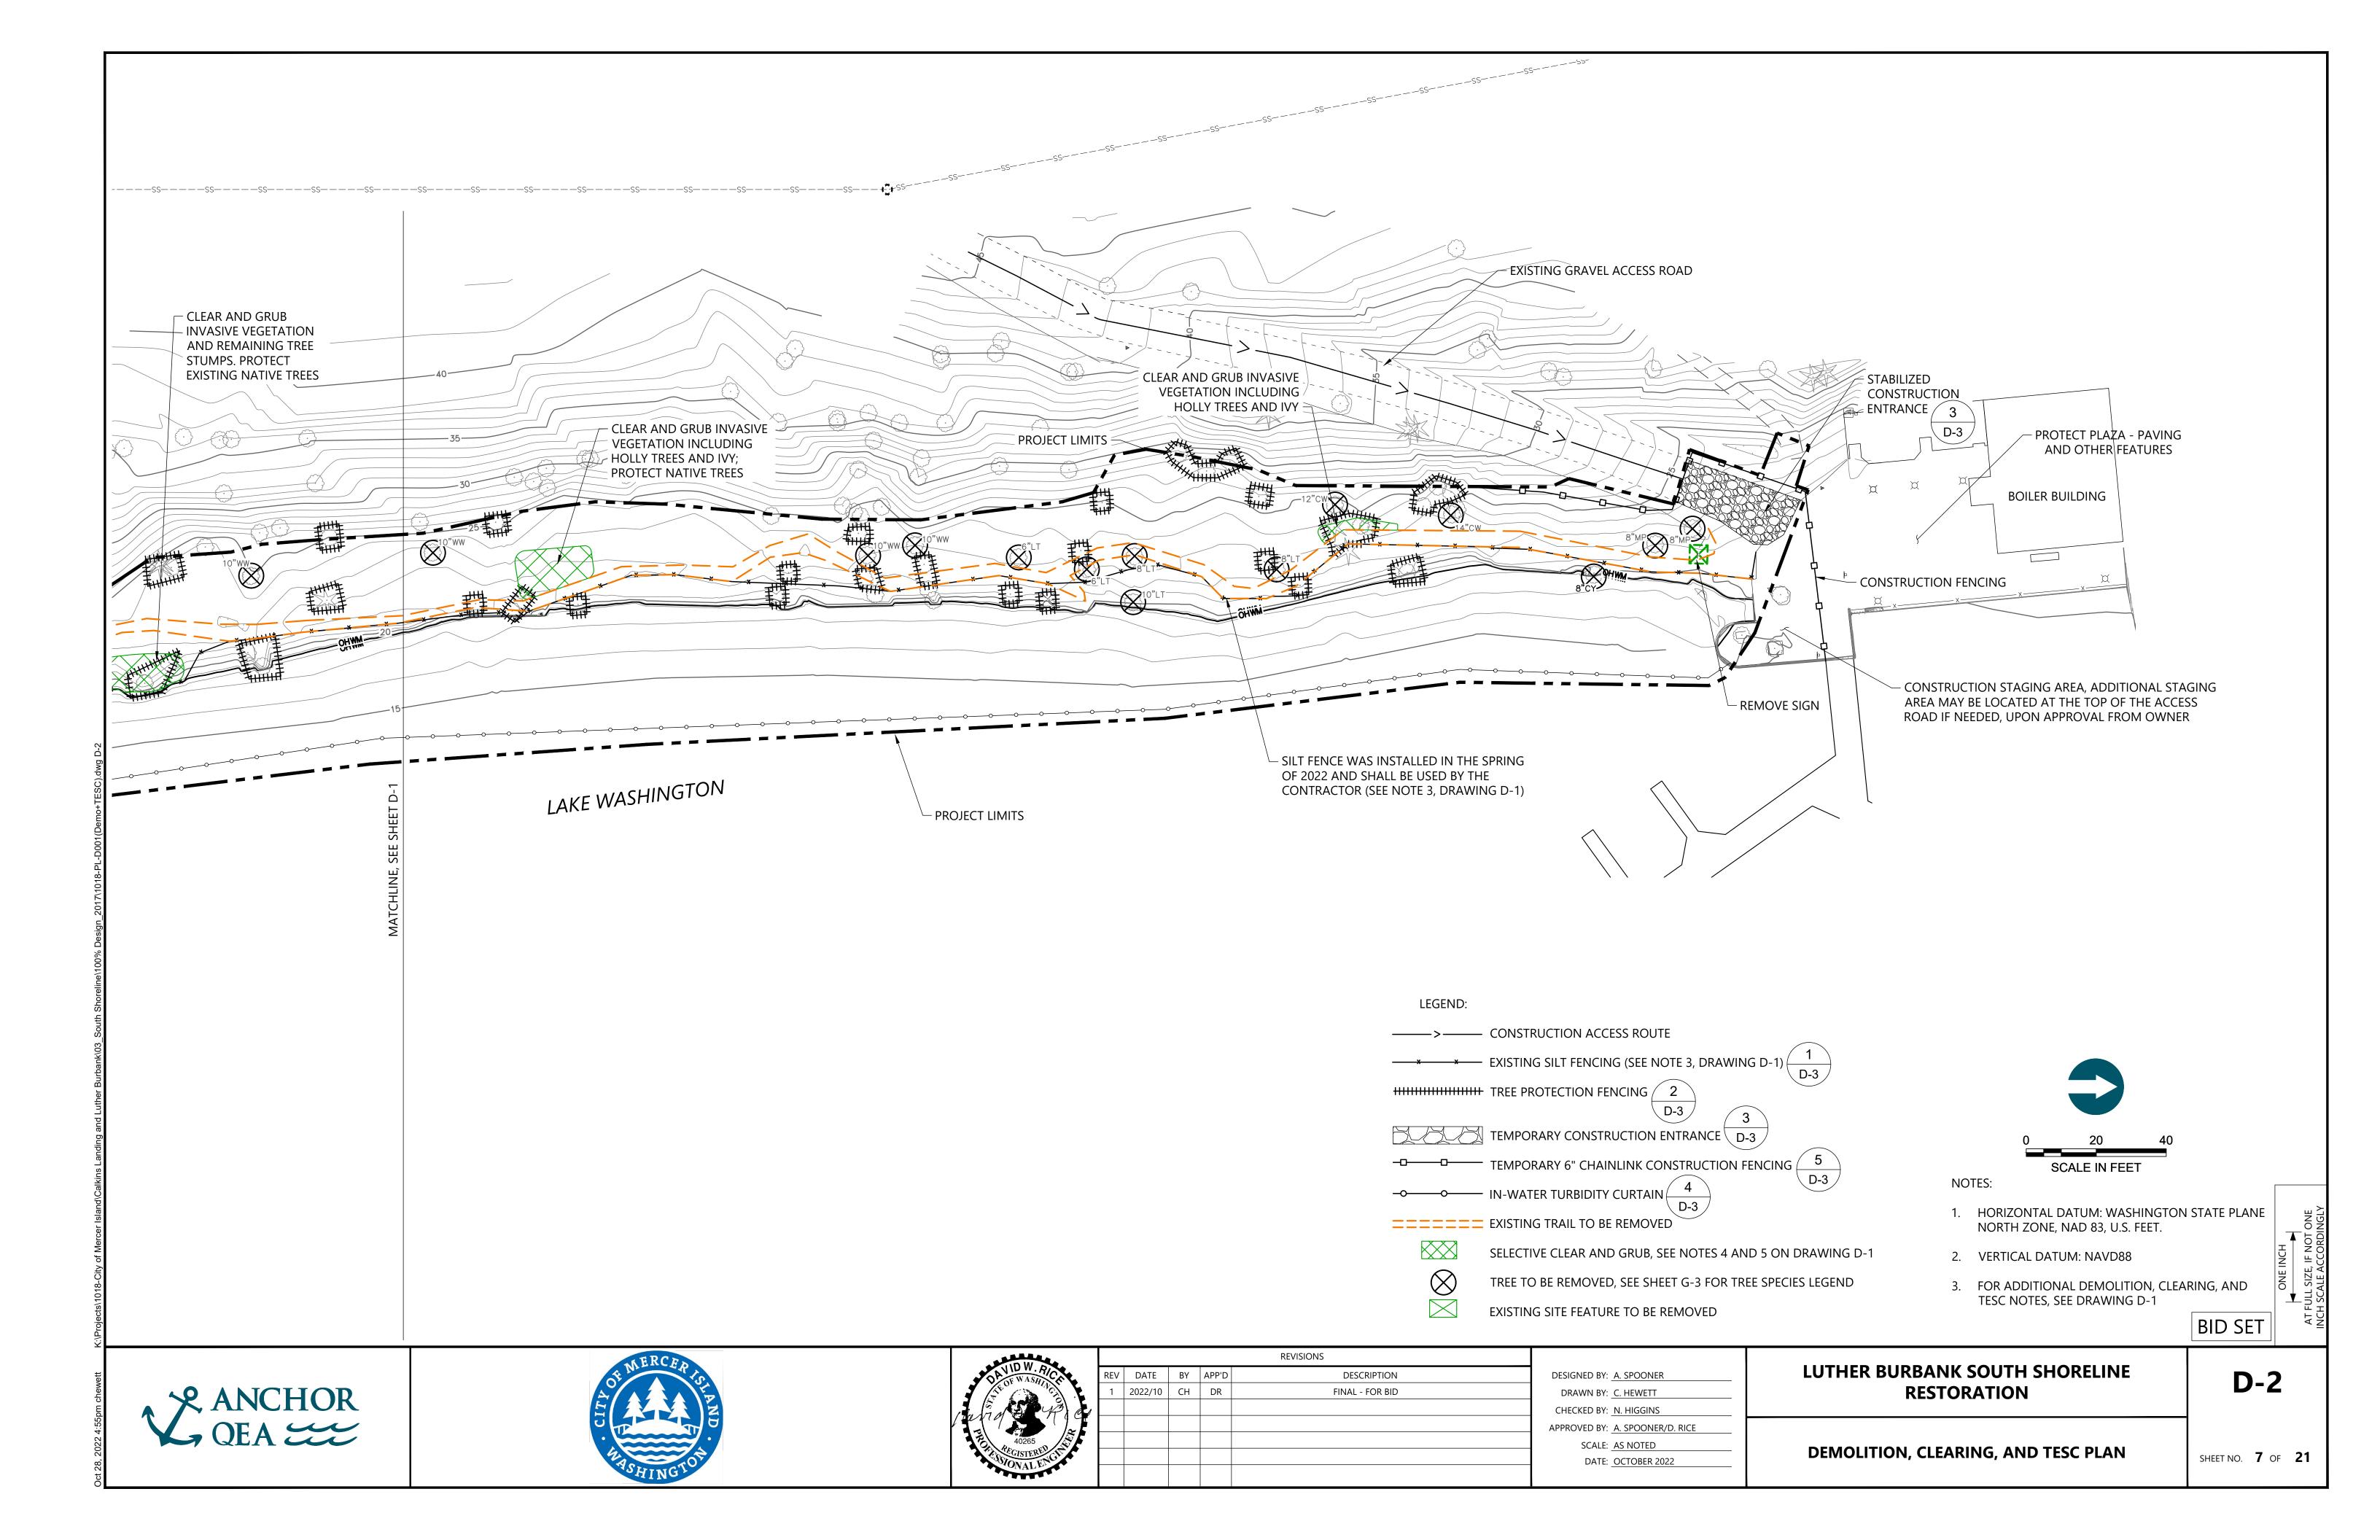




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			CHECKED BY: <u>N. HIGGINS</u>	
			APPROVED BY: <u>A. SPOONER/D. RICE</u>	
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CLEAR AND GRUB INVASIVE VEGETATION INCLUDING HOLLY TREES AND IVY;			
30 PROTECT NATIVE TREES			
			10"ww.(
SEE SHEET			
MATT MATT			
ZONE, NAD 83, U.S. FEET.			
2. CONTRACTOR SHALL AUGMENT OR ADJUST SILT FENCING PRIOR TO COMM REMENTS. THE CONTRACTOR SHALL ALSO MAINTAIN FENCING DURING CONST		ΙE	
. FOR OWNER APPROVAL. REFER TO DETAIL 2, DRAWING D-3 AND SPECIFICATIO	ONS FOR		
RACTOR SHALL CLEAR AND GRUB REMAINING TREE STUMPS			
OODY DEBRIS E MINIMUM REQUIREMENTS FOR ANTICIPATED SITE CONDITIONS. DURING THE	E		NE IGLY
E THESE TESC FACILITIES AS NEEDED FOR UNEXPECTED STORM EVENTS AND TO AVE THE SITE.		ONE INCH	ZE, IF NOT ONE
NTRACTOR-AND MAINTAINED, REPAIRED, OR AUGMENTED AS NECESSARY-TO I			A AT FULL SIZE INCH SCALE /
	BID SE	T	₹Z
LUTHER BURBANK SOUTH SHORELINE RESTORATION	D	-1	
DEMOLITION, CLEARING, AND TESC PLAN	SHEET NO.	6 OF	21



GENERAL TESC NOTES:

- THE TESC FACILITIES SHOWN ON THESE DRAWINGS MUST BE CONSTRUCTED IN CONJUNCTION WITH ALL CLEARING AND GRADING ACTIVITIES, AND IN SUCH A MANNER AS TO ENSURE THAT SEDIMENT AND SEDIMENT-LADEN WATER DO NOT ENTER THE DRAINAGE SYSTEM OR LAKE WASHINGTON.
 THE TESC FACILITIES SHOWN ON THESE DRAWINGS ARE THE MINIMUM REQUIREMENTS FOR ANTICIPATED SITE CONDITIONS. DURING THE
- 2. THE TESC FACILITIES SHOWN ON THESE DRAWINGS ARE THE MINIMUM REQUIREMENTS FOR ANTICIPATED SITE CONDITIONS. DORING THE CONSTRUCTION PERIOD, THESE TESC FACILITIES SHALL BE UPGRADED AS NEEDED FOR UNEXPECTED STORM EVENTS AND TO ENSURE THAT SEDIMENT AND SEDIMENT-LADEN WATER DO NOT ENTER THE DRAINAGE SYSTEM OR LAKE WASHINGTON.
- THE TESC FACILITIES SHALL BE INSPECTED DAILY BY THE CONTRACTOR AND MAINTAINED, REPAIRED, OR AUGMENTED AS NECESSARY--TO ENSURE THEIR CONTINUED FUNCTIONING.
 STORM DRAIN INLETS OPERABLE DURING CONSTRUCTION SHALL BE PROTECTED SO THAT STORMWATER PUNCEE DOES NOT ENTER THE
- 4. STORM DRAIN INLETS OPERABLE DURING CONSTRUCTION SHALL BE PROTECTED SO THAT STORMWATER RUNOFF DOES NOT ENTER THE CONVEYANCE SYSTEM WITHOUT FIRST BEING FILTERED OR TREATED TO REMOVE SEDIMENT. ALL CATCH BASINS AND CONVEYANCE LINES SHALL BE CLEANED AFTER CONSTRUCTION, PRIOR TO PROJECT COMPLETION AND ACCEPTANCE. THE CLEANING OPERATION SHALL NOT FLUSH SEDIMENT-LADEN WATER OFFSITE WITHOUT TREATMENT.
- 5. STABILIZED CONSTRUCTION ENTRANCES SHALL BE INSTALLED AT THE BEGINNING OF CONSTRUCTION AND MAINTAINED FOR THE DURATION OF THE PROJECT.
- 6. FROM OCTOBER 1 THROUGH APRIL 30, NO SOILS SHALL REMAIN EXPOSED AND UNWORKED FOR MORE THAN 2 DAYS. FROM MAY 1 TO SEPTEMBER 30, NO SOILS SHALL REMAIN EXPOSED AND UNWORKED FOR MORE THAN 7 DAYS. SOILS SHALL BE STABILIZED AT THE END OF THE SHIFT BEFORE A HOLIDAY OR WEEKEND IF NEEDED BASED ON THE WEATHER FORECAST. THESE STABILIZATION REQUIREMENTS APPLY TO ALL SOILS ON SITE, WHETHER AT FINAL GRADE OR NOT. THE CITY OF MERCER ISLAND MAY ADJUST THESE TIME LIMITS.
- SOIL AND OTHER STOCKPILES MUST BE STABILIZED AND PROTECTED WITH SEDIMENT-TRAPPING MEASURES.
 ALL POLLUTANTS, INCLUDING WASTE MATERIALS AND DEMOLITION DEBRIS, THAT OCCUR ON SITE DURING CONSTRUCTION SHALL BE HANDLED AND DISPOSED OF IN A MANNER THAT DOES NOT CAUSE CONTAMINATION OF STORMWATER.
- 9. MAINTENANCE AND REPAIR OF HEAVY EQUIPMENT AND VEHICLES AND OTHER ACTIVITIES WHICH MAY RESULT IN DISCHARGE OR SPILLAGE OF POLLUTANTS TO THE GROUND OR INTO STORMWATER RUNOFF MUST BE CONDUCTED USING SPILL PREVENTION MEASURES APPROVED BY THE CONTRACTING OFFICER OR HIS/HER REPRESENTATIVE. REPORT ALL SPILLS TO 911.
- 10. HIGHLY TURBID OR CONTAMINATED DEWATERING WATER SHALL BE HANDLED SEPARATELY FROM STORMWATER AND PROPERLY DISPOSED.

PROJECT SPECIFIC TESC NOTES:

- 1. THE TESC PLAN DRAWINGS SHOWN ARE CONCEPTUAL. THE CONTRACTOR IS REQUIRED TO SUBMIT DETAILED TESC PLANS AND A CONSTRUCTION STORMWATER POLLUTION PREVENTION PLAN (SWPPP) FOR APPROVAL, AS REQUIRED BY THE SPECIFICATIONS.
- WORK TO BE UNDERTAKEN BELOW THE ELEVATION OF THE ORDINARY HIGH WATER LINE SHALL COMPLY WITH APPLICABLE PERMIT REQUIREMENTS.
- 3. THE CONTRACTOR IS RESPONSIBLE FOR THE CARE AND DIVERSION OF WATER DURING CONSTRUCTION IN ACCORDANCE WITH LOCAL, STATE, AND FEDERAL WATER QUALITY STANDARDS AND PROJECT PERMIT REQUIREMENTS.

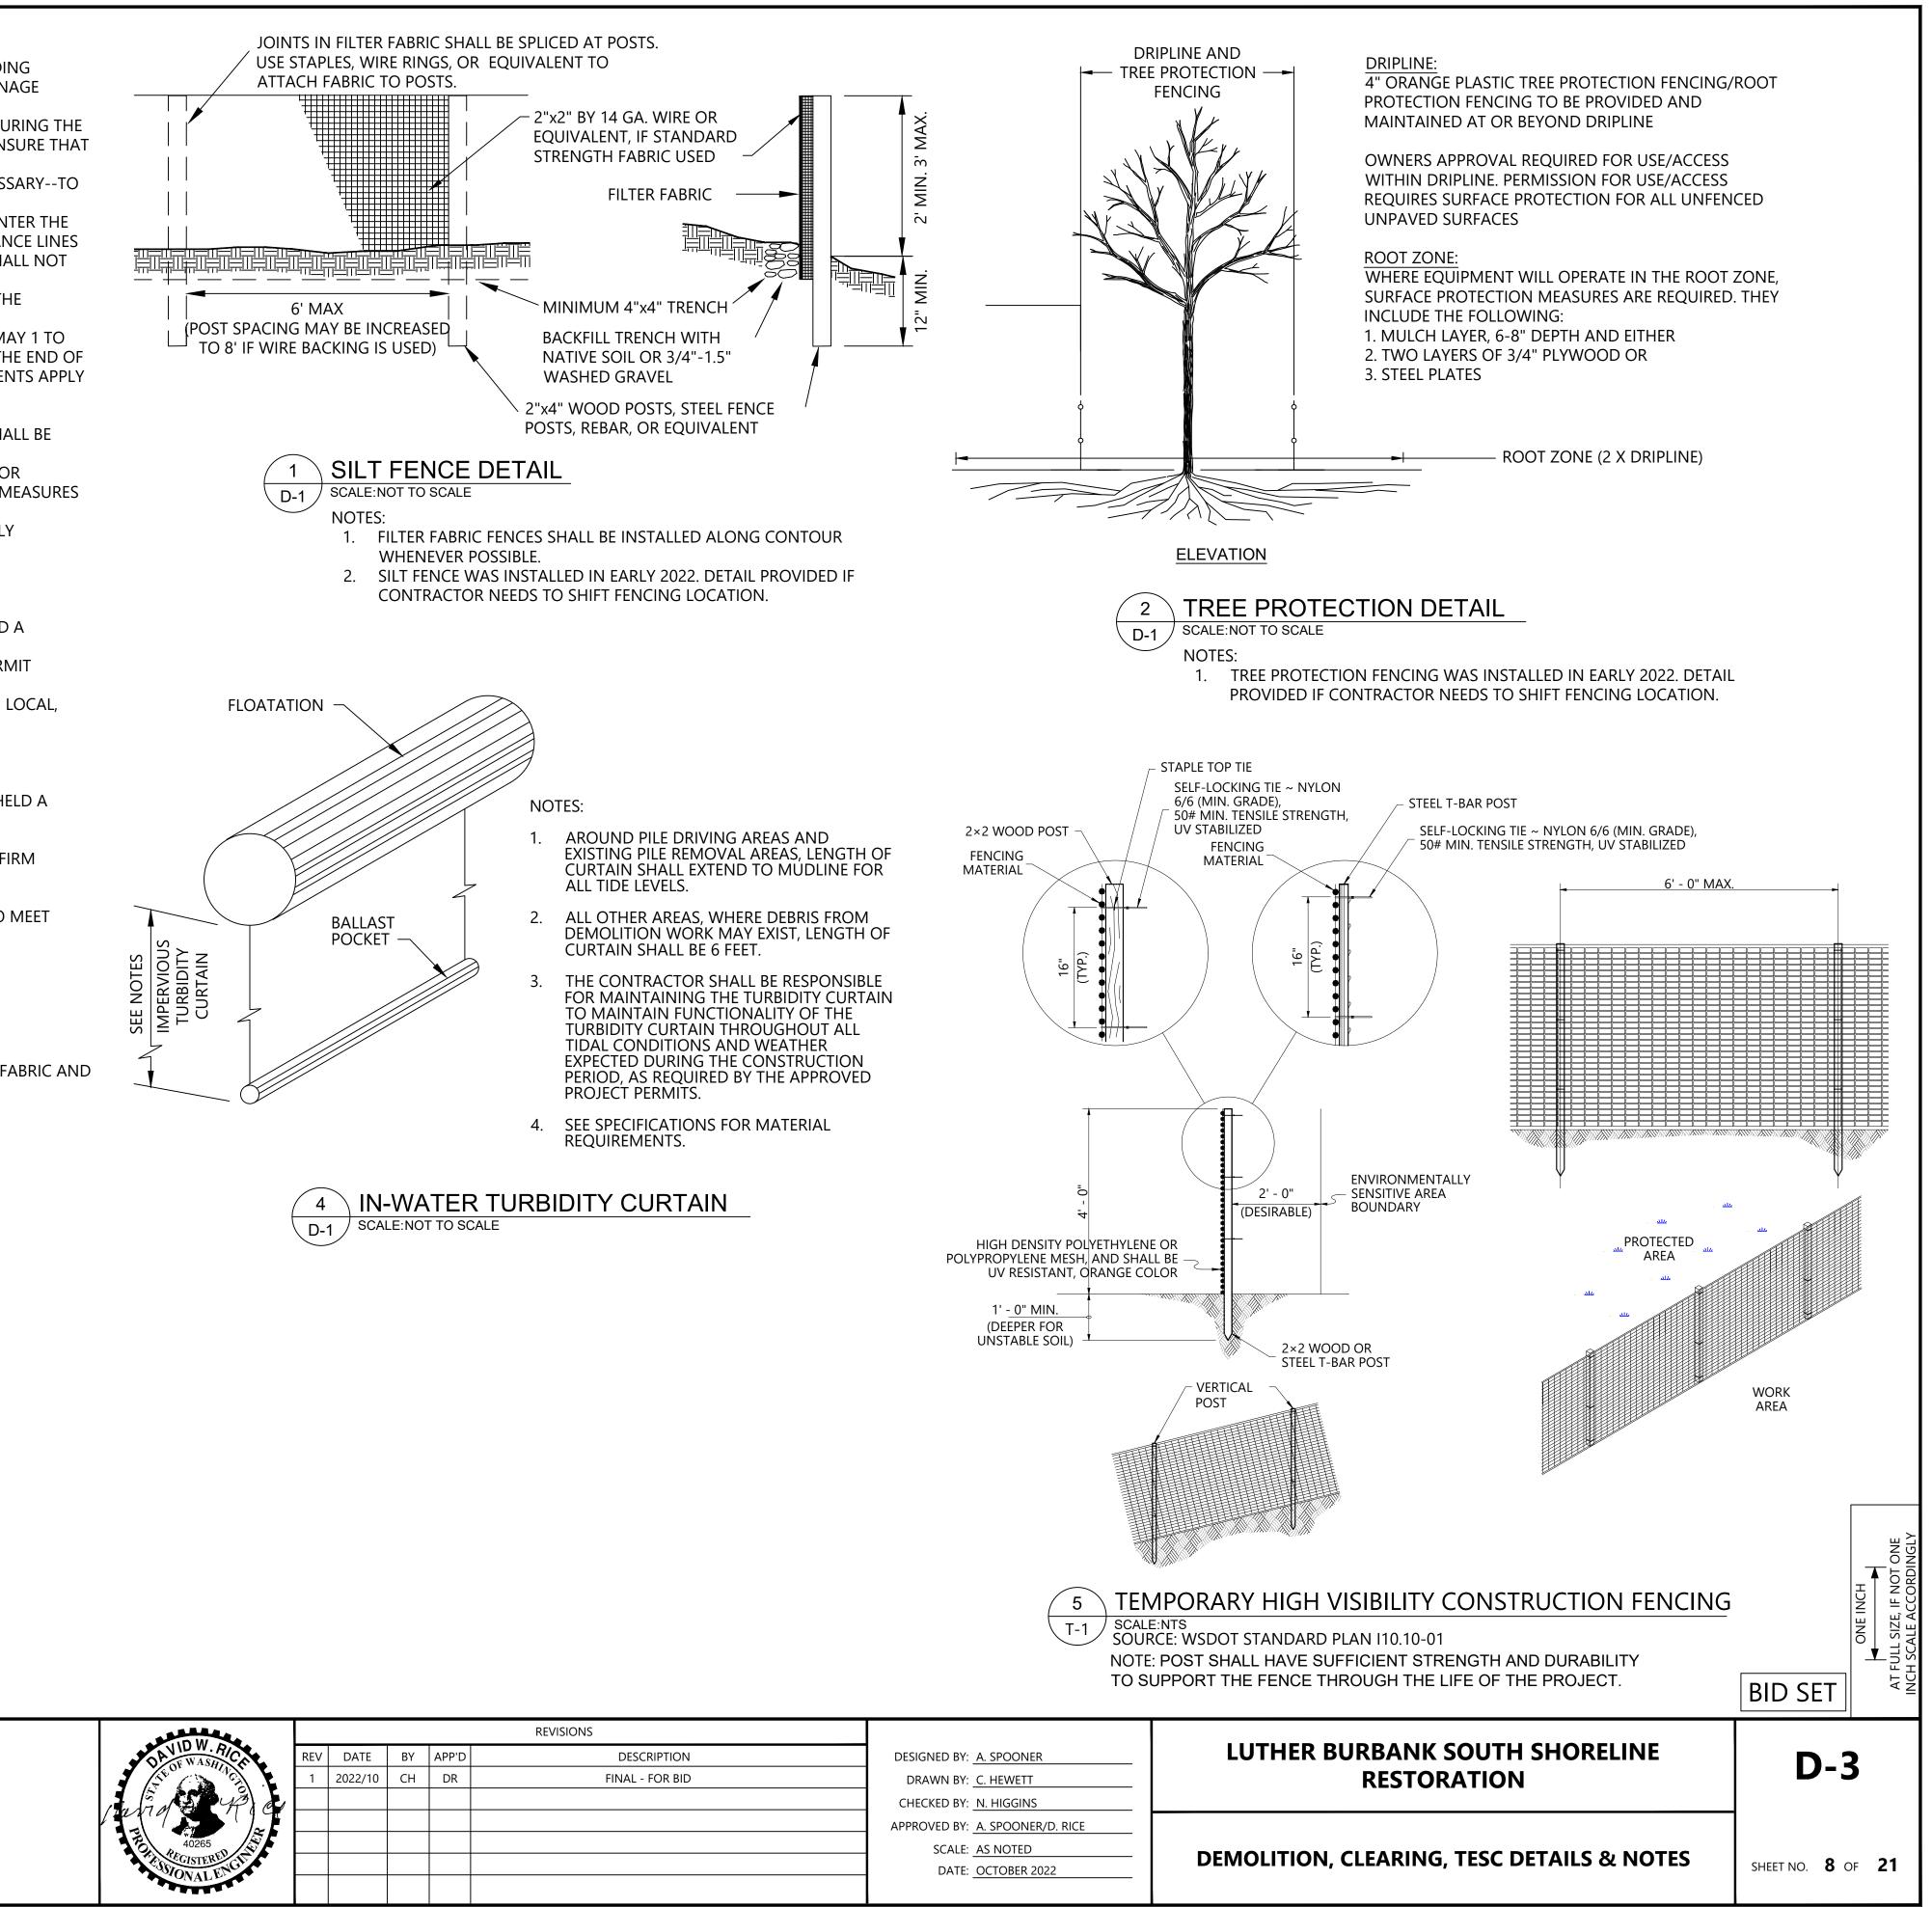
CONSTRUCTION SEQUENCE:

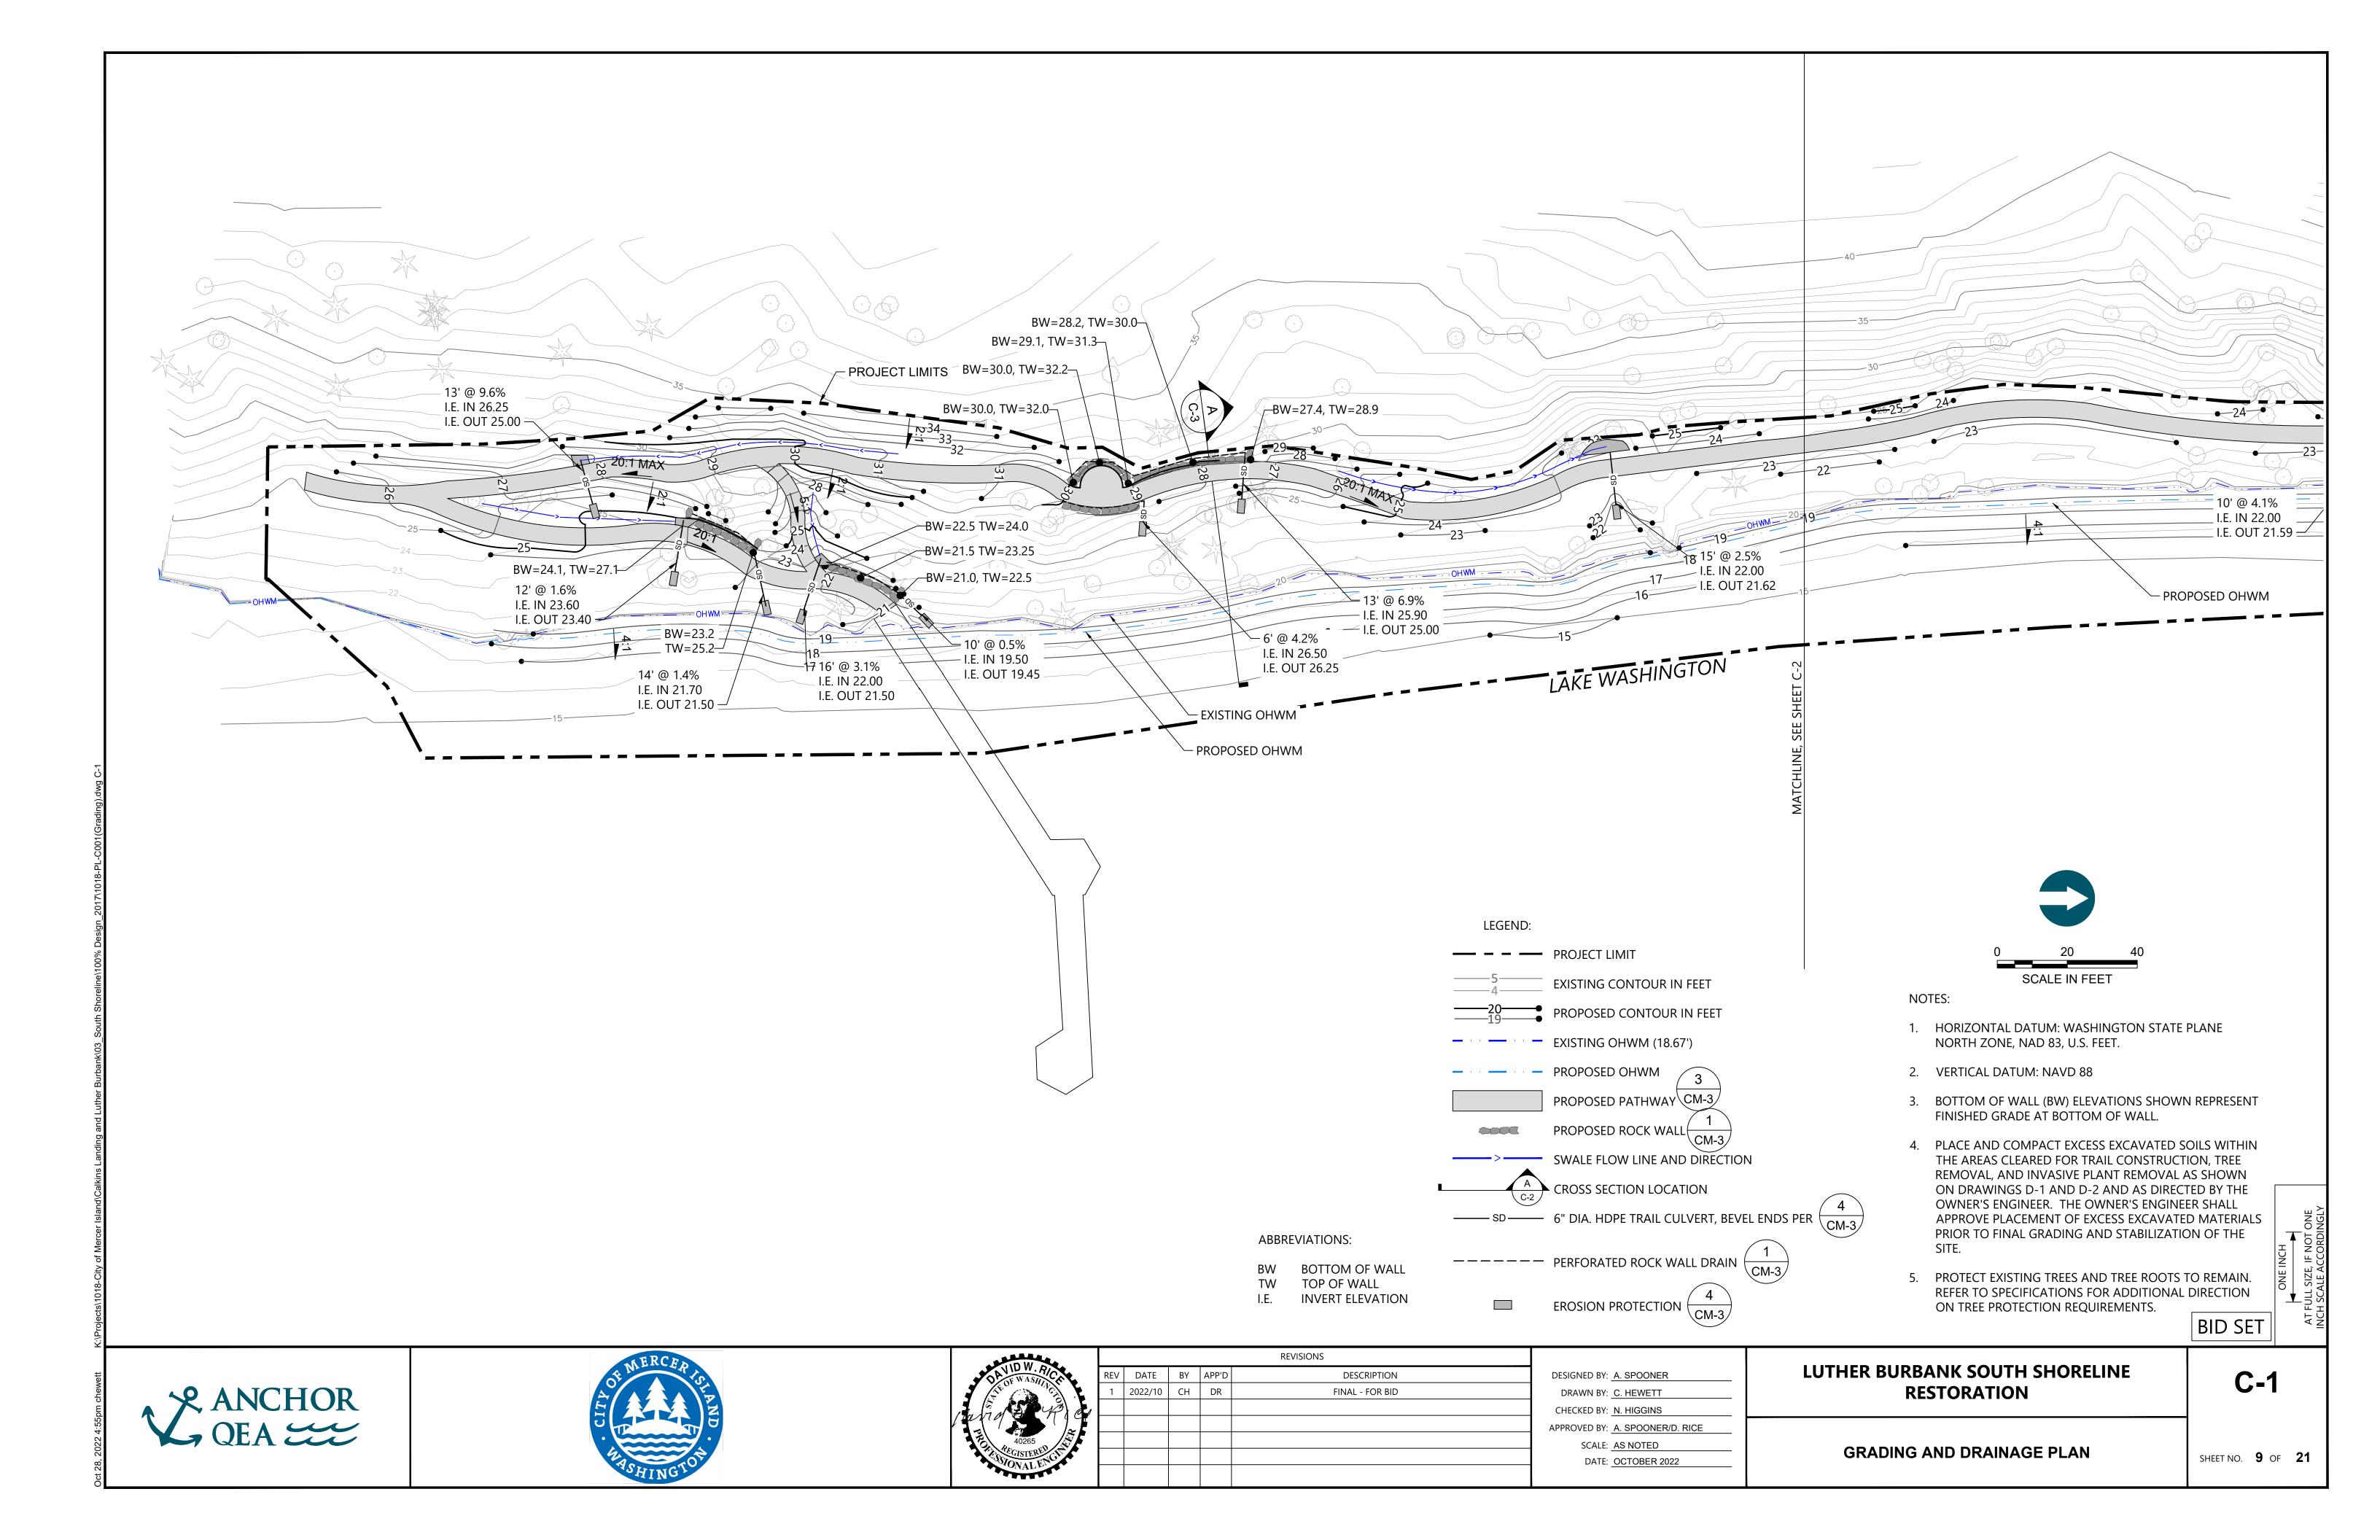
- SCHEDULE AND CONDUCT A PRE-CONSTRUCTION CONFERENCE WITH THE CITY OF MERCER ISLAND. THIS MEETING SHALL BE HELD A MINIMUM OF 48 HOURS PRIOR TO THE START OF WORK.
- 2. INSTALL CONSTRUCTION FENCING.
- 3. FLAG CLEARING LIMITS AND EXISTING TREES AND OTHER NATIVE VEGETATION TO REMAIN. CALL OWNER TO REVIEW AND CONFIRM EXISTING TREES ARE FLAGGED CORRECTLY BEFORE ANY DEMO WORK BEGINS.
- 4. CONSTRUCT STABILIZED CONSTRUCTION ENTRANCE.
- INSPECT AND ADJUST SILT FENCING INSTALLED BY THE OWNER IN THE SPRING OF 2022. IF NEEDED, AUGMENT SILT FENCING TO MEET TESC REQUIREMENTS.
- 6. INSTALL TREE PROTECTION FENCING
- 7. COMPLETE CLEARING, GRADING, AND REMOVAL OF SURFACE FEATURES.
- 8. PERFORM GRADING AND INSTALLATION OF NEW SURFACE FEATURES.
- 9. AMEND EXISTING SOIL
- 10. INSTALL IRRIGATION CONNECTION
- DURING CONSTRUCTION, MAINTAIN AND UPGRADE TESC BMPS AS NEEDED TO PREVENT SEDIMENT FROM LEAVING THE SITE.
 AFTER CONSTRUCTION IS COMPLETE, COORDINATE WITH THE OWNER, THE OWNER WILL STABILIZE EXPOSED SOILS WITH JUTE FABRIC AND MULCHING, PLANTING WILL ALSO BE PERFORMED BY THE OWNER.
- 13. COORDINATE PROJECT HAND OFF WITH THE OWNER. REMOVE TESC BMPS AS DIRECTED BY THE OWNER.
- 14. SEQUENCE SHALL BE ADAPTED, AS NEEDED, FOR OPTIONAL ITEMS INCLUDED DURING CONSTRUCTION.

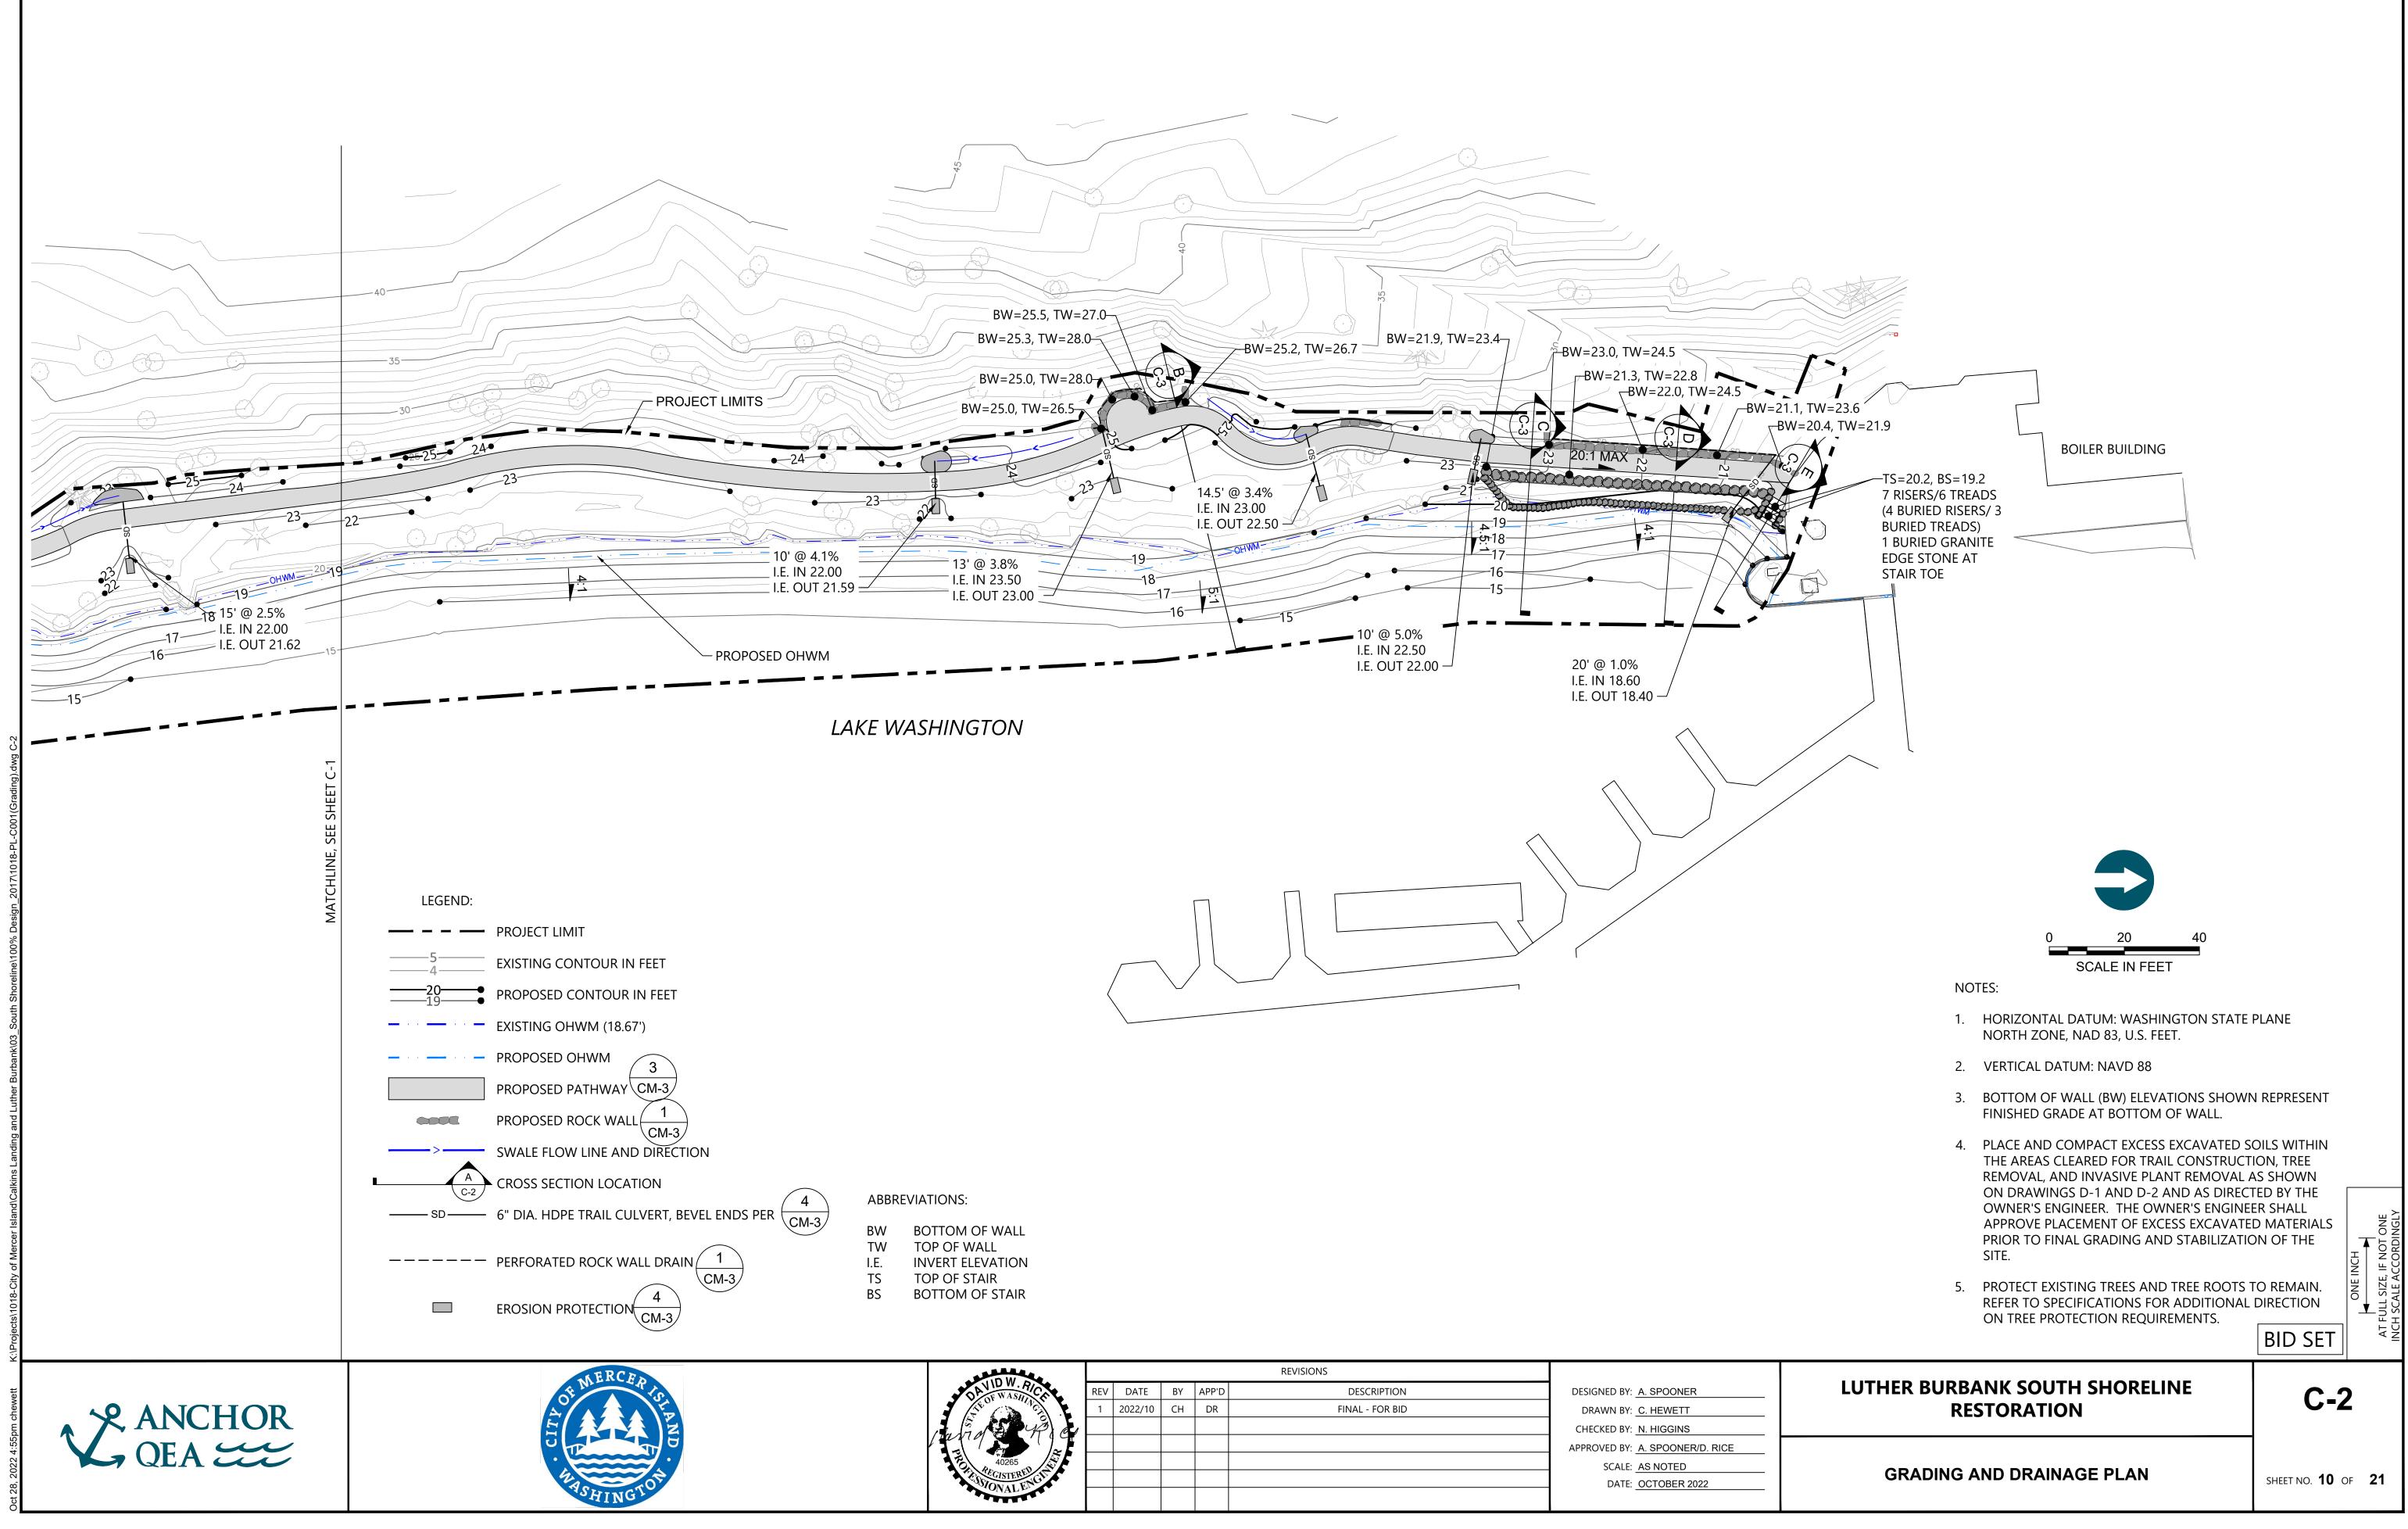


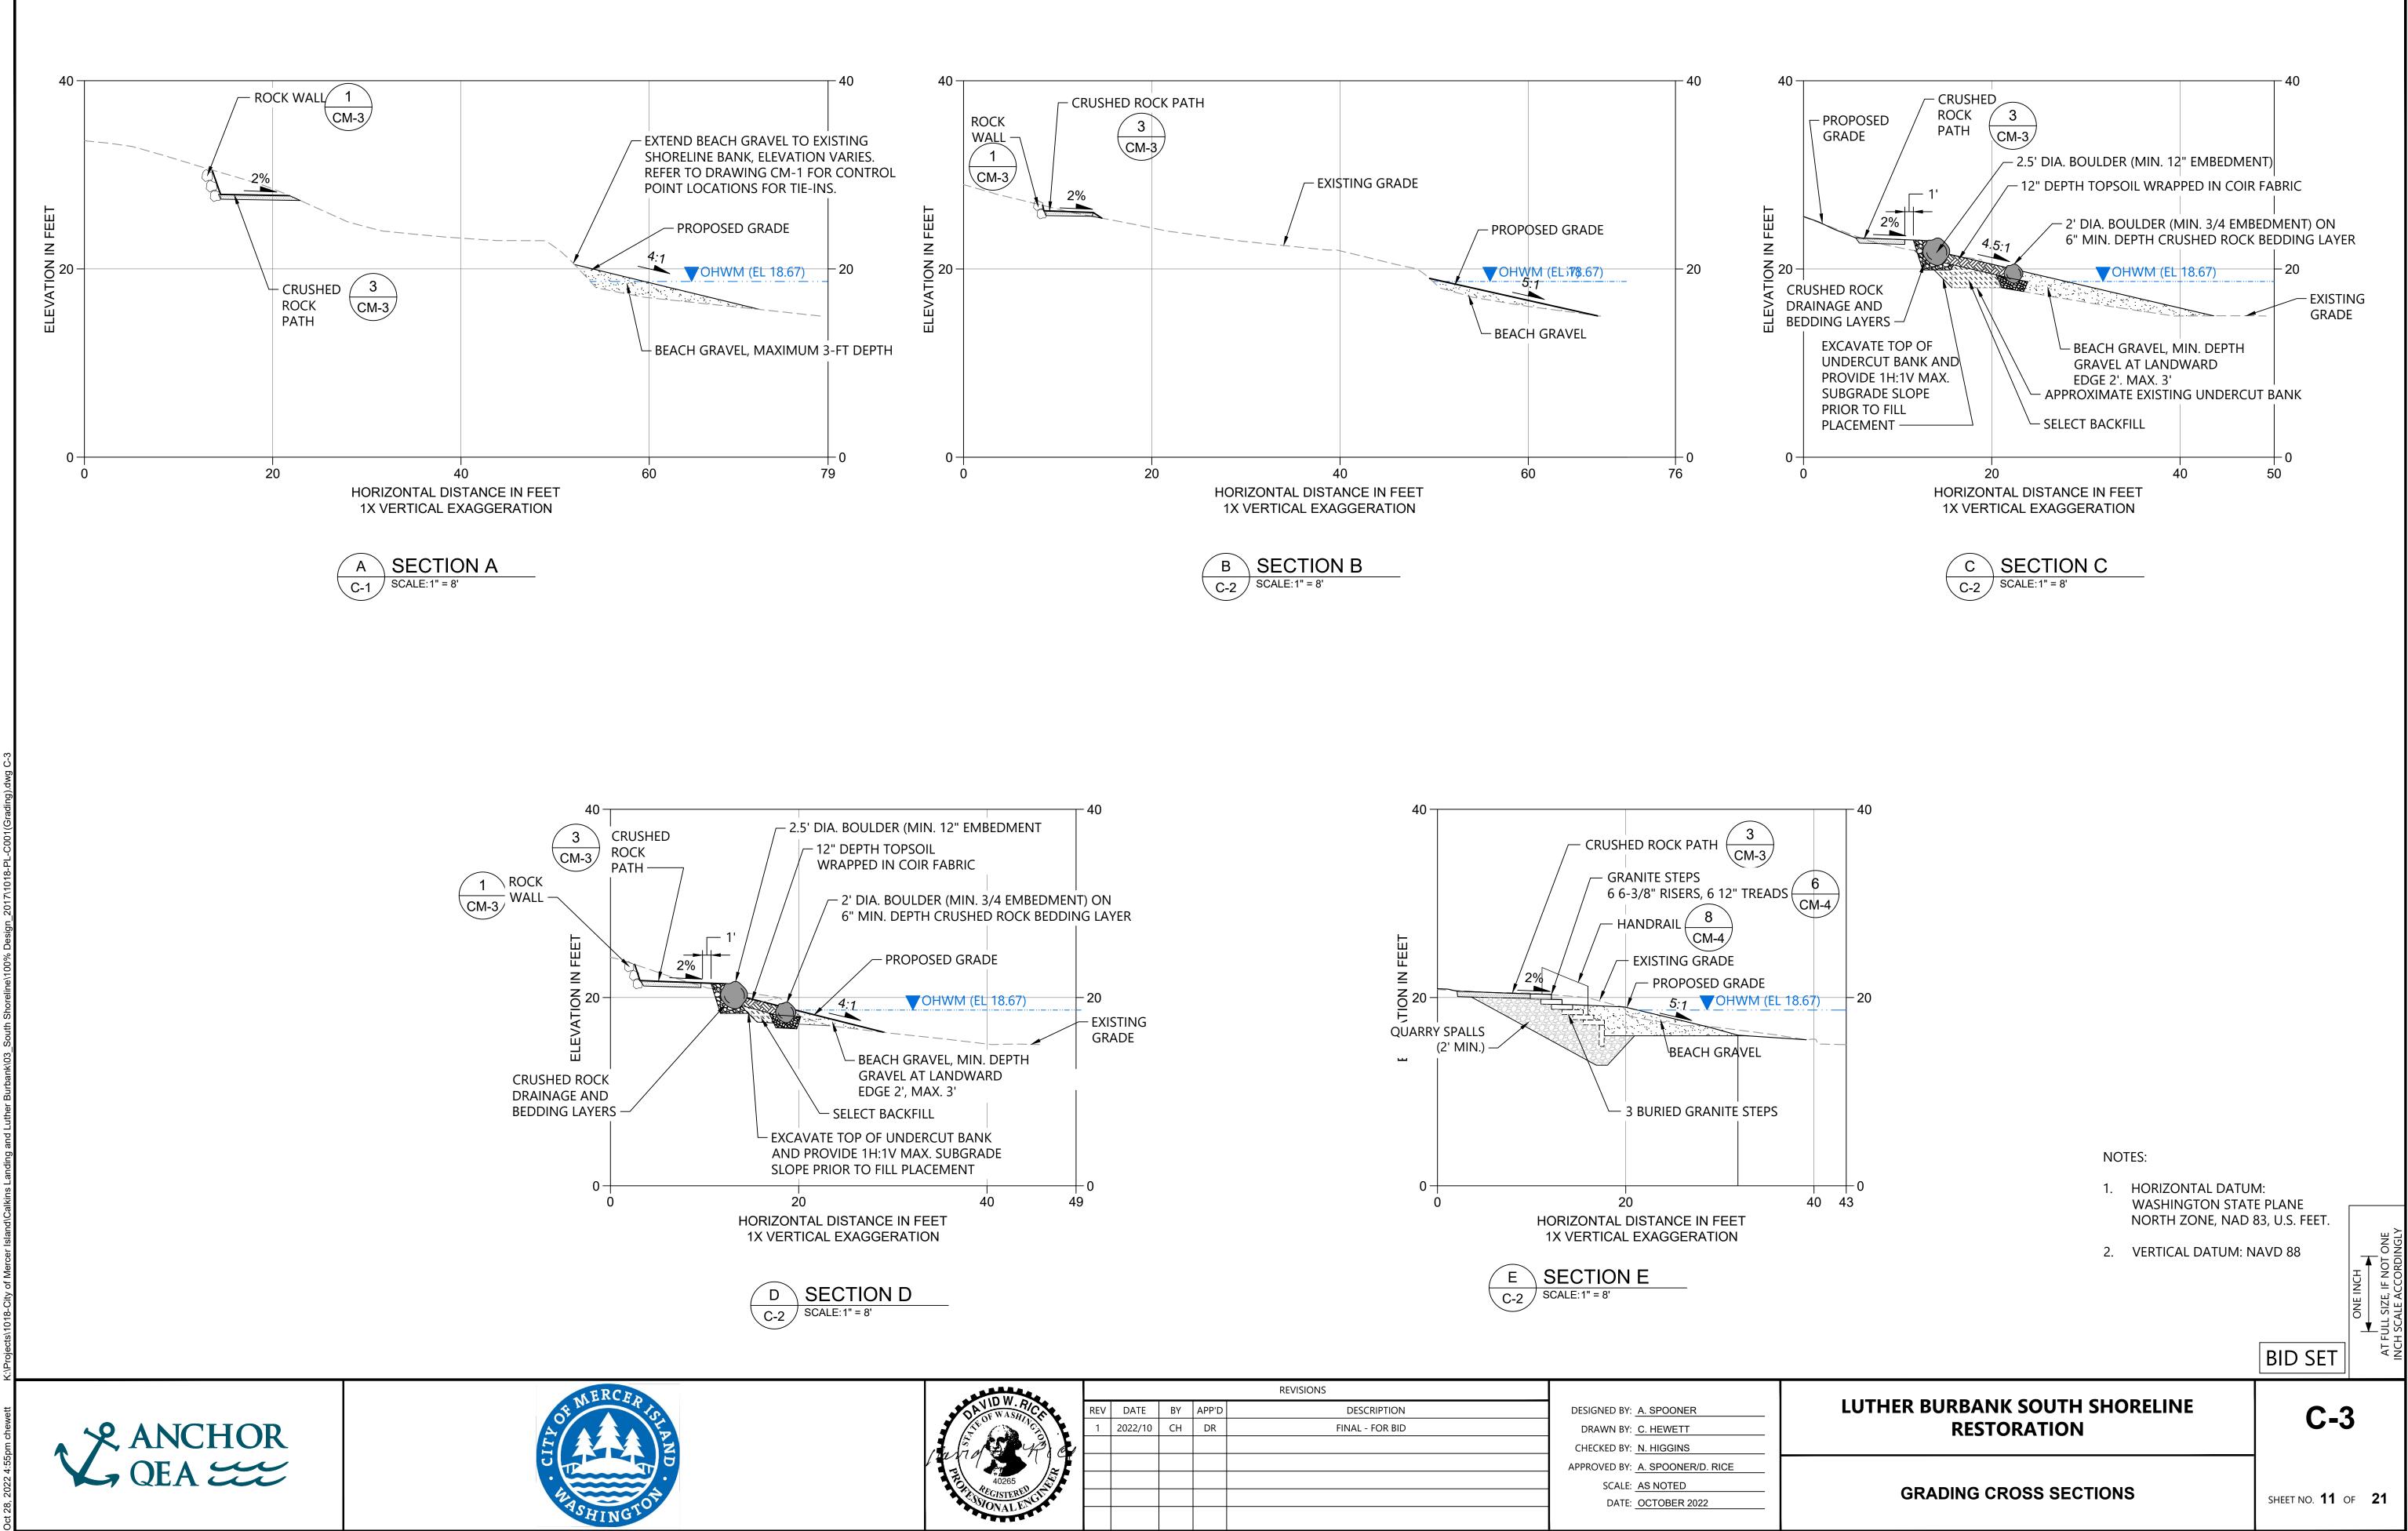


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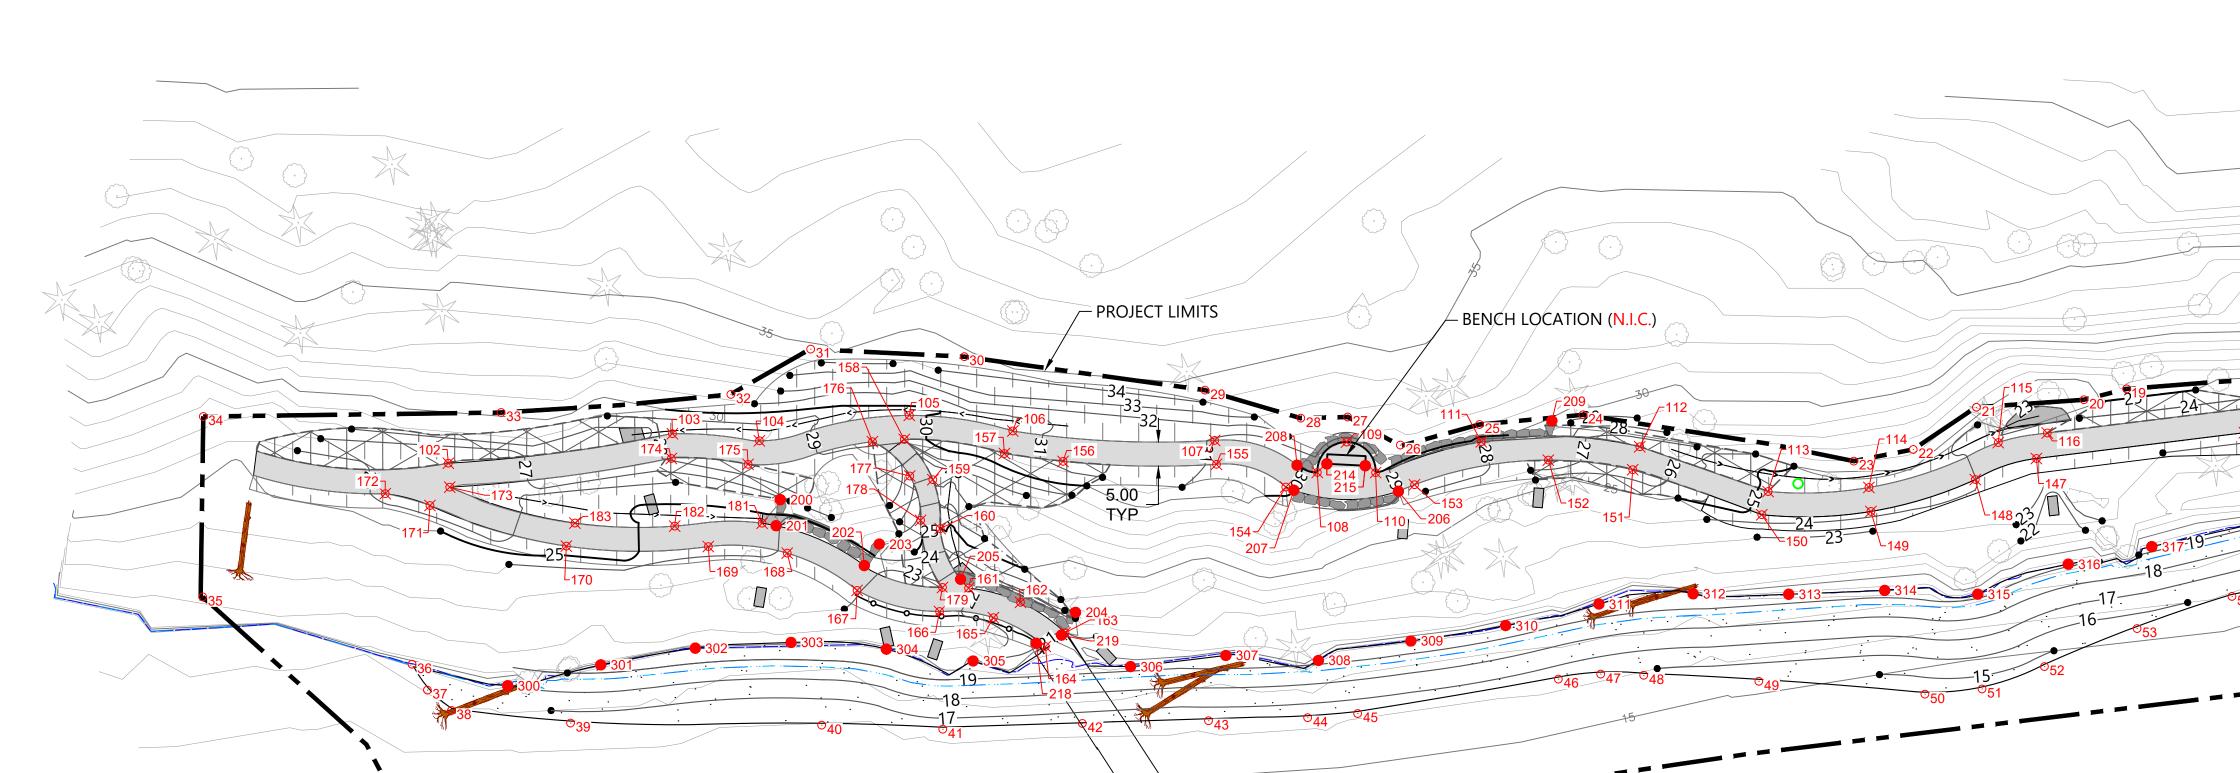








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4	AL CONTRACT	1	2022/10	СН	DR	FINAL - FOR BID	DRAWN BY: <u>C. HEWETT</u>	
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	ONTROL POIN PROJECT LIMI			ONTROL POIN PROJECT LIMI			ONTROL POIN PROJECT LIMI		CON	CONTROL POINTS - PA		
POINT #		EASTING	POINT #		EASTING	POINT #	NORTHING			NORTHING	EASTIN	
			_						100	218569.0	129716	
1	218573.7	1297131.1	30	217898.7	1297156.1	59	218353.2	1297197.4	101	218567.6	129716	
2	218568.9	1297143.2	31	217866.6	1297154.6	60	218392.4	1297202.3	102	217791.2	129717	
3	218548.7	1297135.8	32	217850.0	1297164.0	61	218420.6	1297203.0	103	217837.8	129717	
4	218544.2	1297151.4	33	217802.2	1297167.8	62	218448.1	1297198.5	104	217856.0	129717	
5	218514.2	1297144.1	34	217740.1	1297168.6	63	218456.8	1297193.4	105	217887.2	129716	
6	218503.8	1297148.9	35	217740.0	1297206.2	64	218497.8	1297193.7	106	217908.8	129717	
7	218452.0	1297146.0	36	217783.6	1297220.2	65	218514.5	1297191.3	107	217950.8	129717	
8	218436.2	1297146.1	37	217786.8	1297225.6	66	218528.7	1297185.9	108	217972.2	129718	
9	218425.4	1297141.6	38	217791.8	1297229.9	67	218536.2	1297185.5	109	217978.3	129717	
10	218407.3	1297138.0	39	217816.6	1297232.5	68	218551.9	1297187.4	110	217984.4	129718	
11	218394.2	1297135.8	40	217868.9	1297232.9	69	218556.2	1297193.0	111	218006.4	129717	
12	218384.4	1297137.4	41	217894.2	1297233.8	70	218558.8	1297187.2	112	218039.4	129717	
13	218378.4	1297148.1	42	217923.2	1297232.6	71	218561.5	1297185.6	113	218066.1	129718	
14	218328.9	1297155.9	43	217949.5	1297232.0	72	218567.7	1297185.3	114	218087.1	129718	
15	218301.4	1297155.7	44	217970.2	1297231.4	73	218567.2	1297179.6	114	218087.1	129717	
16	218257.6	1297151.6	45	217980.6	1297230.5	74	218568.7	1297179.3	115	218114.1	129717	
17	218236.0	1297150.7	46	218022.4	1297223.3	75	218582.8	1297134.8				
18	218187.4	1297159.6	47	218031.2	1297222.3		I		117	218176.8	129716	
19	218140.8	1297162.9	48	218040.2	1297222.5				118	218210.3	129716	
20	218131.9	1297165.1	49	218064.2	1297223.8				119	218239.8	129715	
21	218109.5	1297166.7	50	218098.8	1297226.5				120	218260.7	129715	
22	218096.4	1297175.5	51	218110.7	1297225.4				121	218302.6	129716	
23	218084.0	1297177.9	52	218123.7	1297220.7				122	218344.9	129716	
24	218027.5	1297168.3	53	218143.0	1297212.8				123	218386.2	129715	
25	218006.0	1297170.3	54	218162.7	1297206.1				124	218389.7	129714	
26	217989.5	1297174.6	55	218175.4	1297203.6				125	218397.6	129714	
27	217978.5	1297168.7	55	218207.6	1297198.3				126	218407.5	129714	
28	217978.3	1297169.0	57	218207.8	1297196.6				127	218418.8	129714	
28	217968.8	1297169.0	58	218271.8	1297196.6				128	218431.9	129715	







CON	TROL POINTS	- PATH		CONTROL POINTS - PATH					
POINT #	NORTHING	EASTING		POINT #	NORTHING	EASTING			
129	218442.6	1297151.6		159	217892.1	1297181.8			
130	218454.5	1297150.4		160	217893.6	1297192.0			
131	218485.6	1297154.6		161	217899.5	1297204.4			
132	218469.1	1297157.7		162	217910.4	1297207.3			
133	218453.7	1297155.3		163	217919.6	1297213.7			
134	218446.6	1297155.5		164	217915.5	1297216.5			
135	218440.2	1297158.6		165	217904.7	1297210.5			
136	218426.5	1297159.6		166	217893.5	1297209.2			
137	218415.0	1297152.0		167	217876.3	1297204.8			
139	218384.1	1297157.4		168	217861.8	1297197.1			
140	218365.1	1297163.9		169	217845.3	1297195.7			
141	218345.2	1297167.0		170	217815.7	1297195.6			
142	218302.4	1297166.9		171	217787.3	1297187.2			
143	218260.0	1297161.2		172	217778.0	1297184.7			
144	218235.6	1297160.5		173	217791.5	1297183.3			
145	218211.6	1297165.0		174	217837.6	1297177.4			
146	218165.4	1297172.0		175	217853.6	1297178.6			
147	218122.0	1297177.4		176	217879.5	1297173.9			
148	218109.3	1297181.8		177	217887.3	1297181.0			
149	218087.5	1297188.4		178	217889.6	1297190.2			
150	218064.8	1297189.1		179	217894.1	1297204.2			
151	218037.9	1297179.7		181	217856.5	1297190.8			
152	218020.3	1297177.7		182	217838.3	1297191.4			
153	217992.4	1297182.8	1	183	217817.5	1297190.8			
154	217965.6	1297183.3	1			·			
155	217951.2	1297178.6	1	LEGEND	(CONTROL	_):			
156	217919.2	1297178.0	1	0 ₁	CONT	ROL POINT			
157	217907.0	1297176.3	1	⊠ ₁₀	0 CONT	ROL POINT			
158	217886.1	1297173.4		• ₂₀		ROL POINT			

СС	NTROL POINT	'S - MISCELLA	NEOUS	
POINT #	NORTHING	EASTING	DESCRIPTION	
200	217860.3	1297185.9	WALL	
201	217859.5	1297191.3	WALL	
202	217877.8	1297199.7	WALL	
203	217880.9	1297195.2	WALL	
204	217921.8	1297209.4	WALL	
205	217897.9	1297202.5	WALL	
206	217989.1	1297184.2	WALL	
207	217967.3	1297184.0	WALL	
208	217968.0	1297178.8	WALL	
209	218021.1	1297169.5	WALL	
210	218382.7	1297152.5	WALL	
211	218407.0	1297139.3	WALL	
212	218448.1	1297149.7	WALL	

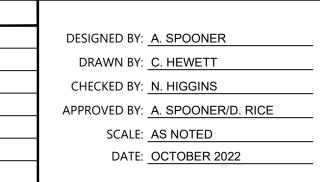
СС	NTROL POINT	S - MISCELLA	ANEOUS
POINT #	NORTHING	EASTING	DESCRIPTION
213	218458.4	1297150.1	WALL
214	217974.2	1297178.5	BENCH
215	217982.2	1297178.9	BENCH
216	218387.3	1297148.6	BENCH
217	218394.7	1297145.6	BENCH
218	217913.6	1297215.8	COBBLE
219	217918.9	1297214.2	COBBLE
222	218503.0	1297154.8	WALL
223	218563.2	1297158.8	WALL
224	218530.0	1297163.4	WALL
225	218485.8	1297162.6	WALL
226	218494.0	1297171.5	WALL
227	218502.1	1297171.8	WALL

LEGEND:	
	PROJECT LIMIT
5 4	EXISTING CONTOUR IN FEET
20 19_ 	PROPOSED CONTOUR IN FEET
<u> </u>	EXISTING OHWM (18.67')
	PROPOSED OHWM
	EROSION PROTECTION
C.	LARGE WOODY DEBRIS

CONTROL):

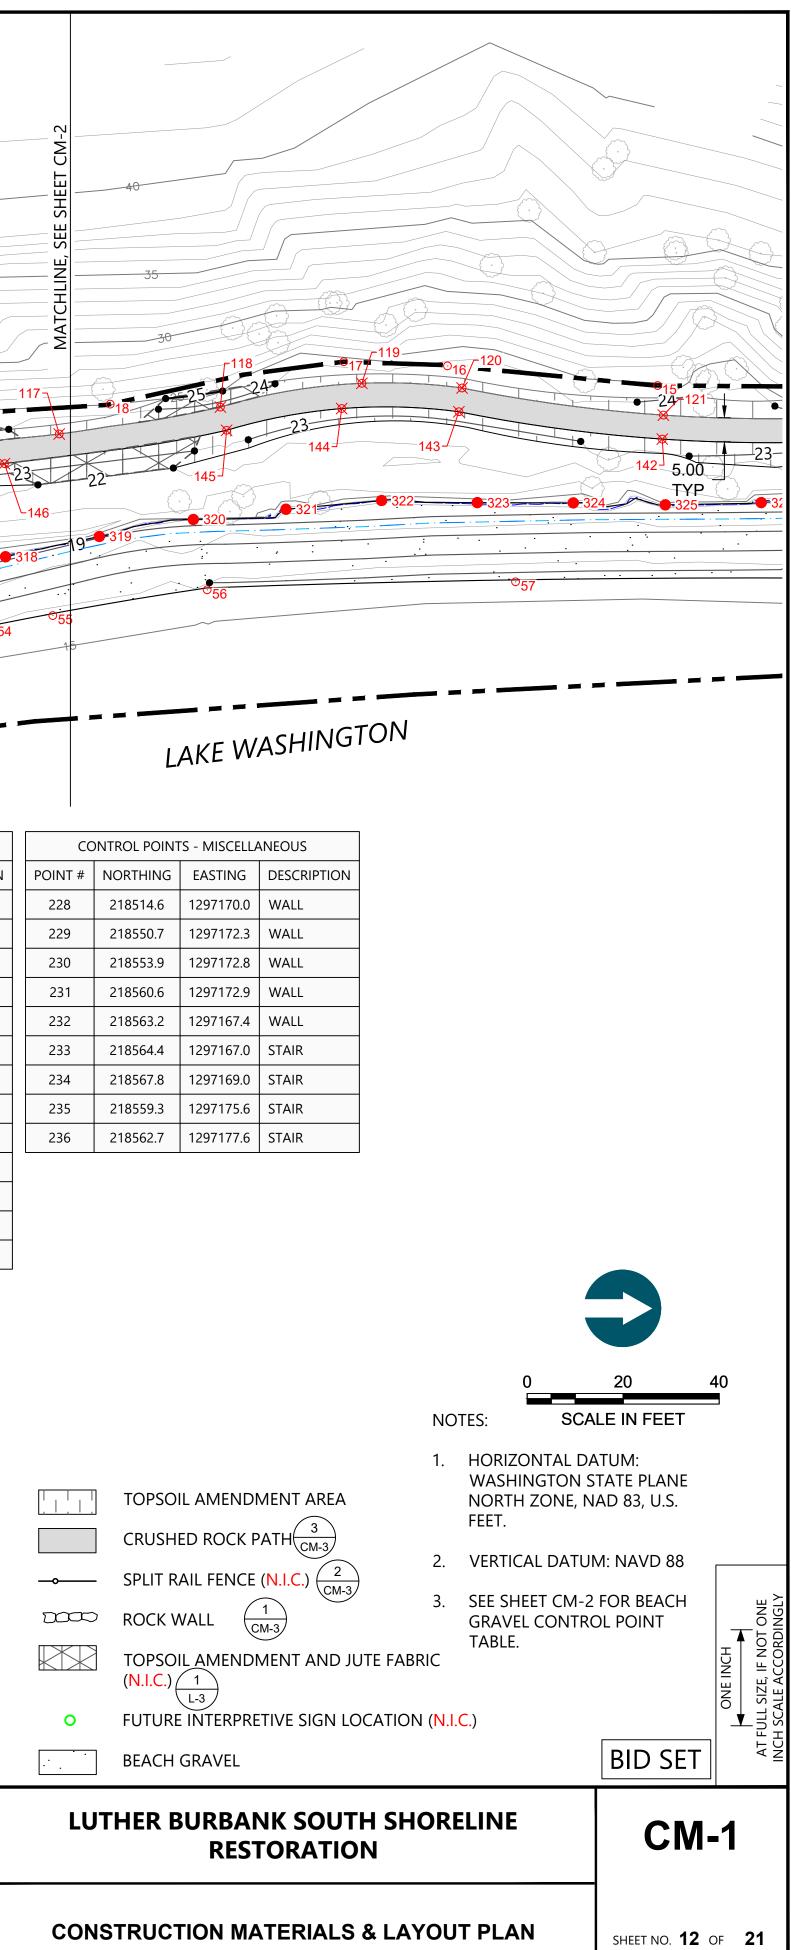
CONTROL POINT (PROJECT LIMITS)

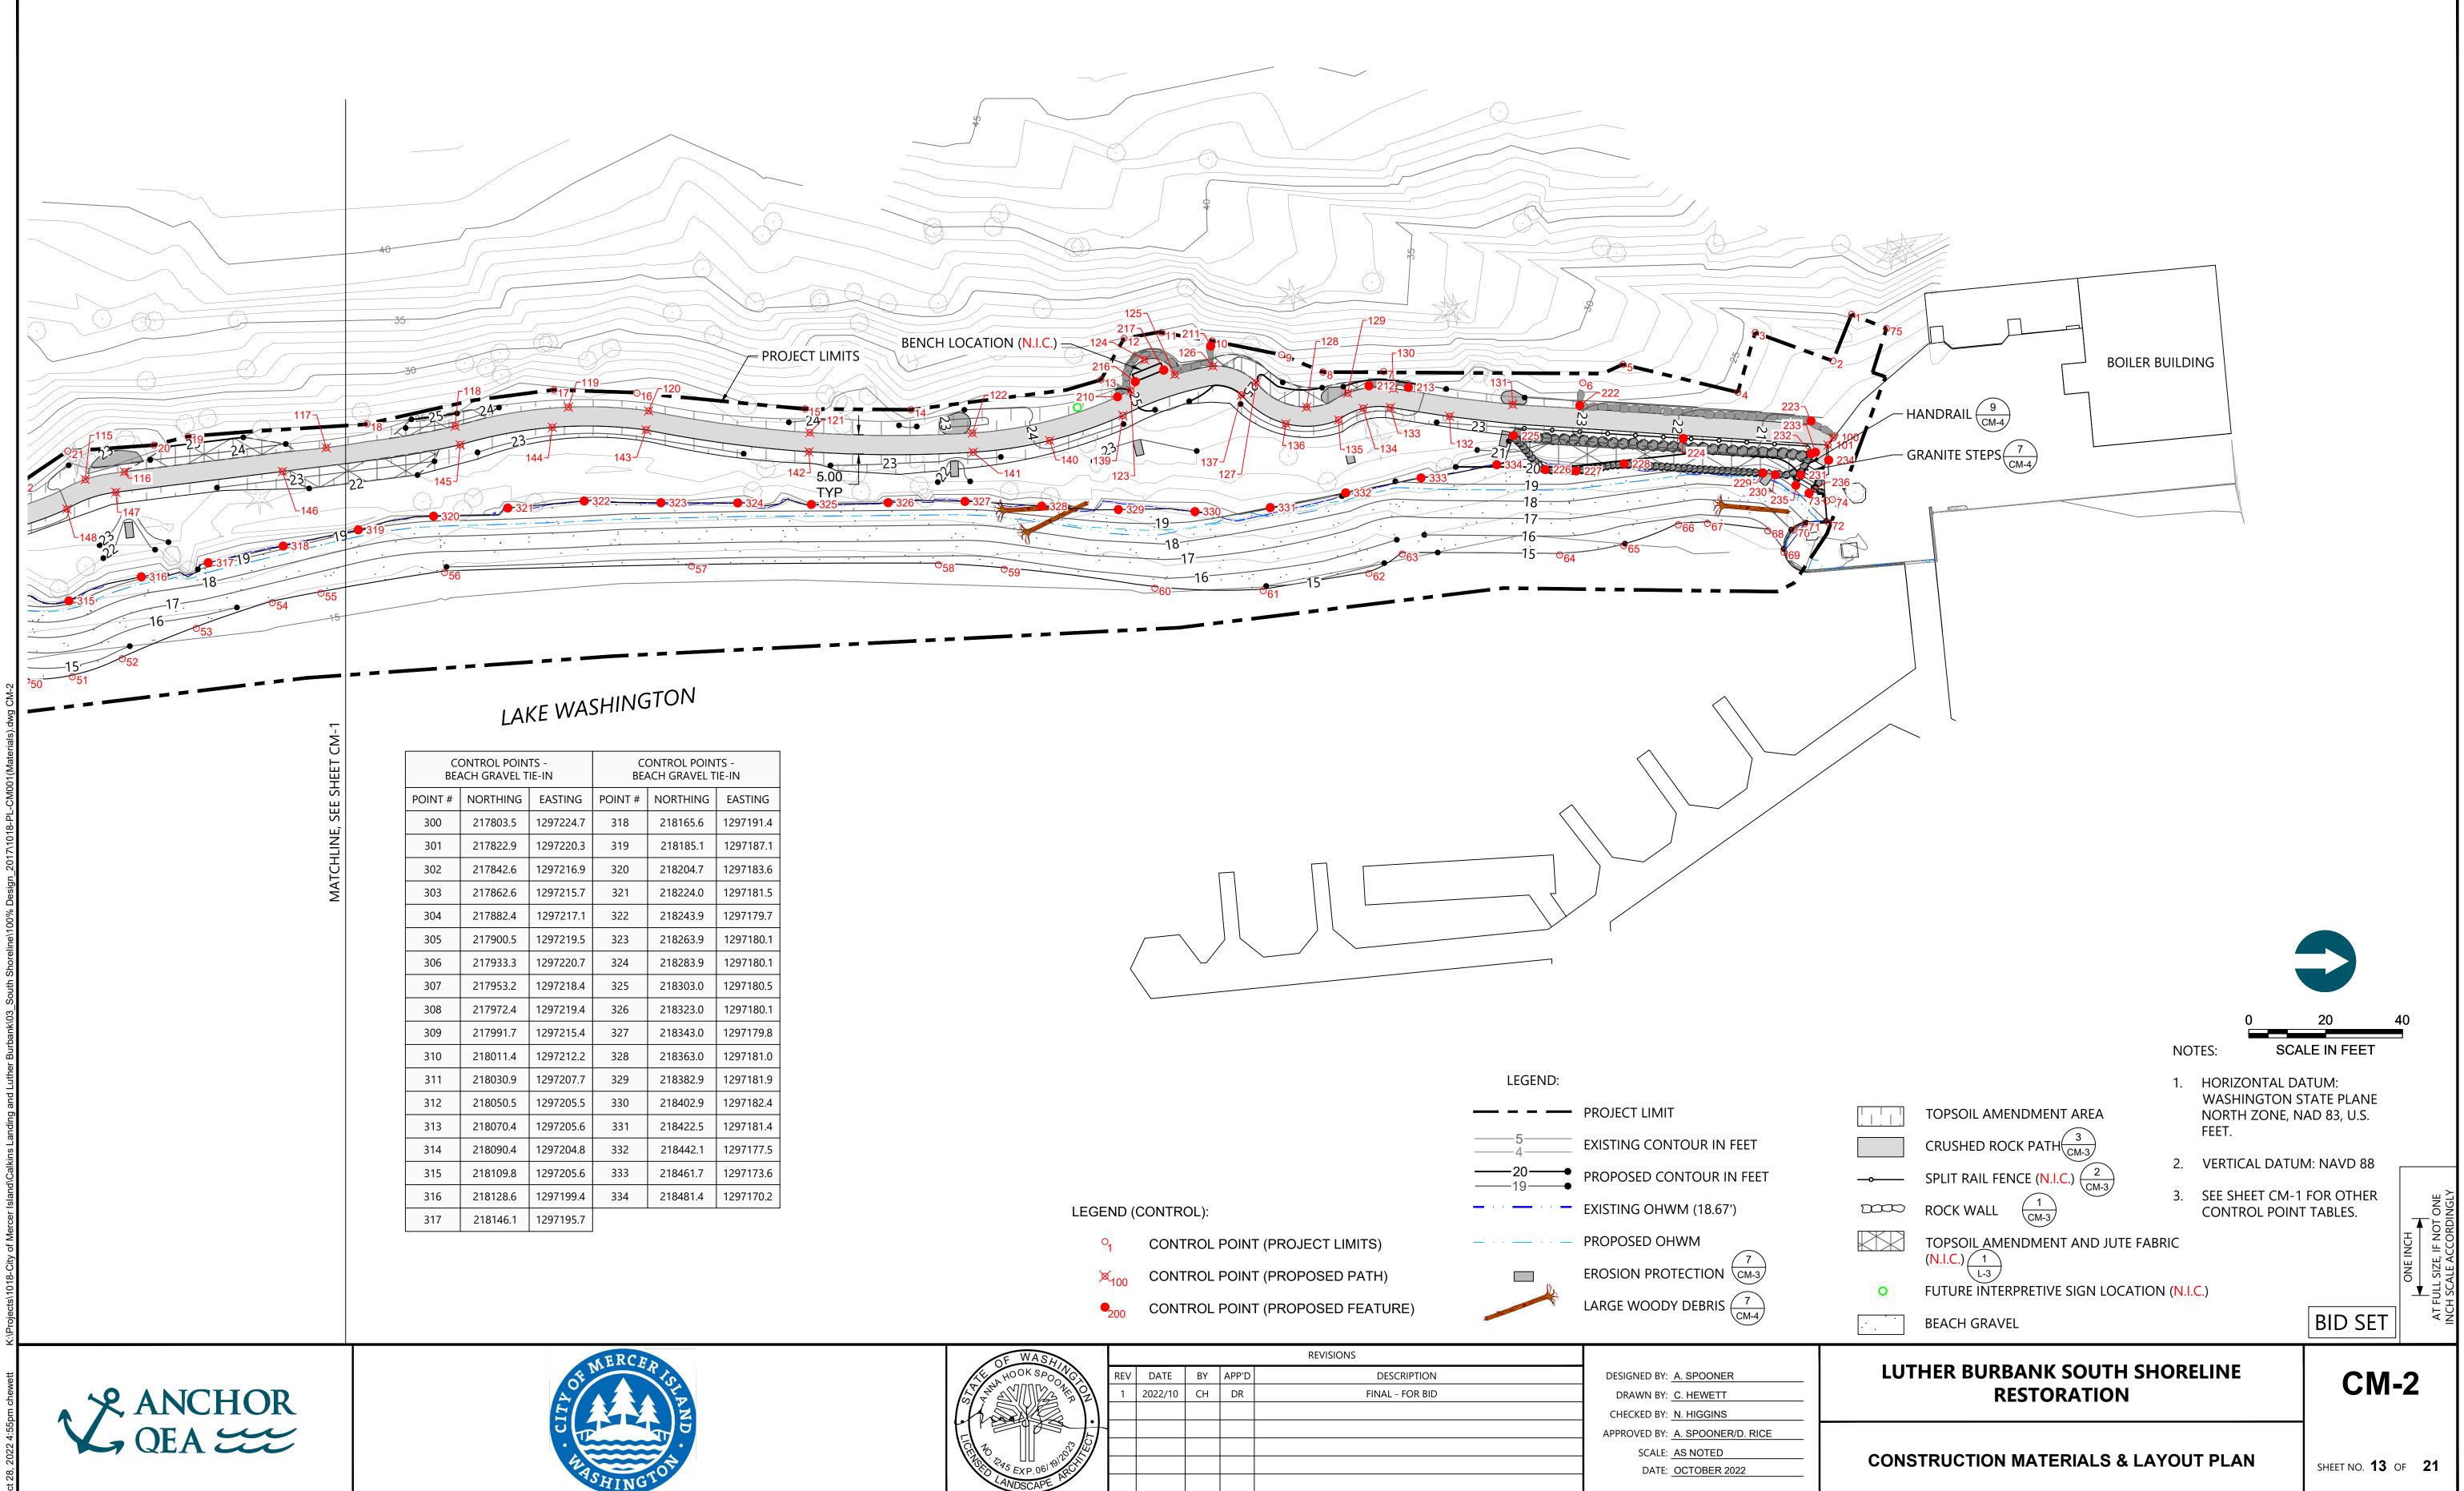
- CONTROL POINT (PROPOSED PATH)
- •200 CONTROL POINT (PROPOSED FEATURE)



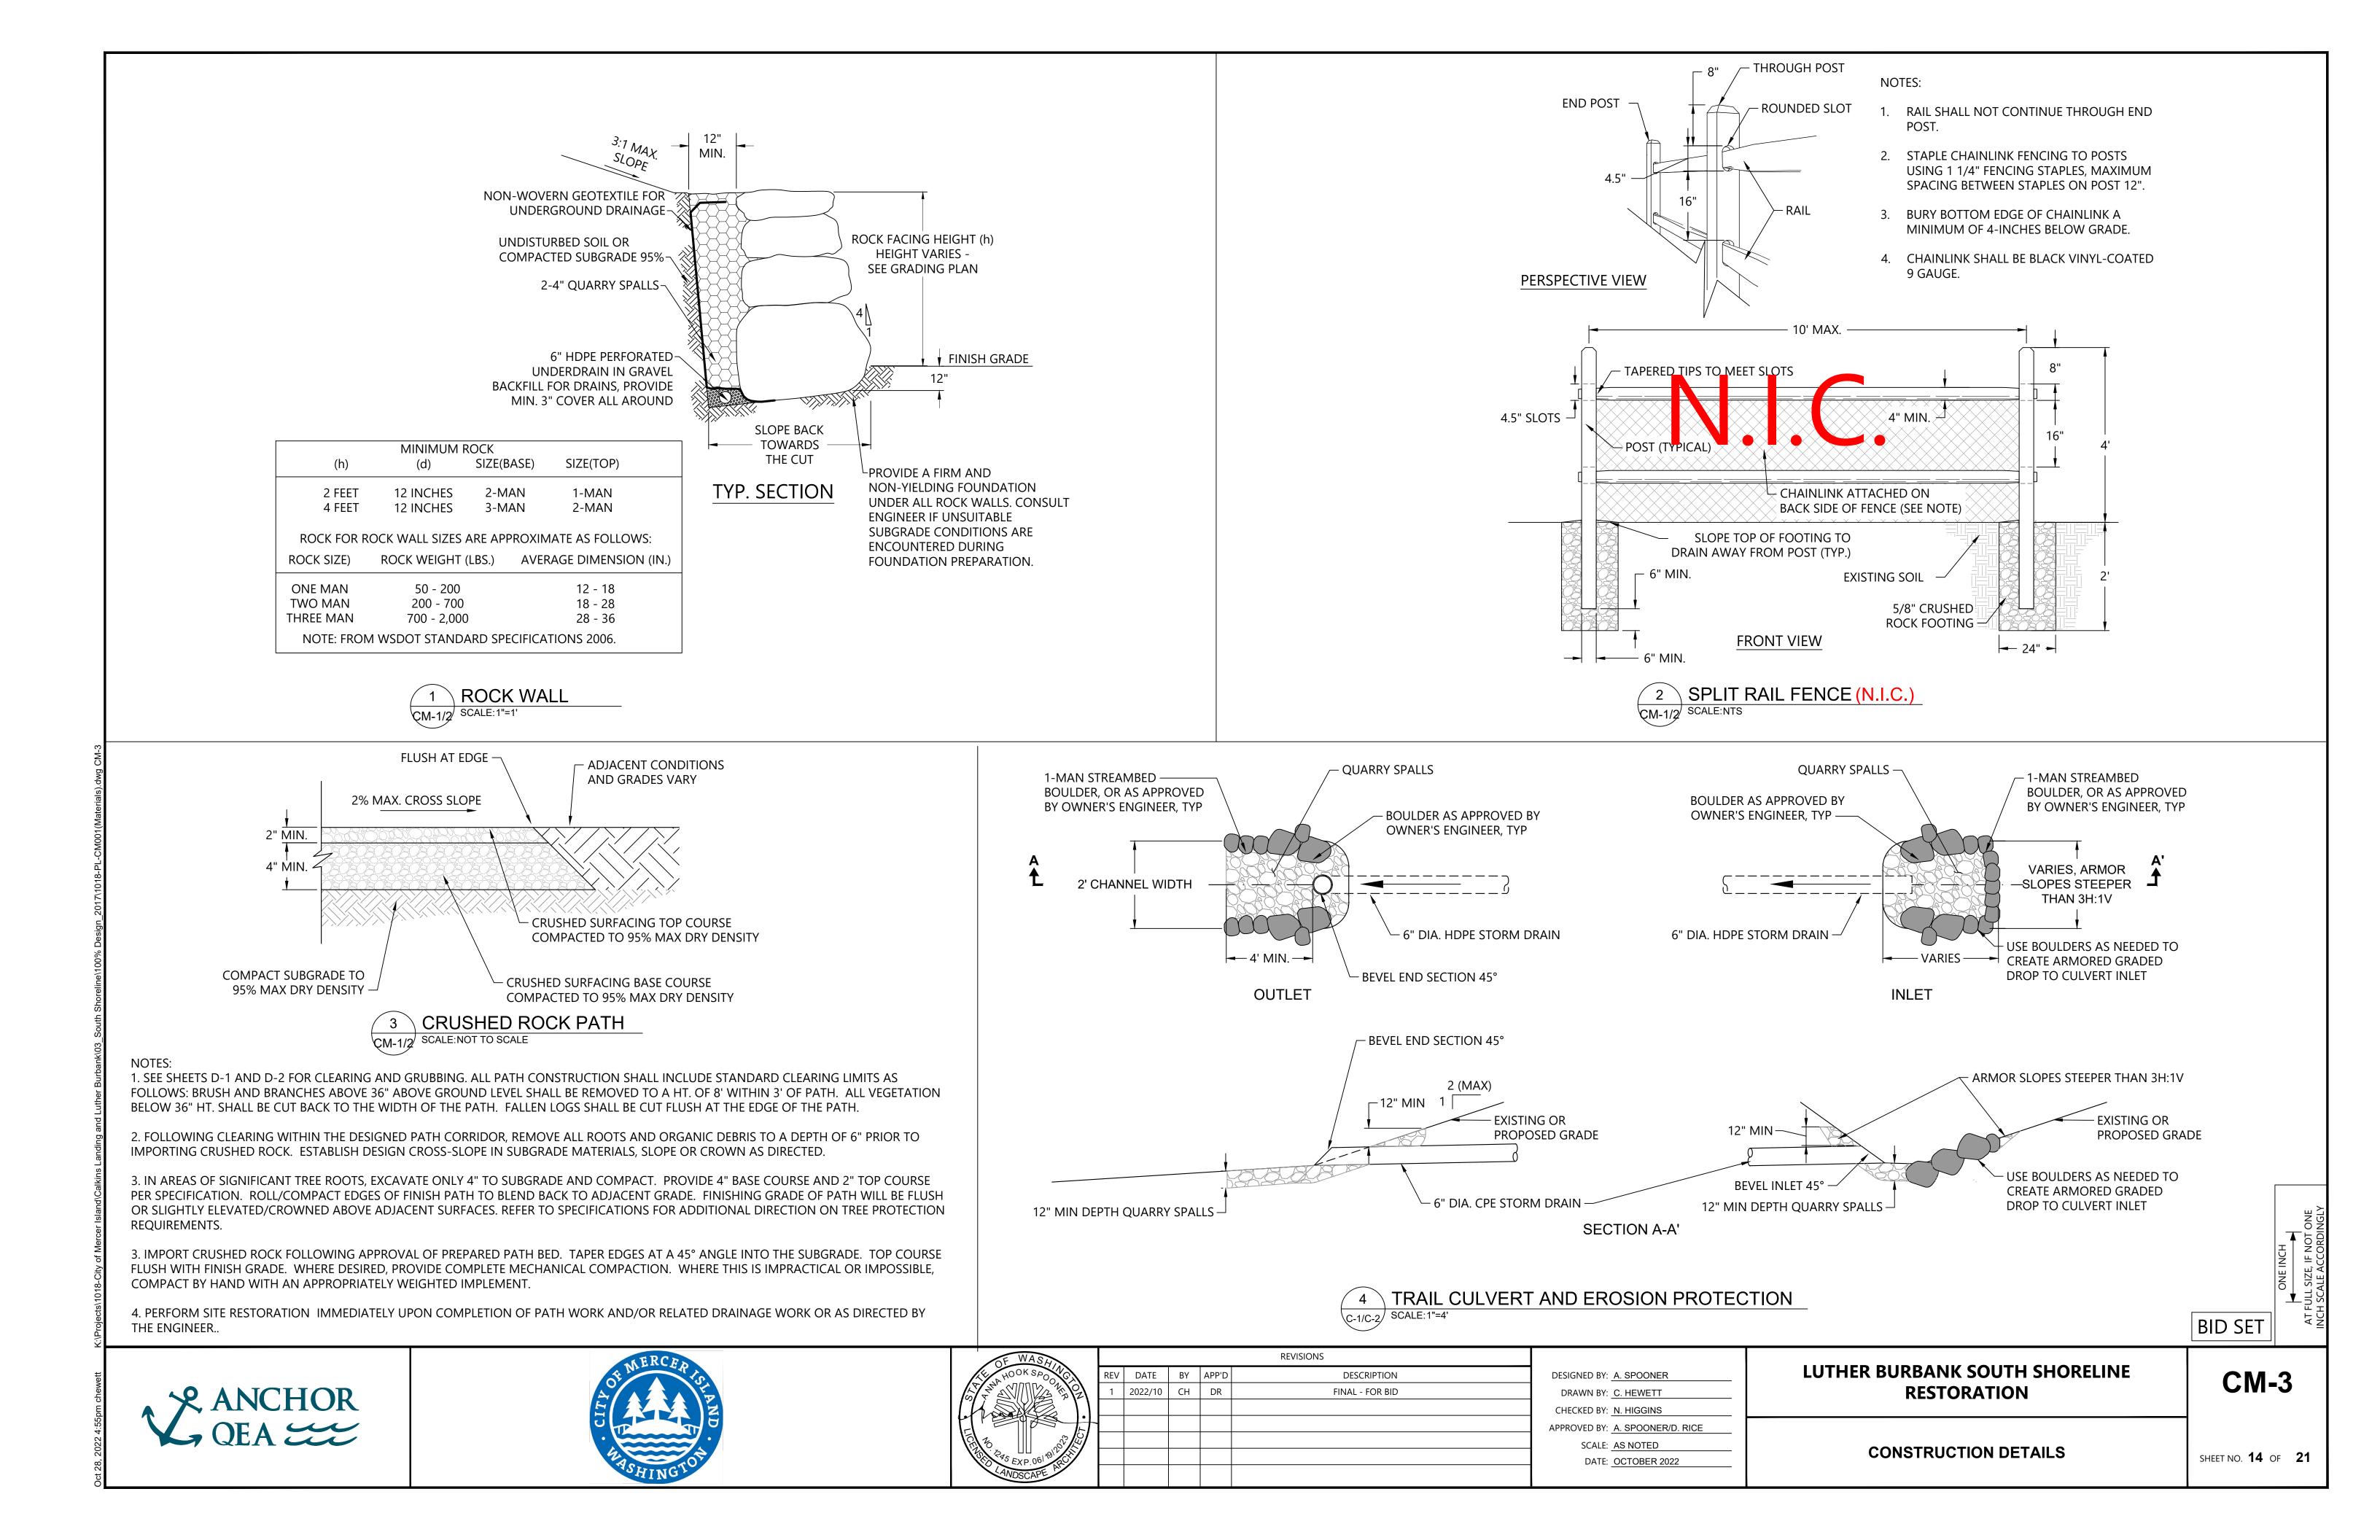


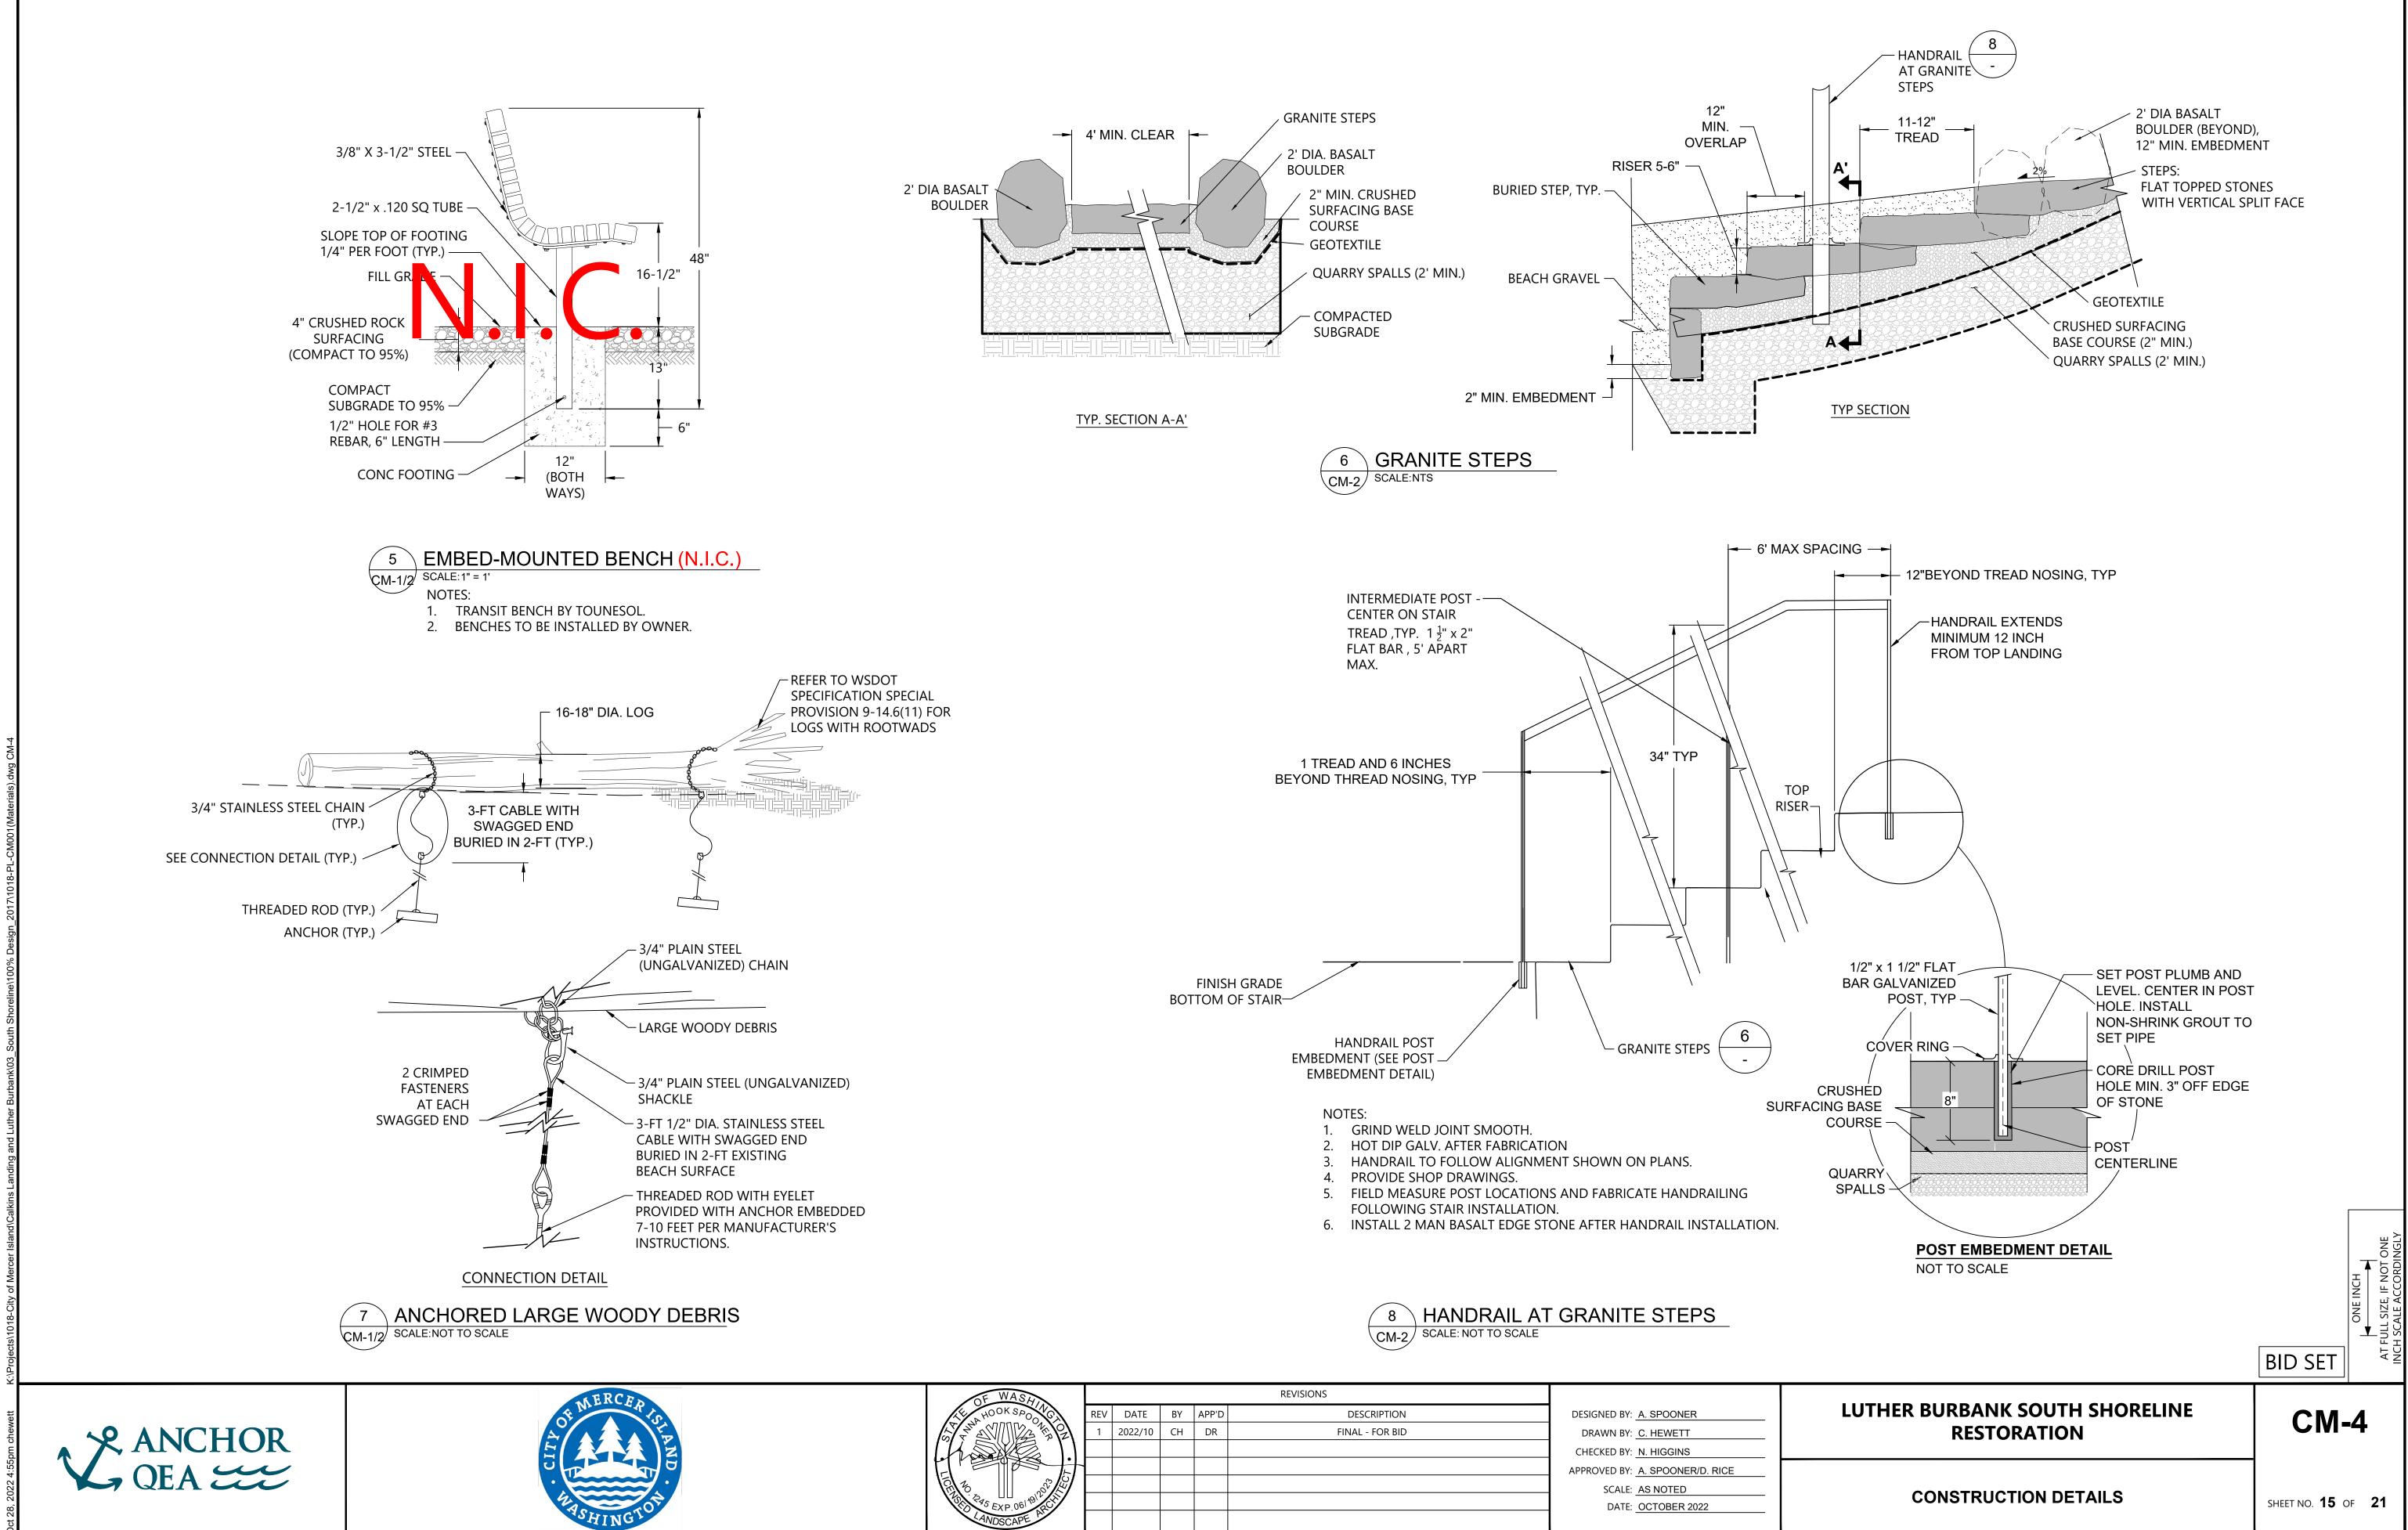
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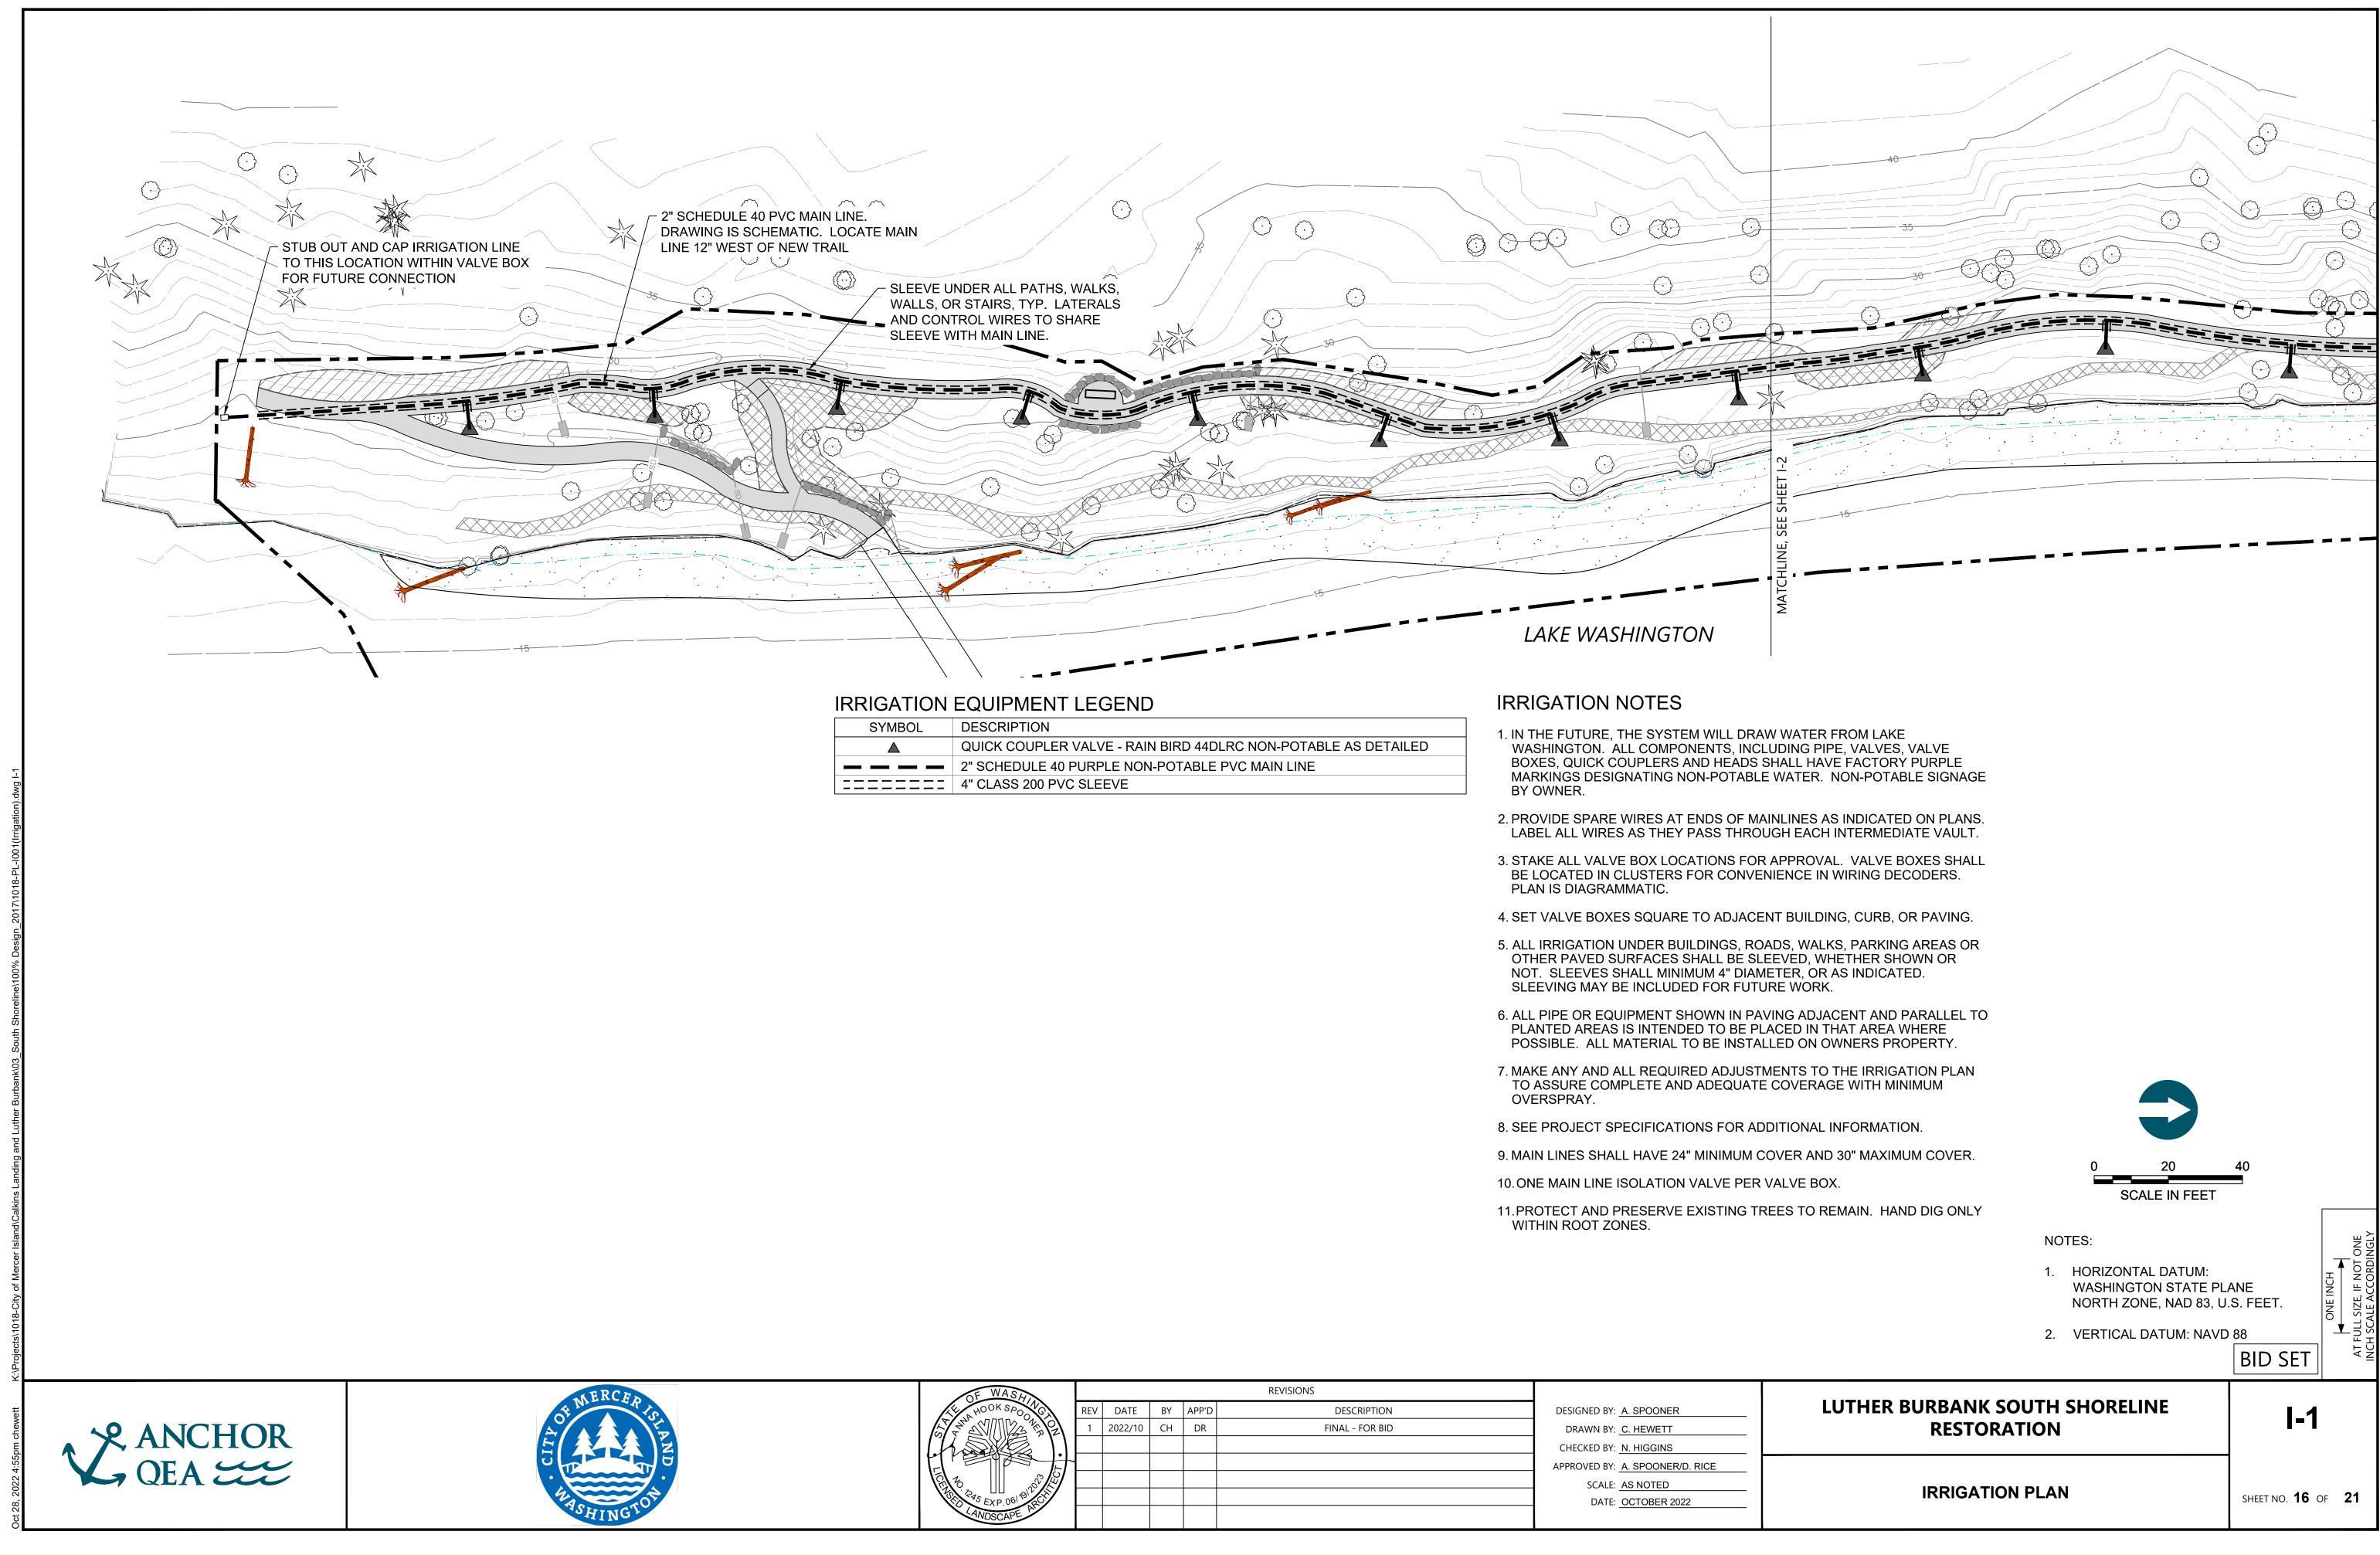


	REV	DATE	BY	APP'D	DESCRIPTION	DESIGNED BY:	A. SPOONER
	1	2022/10	СН	DR	FINAL - FOR BID	DRAWN BY:	C. HEWETT
						CHECKED BY:	N. HIGGINS
						APPROVED BY:	A. SPOONER/D. RICE
						SCALE:	AS NOTED
$\tilde{\mathcal{S}}$						DATE:	OCTOBER 2022



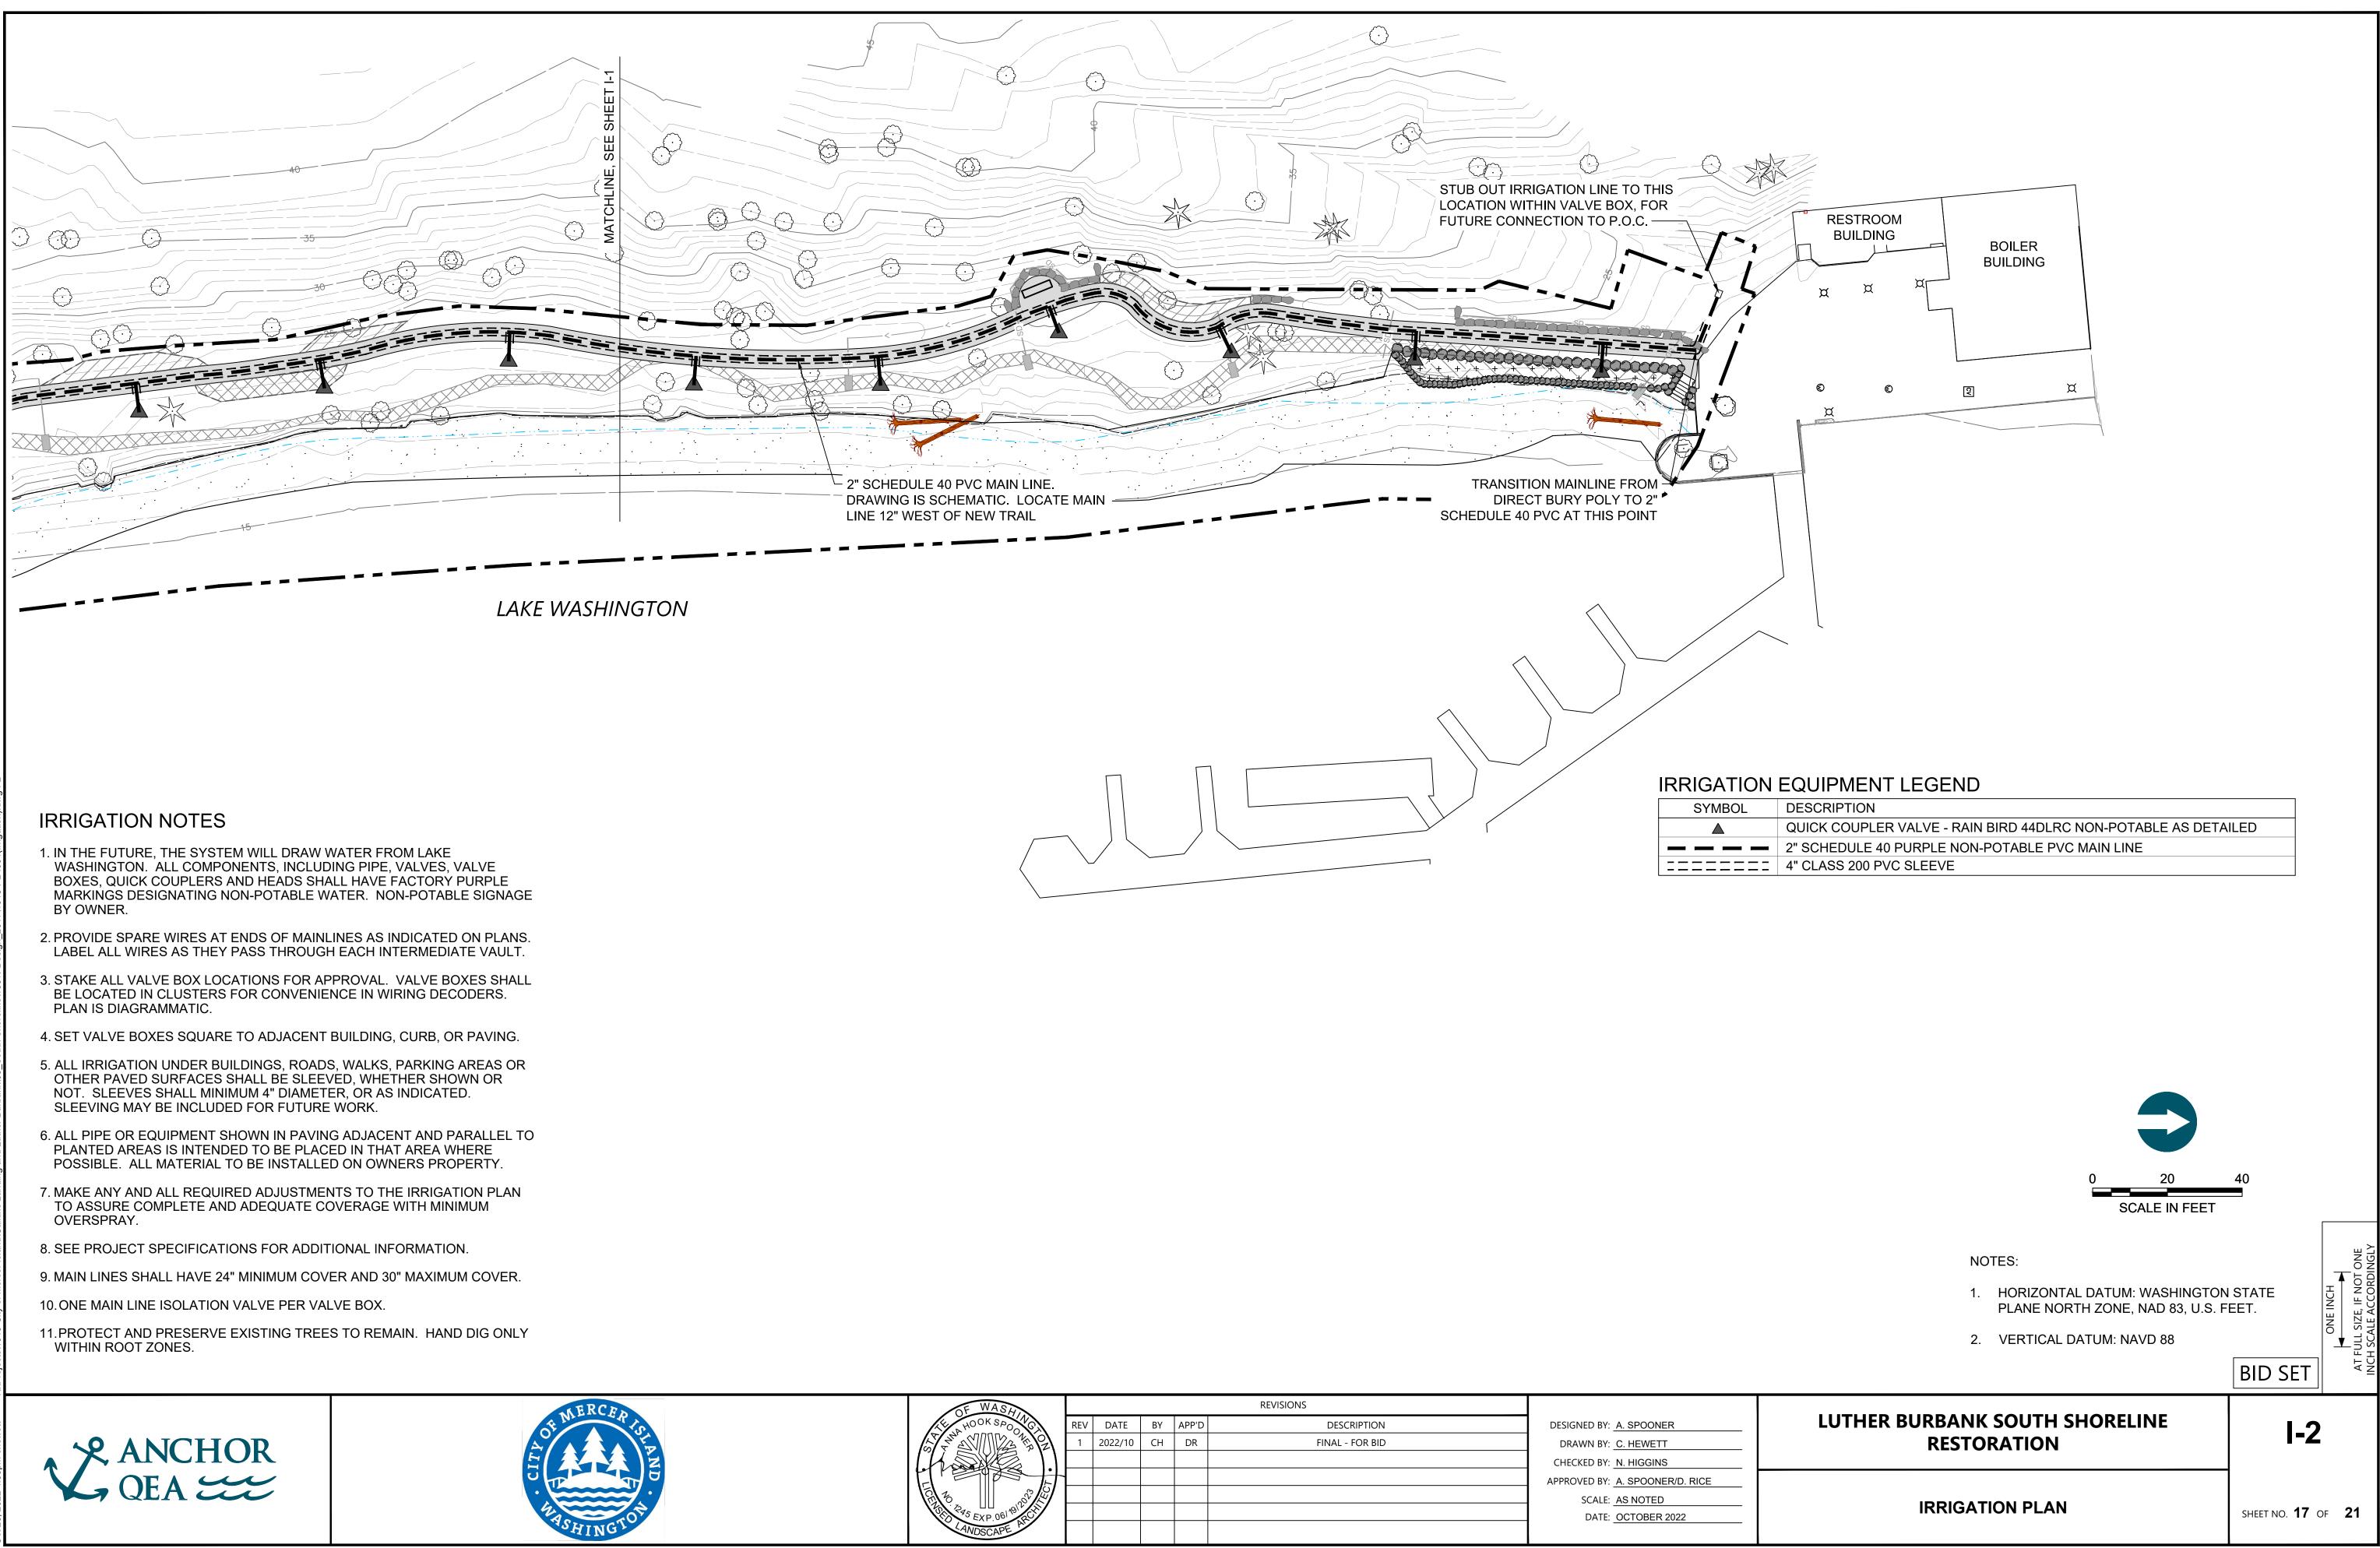


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THE HOOK SPOOL	REV	DATE	ΒY	APP'D	DESCRIPTION	DESIGNED BY: A. SPOONER
	1	2022/10	СН	DR	FINAL - FOR BID	DRAWN BY: <u>C. HEWETT</u>
						CHECKED BY: N. HIGGINS
						APPROVED BY: A. SPOONER/D. RICE
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6 PAS EXP.061 191 PC						DATE: OCTOBER 2022
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SYMBC)L	DESCRIPTION
		QUICK COUPLER VALVE - RAIN BIRD 44DLRC NON-POTABLE AS DETAILED
		2" SCHEDULE 40 PURPLE NON-POTABLE PVC MAIN LINE
=====		4" CLASS 200 PVC SLEEVE

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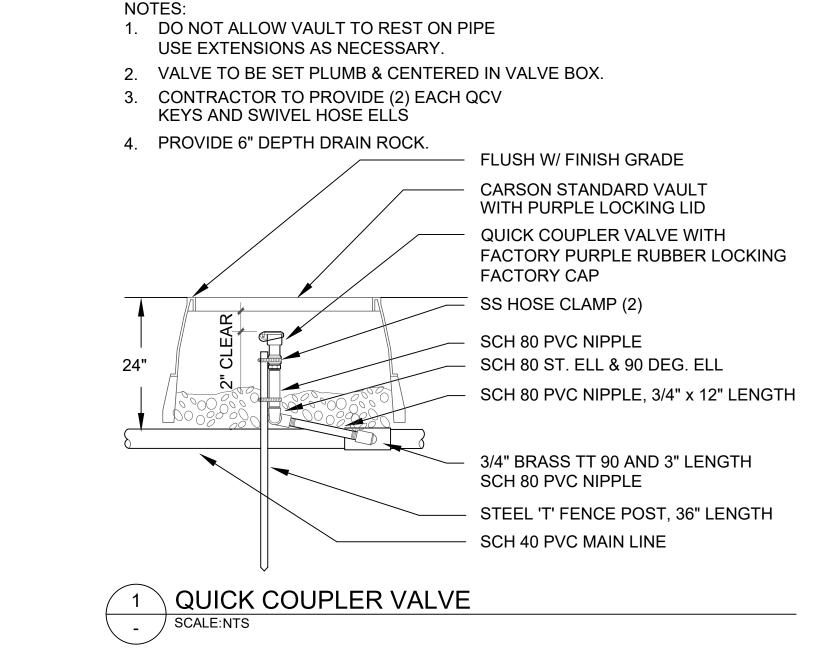


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HOOK SPOOR	REV	DATE	ΒY	APP'D	DESCRIPTION	DESIGNED BY: A. SPOONER
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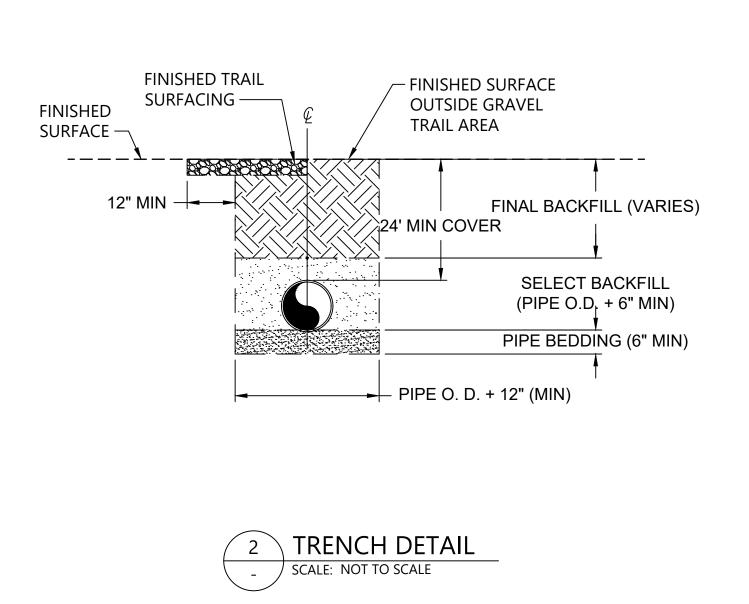








TYPICAL TRENCH NOTES:



- 2.
- OVER THE PIPE.

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HUOK SPOOL	REV	DATE	BY	APP'D	DESCRIPTION	DESIGNED BY: A. SPOONER
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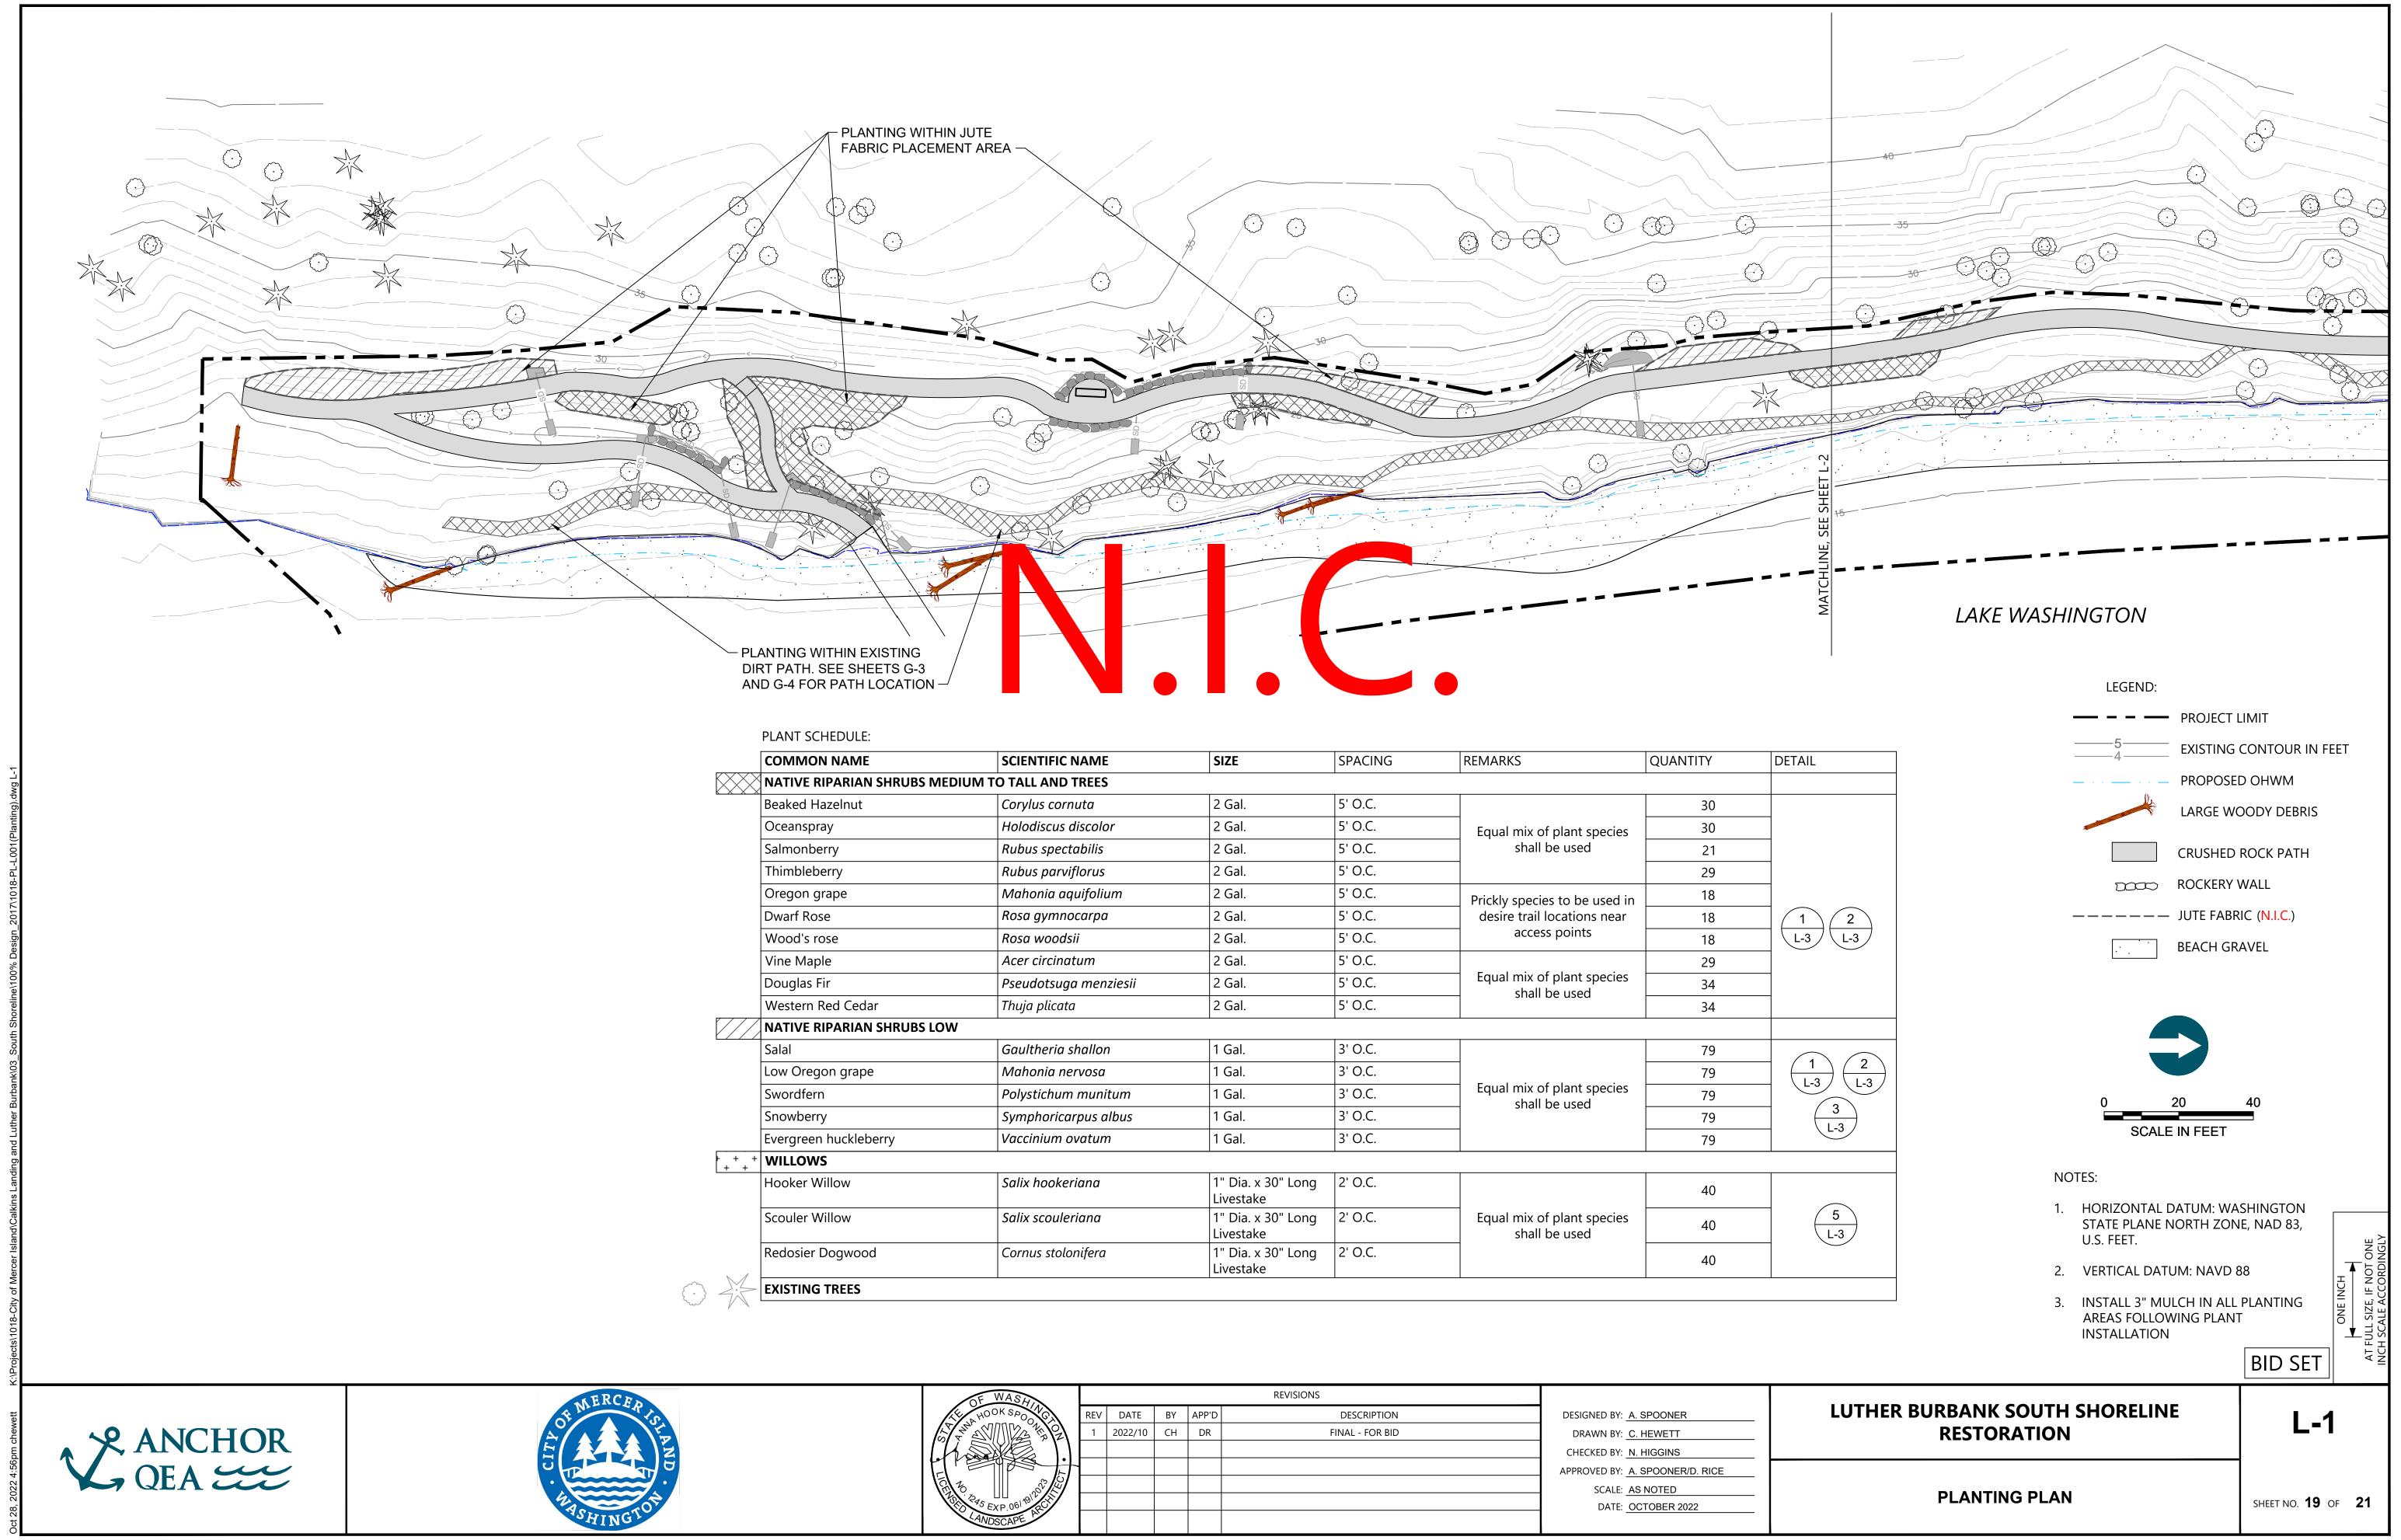
1. PIPE BEDDING - PIPE BEDDING MUST BE AT LEAST 6 INCHES DEEP COMPACTED AND MUST MEET THE REQUIREMENTS OF SECTION 9-03.12(3) OF THE WSDOT "STANDARD SPECIFICATIONS FOR ROAD, BRIDGE, AND MUNICIPAL CONSTRUCTION" (2022 EDITION). IF EXCAVATED TRENCH BOTTOM IS UNSTABLE OR NOT SUITABLE, THE SELLER MUST EXCAVATE TO A DEPTH REQUIRED BY THE COMPANY AND BACKFILL WITH PIPE BEDDING. PLACE PIPE BEDDING IN MAXIMUM 6-INCH LIFTS AND COMPACT TO 95% OF MAXIMUM DRY DENSITY AS DETERMINED BY THE MODIFIED PROCTOR METHOD (ASTM D1557). THE BOTTOM OF THE TRENCH MUST BE FREE OF ROCK AND SMOOTHED TO PREVENT BRIDGING.

SELECT BACKFILL - SELECT BACKFILL MUST ALSO MEET THE REQUIREMENTS OF SECTION 9-03.12(3) OF THE WSDOT "STANDARD SPECIFICATIONS FOR ROAD, BRIDGE, AND MUNICIPAL CONSTRUCTION" (2022 EDITION). PLACE SELECT BACKFILL IN 6-INCH LIFTS TO A MINIMUM DEPTH OF 6 INCHES ABOVE THE CROWN OF THE PIPE AND COMPACT TO 95% OF MAXIMUM DRY DENSITY AS DETERMINED BY THE MODIFIED PROCTOR METHOD (ASTM D1557).

3. FINAL BACKFILL - THE CONTRACTOR MUST BACKFILL THE REMAINING PORTION OF THE TRENCH TO THE LINES AND GRADES SHOWN WITH EXCAVATED NATIVE MATERIAL OR IMPORTED MATERIAL THAT HAS A MAXIMUM PARTICLE SIZE OF 3 INCHES AND IS FREE FROM DEBRIS AND ORGANIC MATERIAL. THE BACKFILL MUST BE WELL DRAINED AND SUITABLE FOR PLACEMENT AND COMPACTION. FOR PIPELINES UNDER GRAVEL TRAIL AREAS, PLACE BACKFILL IN MAXIMUM 6-INCH LOOSE LIFTS AND COMPACT TO 95% OF MAXIMUM DRY DENSITY AS DETERMINED BY THE MODIFIED PROCTOR METHOD (ASTM D1557). FOR OTHER PIPELINES, PLACE BACKFILL IN MAXIMUM 6-INCH LOOSE LIFTS AND COMPACT TO 90% OF MAXIMUM DRY DENSITY AS DETERMINED BY THE MODIFIED PROCTOR METHOD (ASTM D1557). THE AREA DIRECTLY OVER THE PIPE MUST NOT BE MECHANICALLY COMPACTED UNTIL THERE IS A MINIMUM OF 12" OF COVER

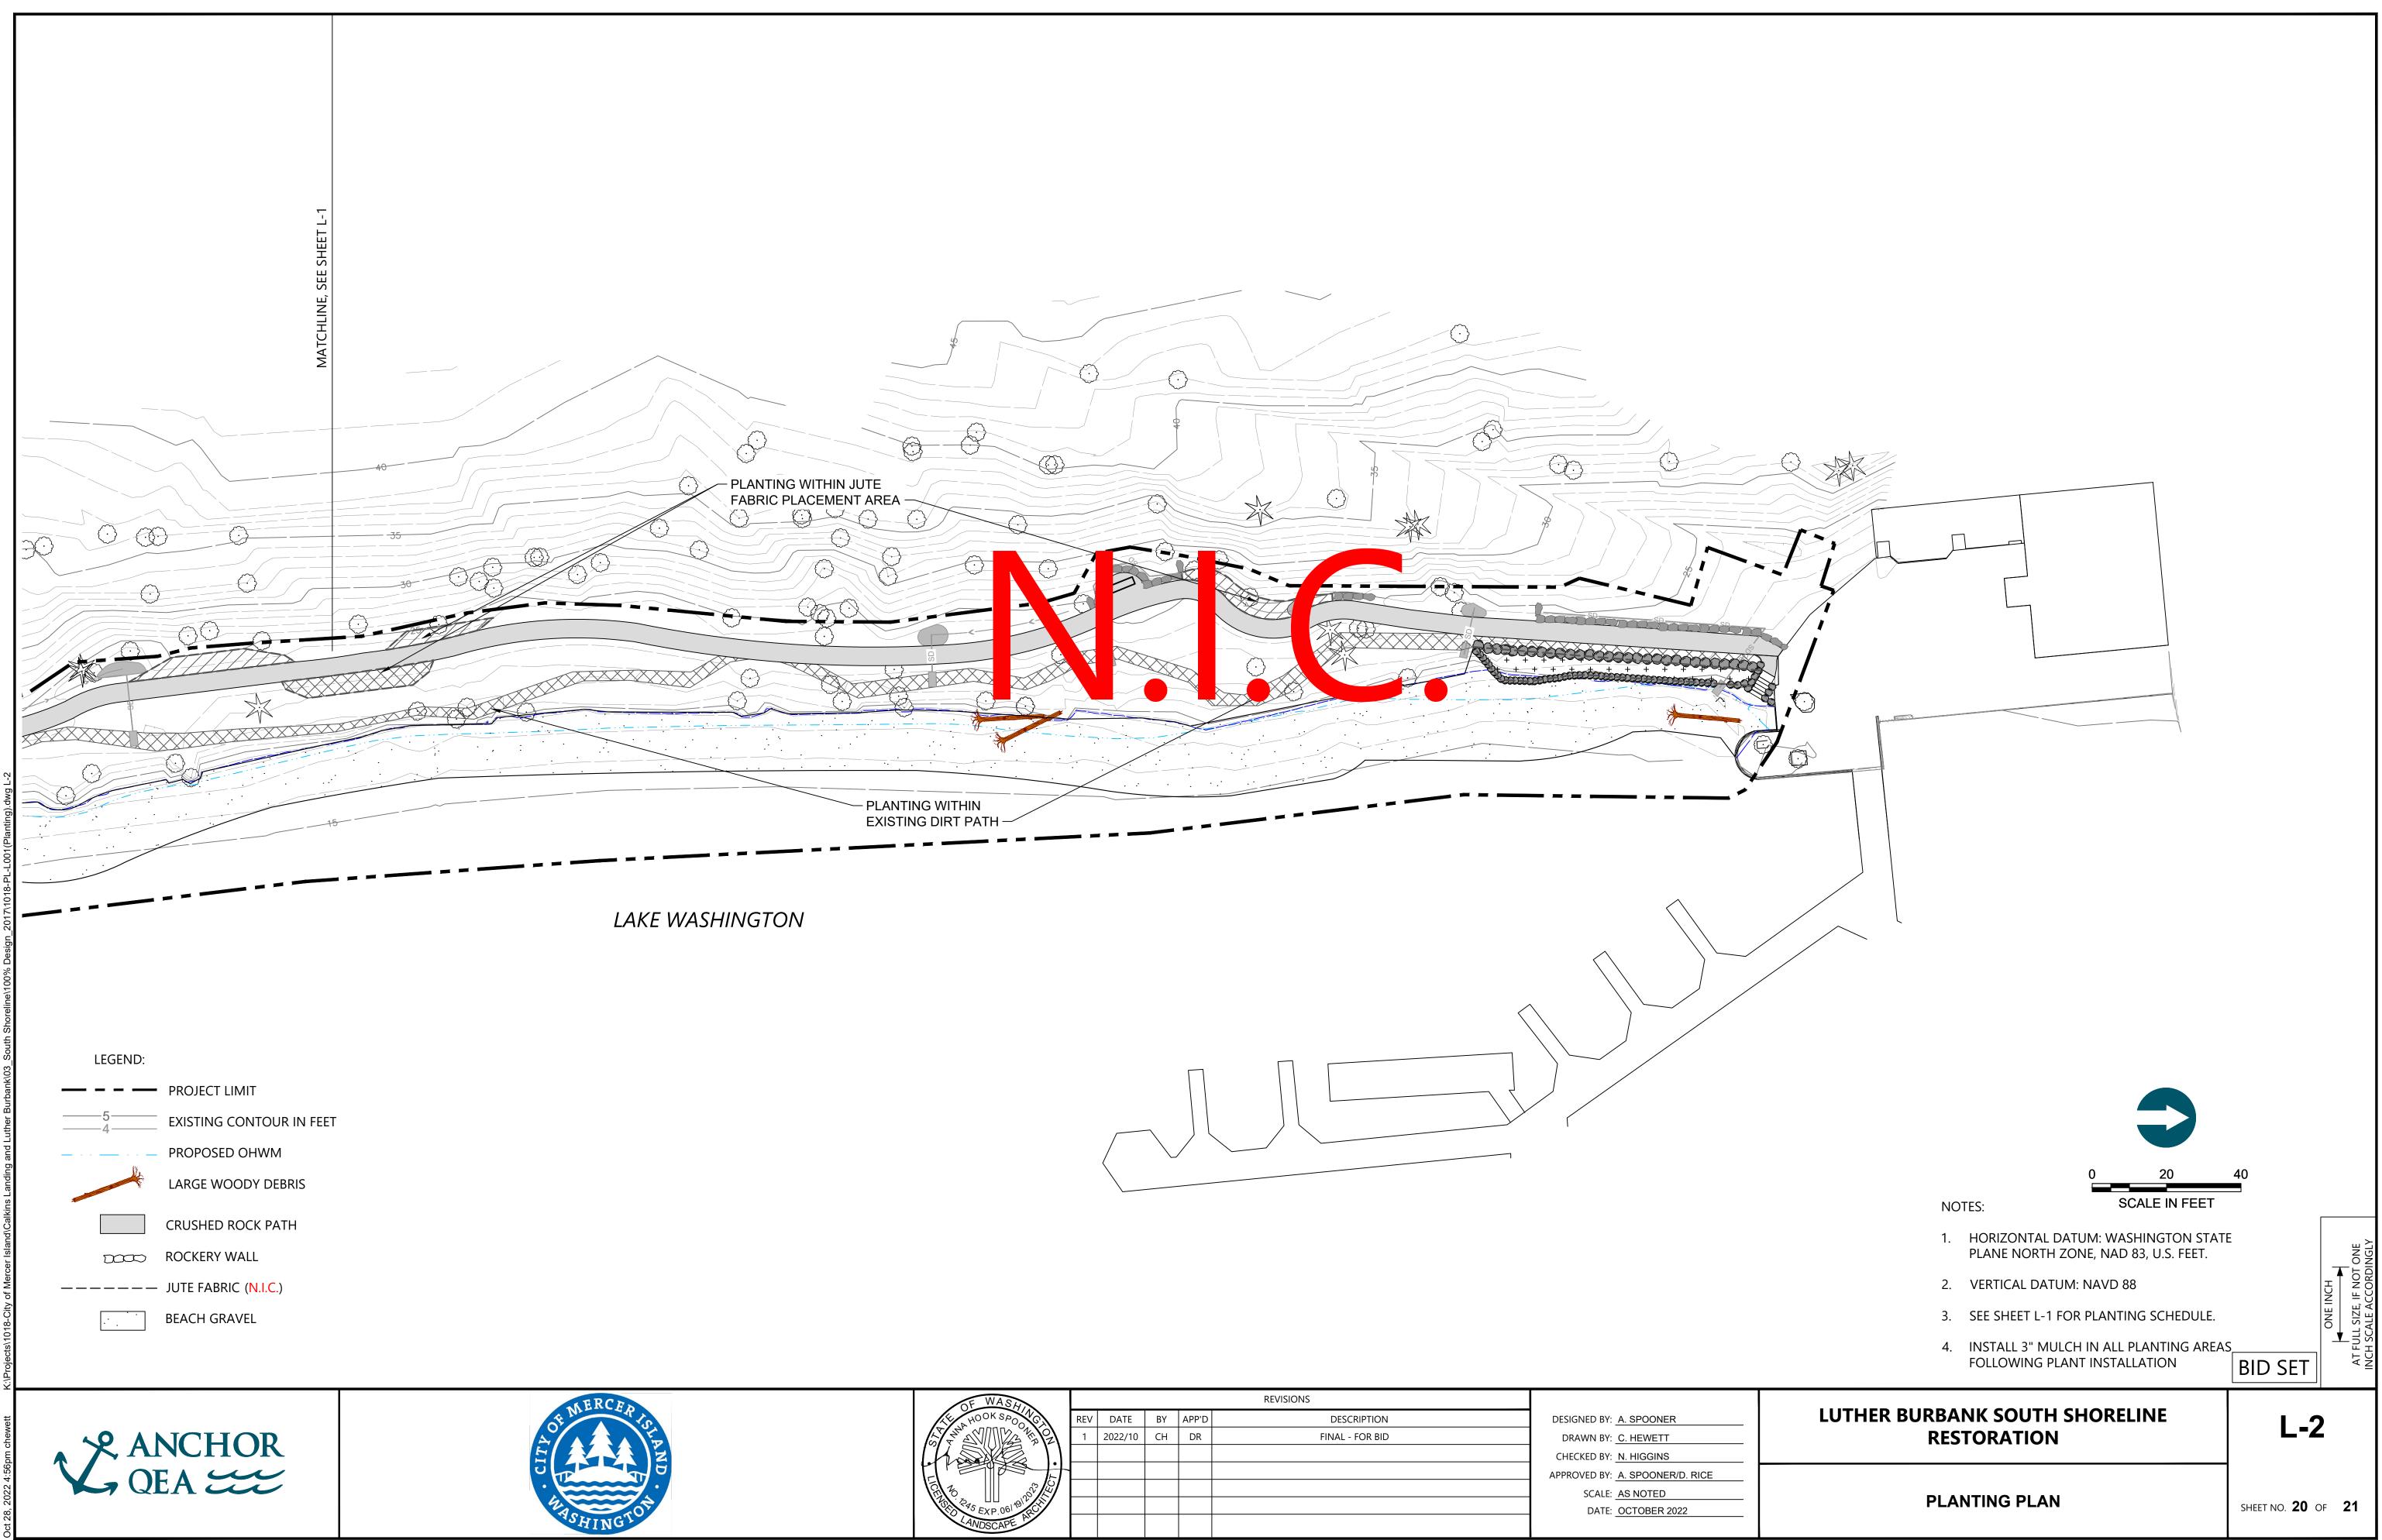
4. EXISTING SOIL CONDITIONS - NO SUBSURFACE EXPLORATION HAS BEEN DONE ALONG THE ALIGNMENT OF THE PROPOSED PIPELINES. THE CONTRACTOR IS RESPONSIBLE FOR ASSESSING EXISTING SOIL CONDITIONS BEFORE TRENCH EXCAVATION. THE CONTRACTOR'S ATTENTION IS CALLED TO THE POTENTIAL FOR ENCOUNTERING COBBLES AND BOULDERS IN THE EXISTING SOIL

IRRIGATION DETAILS	SHEET NO. 18 (DF 21
LUTHER BURBANK SOUTH SHORELINE RESTORATION	I-3	
	BID SET	ONE INCH AT FULL SIZE, IF NOT ONE INCH SCALE ACCORDINGLY

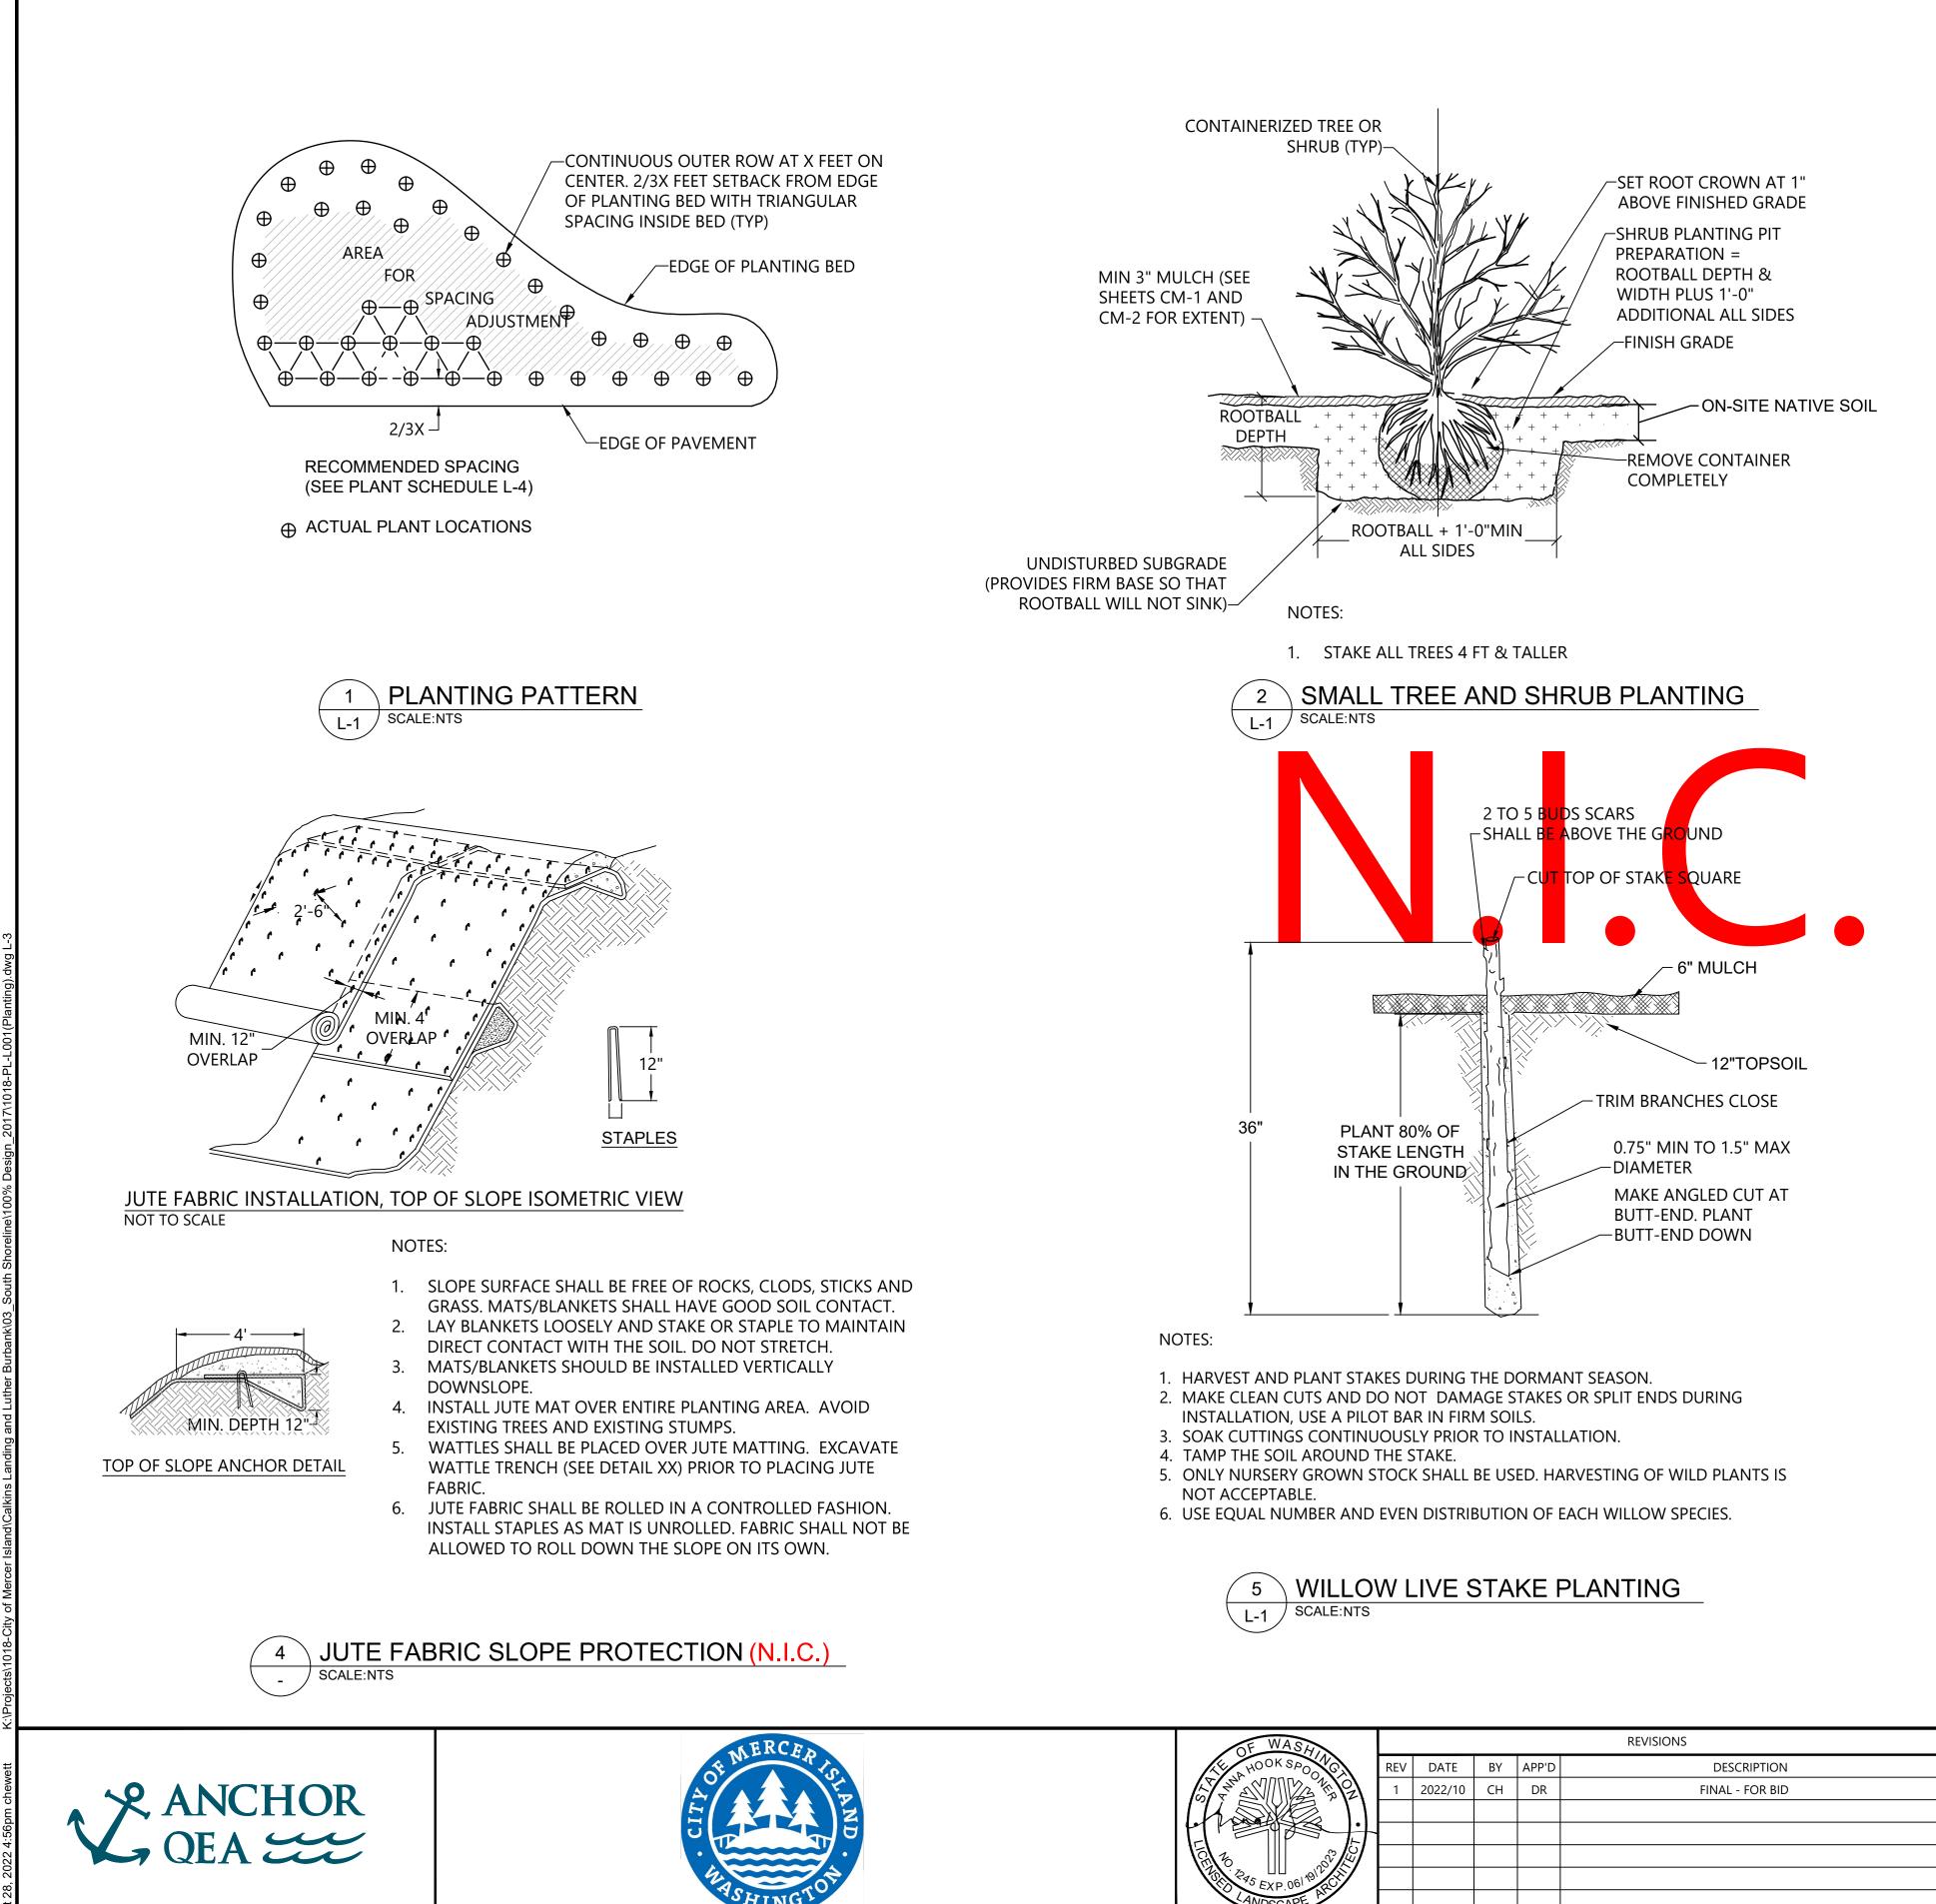


DULE:						
NAME	SCIENTIFIC NAME	SIZE	SPACING	REMARKS	QUANTITY	D
ARIAN SHRUBS ME	DIUM TO TALL AND TREES					
elnut	Corylus cornuta	2 Gal.	5' O.C.		30	
	Holodiscus discolor	2 Gal.	5' O.C.	Equal mix of plant species	30	
/	Rubus spectabilis	2 Gal.	5' O.C.	shall be used	21	
у	Rubus parviflorus	2 Gal.	5' O.C.		29	
be	Mahonia aquifolium	2 Gal.	5' O.C.	Prickly species to be used in	18	
	Rosa gymnocarpa	2 Gal.	5' O.C.	desire trail locations near	18	
9	Rosa woodsii	2 Gal.	5' O.C.	access points	18	
	Acer circinatum	2 Gal.	5' O.C.		29	
	Pseudotsuga menziesii	2 Gal.	5' O.C.	Equal mix of plant species	34	
d Cedar	Thuja plicata	2 Gal.	5' O.C.	shall be used	34	
ARIAN SHRUBS LOV	N					
	Gaultheria shallon	1 Gal.	3' O.C.		79	
grape	Mahonia nervosa	1 Gal.	3' O.C.		79	
	Polystichum munitum	1 Gal.	3' O.C.	Equal mix of plant species shall be used	79	
	Symphoricarpus albus	1 Gal.	3' O.C.	Shall be used	79	
uckleberry	Vaccinium ovatum	1 Gal.	3' O.C.		79	
ж	Salix hookeriana	1" Dia. x 30" Long Livestake	2' O.C.		40	
ow	Salix scouleriana	1" Dia. x 30" Long Livestake	2' O.C.	Equal mix of plant species shall be used	40	
gwood	Cornus stolonifera	1" Dia. x 30" Long Livestake	2' O.C.		40	
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KEL HOOK SPOOL	REV	DATE	BY	APP'D	DESCRIPTION	DESIGNED BY: <u>A. SPOONER</u>	
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						CHECKED BY: N. HIGGINS	
						APPROVED BY: <u>A. SPOONER/D. RICE</u>	
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